

**CITY OF WEST DES MOINES  
PLAN AND ZONING COMMISSION COMMUNICATION**

**Meeting Date:** September 9, 2019

**Item:** Courtyards at King's Landing – Northeast corner of S. 100th Street and Stagecoach Drive – Approval of a Site Plan to develop a 79 lot detached townhome development – Caliber Iowa LLC. – SP-004323-2019

**Requested Action:** Recommend Approval of Site Plan

**Case Advisor:** J. Bradley Munford 

**Applicant's Request:** Eric Cannon of Snyder and Associates, on behalf of the applicant, Caliber Iowa, LLC. and with permission of the property owner, Sugar Creek Estates, LLC. is requesting approval of a site plan to develop a 79 lot detached townhome development.

**History:** The property was annexed into the City in 2002 as a part of the Mills Civic Parkway Annexation. The Medium Density Comprehensive Plan designation was established in September of 2010. On April 15, 2019 the City Council approved a zoning request to consistency zone the property as Residential Medium Density (RM-8). On August 5, 2019 the City Council approved a 79 footprint lot Preliminary Plat.

**City Council Subcommittee:** The Courtyards at King's Landing (fka Courtyards at Sugar Creek) was presented to Development and Planning Subcommittee as an informational item at the May 20, 2019 meeting. The Subcommittee was supportive of the development.

**Staff Review and Comment:** This request was distributed to other City departments and other agencies for their review and comment. Staff would note the following:

- **Architecture:** The applicant has worked with staff on building designs methods that provide varied facades and articulations to provide visual interest to the development. These methods include carrying the details and materials from the front elevation around to the side and rear elevations that will be in public view to provide this visual interest to pedestrians. Staff notes that public view elevations will not be a requirement for the home products that are adjacent to another unit and not visible from the street. A site layout plan with a markup of the location of the public view elevations for the townhomes and the row homes is included with the building elevations in Attachment D. It should be noted that as a part of the public view site layout plan, the applicant has agreed that Lots 14, 24, 34, 61, 62 and 76, will have their courtyard elevation as the public view.
- **Prior Conditions of approval:** During the approval of the Preliminary plat (PP-004322-2019, August 12, 2019) several conditions of approval were added concerning temporary street access from Stagecoach Drive, public access easements, and sanitary sewer fees. At this time, the conditions have not been met. As a part of this approval, Staff have added the stipulations from the preliminary plat in an effort to keep a consistent record of what needs to be completed.
- **Clubhouse Parking:** The applicant has specified that the clubhouse will be a private resident only clubhouse where it is used for HOA meetings and private functions for the residents. Under code, clubhouses are considered assembly spaces and require 20 spaces per 1,000 square feet of useable assembly area. The proposed clubhouse has 1,616 square feet of useable assembly area and requires 32 parking spaces. The applicant is only proposing 15 spaces and is requesting that the City Council allow defer construction of 17 parking spaces until the remainder are deemed necessary by the City Council. The reason behind the applicant's request is this is based on their experience with similar developments in other communities. Given that similar

deferrals have been granted for private resident only clubhouses, Staff is comfortable with the request, but recommends the following condition:

*The City Council deferring the installation of up to 17 parking stalls of the 32 required by Code until such time that parking on non-designated parking areas or parking off-site occurs due to the lack of available parking stalls. At that time, the City reserves the right to provide the applicant notice to increase the number of parking stalls. The applicant will be required to provide the additional parking spaces in accordance with City regulations within the first available construction season. Should the implementation of additional parking be needed, the applicant shall construct them in compliance with the plans submitted with this Site Plan that identifies the location and engineering details for the stalls to be constructed.*

**Comprehensive Plan Consistency:** The project has been reviewed for consistency with the Comprehensive Plan. Based upon that review, a finding has been made that the proposed project is consistent with the Comprehensive Plan in that the project is consistent with all of the goals and policies of the Comprehensive Plan and the land use map of the Comprehensive Plan.

**Site Plan Findings:** This proposed project was distributed to various city departments for review and comment. Based upon that review, the following findings have been made on the proposed project:

1. The proposed development and use is consistent with the West Des Moines Comprehensive Plan in that the project has been reviewed for consistency with the Comprehensive Plan. Based upon that review, a finding has been made that the proposed project is consistent with the Comprehensive Plan in that the project is consistent with all of the goals and policies of the Comprehensive Plan.
2. The proposed development and use does assure compatibility of property uses within the zone and general area in that this project was reviewed by various City Departments for compliance with the Zoning Ordinance.
3. All applicable standards and conditions have been imposed which protects the public health, safety and welfare in that this project was reviewed by various City Departments and public agencies for compliance with the various state and local regulations. Based upon that review a finding is made that the project has been adequately conditioned to protect the health, welfare and safety of the community.
4. There is adequate on-site and off-site public infrastructure to support the proposed development in that this project was reviewed by various public agencies and City Departments and public utilities to ensure that either the petitioner will construct or the project has been conditioned to construct adequate public infrastructure to serve the development.
5. The proposed development and use has met the requirements contained in the City Code in that this project was reviewed by various City Departments and the project has complied with or has been conditioned to comply with all City Code requirements.
6. The proposed development and use is in keeping with the scale and nature of the surrounding neighborhood in that the proposed project is consistent with the zoning designation and Comprehensive Plan which designates this site as suitable for development such as that proposed by this project.

**Staff Recommendations and Conditions of Approval:** Based upon the preceding review and a finding of consistency with the Comprehensive Plan, staff recommends that the Plan and Zoning Commission adopt a resolution approving the site plan to develop a 79 lot detached townhome development, subject to the applicant meeting all City Code requirements and the following:

1. The applicant acknowledging and agreeing that the easternmost access to Stagecoach Drive is temporary and will be disconnected from Stagecoach Drive when the planned connection to the

2. The applicant acknowledging and agreeing that the easternmost access drive off Stagecoach Drive is a one-way in only drive and shall remain as such until it is disconnected from Stagecoach Drive. Additionally, while the drive is in use as an access from Stagecoach Drive, the developer shall restrict the drive to a maximum of 20 feet in width and install and maintain appropriate traffic control design measures acceptable to the City, as well as all pavement markings and signage in accordance with MUTCD requirements to inform drivers that the easternmost drive is a one-way in only drive. Finally, the applicant ensuring enforcement as an access-in only drive. Upon removal, the developer will need to modify signage to indicate it as a dead-end.
3. The City Council allowing all excess ground included in Outlot 'X' adjacent to Sugar Creek beyond that required as part of Parkland Dedication be exempted from payment of Grand Avenue West Sanitary Sewer Connection Fees.
4. The applicant acknowledging and agreeing to execute a public access easement that will allow City vehicles and the general public to drive through the development to access Stagecoach Drive prior to City Council consideration of the associated Final Plat.
5. The applicant acknowledging that prior to issuance of any building permits for buildings within The Courtyards at Kings Landing development, that the associated Final Plat must be approved by the City Council and recorded with Dallas County.
6. The City Council deferring the installation of 17 parking stalls of the 32 required by Code until such time that parking on non-designated parking areas or parking off-site occurs due to the lack of available parking stalls. At that time, the City reserves the right to provide the applicant notice to increase the number of parking stalls. The applicant will be required to provide the additional parking spaces in accordance with City regulations within the first available construction season. Should the implementation of additional parking be needed, the applicant shall construct them in compliance with the plans submitted with this Site Plan that identifies the location and engineering details for the stalls to be constructed.
7. The applicant acknowledging and agreeing to submit a revised site plan that reflects that 15 of the 32 parking spaces will be constructed with the installation of required parking lot screening. The plan revisions shall be submitted to Staff prior to the issuance of building permits on the site.

**Applicant:** Caliber Iowa LLC  
 Nick Jensen  
 720 86<sup>th</sup> Street, Suite 120  
 West Des Moines, Iowa 50266  
[Nick@caliberiowa.com](mailto:Nick@caliberiowa.com)

**Applicant Representative:** Snyder and Associates  
 Eric Cannon  
 2727 SW Snyder Blvd  
 Ankeny, IA 50023  
[Ecannon@snyder-associates.com](mailto:Ecannon@snyder-associates.com)

**Attachments:**

- Attachment A - Plan and Zoning Commission Resolution
- Exhibit A - Conditions of Approval
- Attachment B - Location Map
- Attachment C - Site Plan
- Attachment D - Site Plan Identifying Lots That Will Require Public Architecture
- Attachment E - Building Elevations

RESOLUTION NO. PZC-19-060

**A RESOLUTION OF THE PLAN AND ZONING COMMISSION OF THE CITY OF WEST DES MOINES, RECOMMENDING TO THE CITY COUNCIL THAT IT APPROVE A SITE PLAN (SP-004323-2019) TO DEVELOP A 79 LOT DETACHED TOWNHOME DEVELOPMENT**

**WHEREAS**, pursuant to the provisions of Title 9, Chapter 1 et seq, of the West Des Moines Municipal Code, the applicant, The Caliber Iowa LLC., has requested approval for a Site Plan (SP-004323-2019) to develop a 79 lot detached townhome development on a 24.6 acre site located at the Northeast corner of S. 100th Street and Stagecoach Drive;

**WHEREAS**, studies and investigations were made, and staff reports and recommendations were submitted which is made a part of this record and herein incorporated by reference;

**WHEREAS**, on September 9, 2019, this Commission held a duly-noticed public meeting to consider the application for a Site Plan;

**NOW, THEREFORE, THE PLAN AND ZONING COMMISSION OF THE CITY OF WEST DES MOINES DOES RESOLVE AS FOLLOWS:**

SECTION 1. The findings, for approval, in the staff report, dated September 9, 2019 or as amended orally at the Plan and Zoning Commission hearing of September 9, 2019 are adopted.

SECTION 2. The Courtyards at King's Landing Site Plan (SP-004323-2019) to develop a 79 lot detached townhome development, is recommended to the City Council for approval, subject to compliance with all the conditions in the staff report including conditions added at the meeting, and attached hereto as Exhibit "A." Violation of any such conditions shall be grounds for revocation of the permit, as well as any other remedy which is available to the City.

PASSED AND ADOPTED on September 9, 2019.

\_\_\_\_\_  
Erica Andersen, Chairperson  
Plan and Zoning Commission

ATTEST:

\_\_\_\_\_  
Recording Secretary

I HEREBY CERTIFY that the foregoing resolution was duly adopted by the Plan and Zoning Commission of the City of West Des Moines, Iowa, at a regular meeting held on September 9, 2019, by the following vote:

AYES:  
NAYS:  
ABSTENTIONS:  
ABSENT:


ATTEST:

\_\_\_\_\_  
Recording Secretary



**EXHIBIT A  
CONDITIONS OF APPROVAL**

1. The applicant acknowledging and agreeing that the easternmost access to Stagecoach Drive is temporary and will be disconnected from Stagecoach Drive when the planned connection to the west is completed. The applicant will need to execute a formal agreement acknowledging and agreeing to such for recordation with the Final Plat.
2. The applicant acknowledging and agreeing that the easternmost access drive off Stagecoach Drive is a one-way in only drive and shall remain as such until it is disconnected from Stagecoach Drive. Additionally, while the drive is in use as an access from Stagecoach Drive, the developer shall restrict the drive to a maximum of 20 feet in width and install and maintain appropriate traffic control design measures acceptable to the City, as well as all pavement markings and signage in accordance with MUTCD requirements to inform drivers that the easternmost drive is a one-way in only drive. Finally, the applicant ensuring enforcement as an access-in only drive. Upon removal, the developer will need to modify signage to indicate it as a dead-end.
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4. The applicant acknowledging and agreeing to execute a public access easement that will allow City vehicles and the general public to drive through the development to access Stagecoach Drive prior to City Council consideration of the associated Final Plat.
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### Sugar Creek Estates

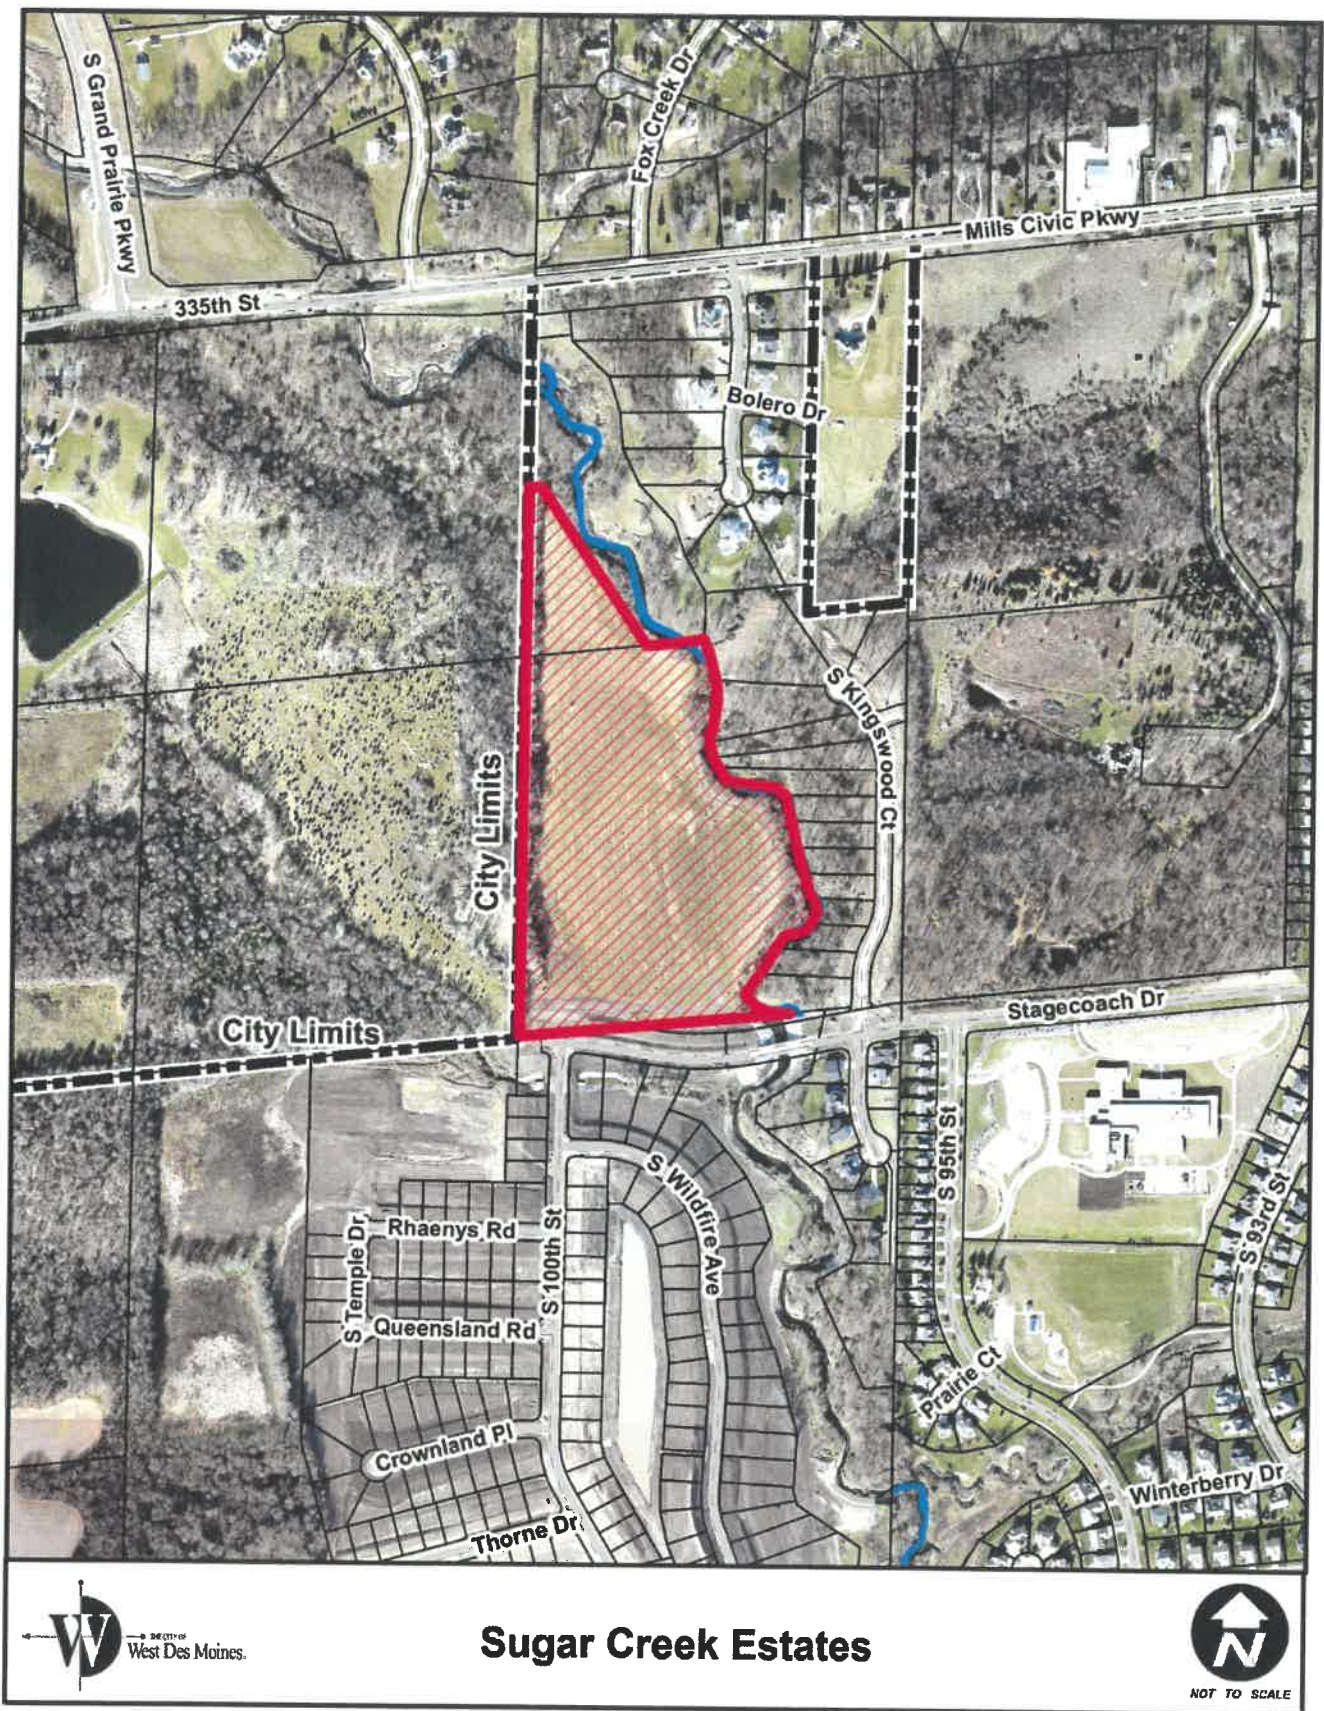

[https://wdmowa.sharepoint.com/sites/os/commdev/Documents/\\_\\_\\_Development Projects/Courtyards at Kings Landing \(fka Courtyards at Sugar Creek or Sugar Creek Estates\)/Courtyards at Kings Landing \(fka Courtyards at Sugar Creek\) Preliminary Plat and Site Plan/SP-004323-2019\\_SR\\_Courtyards at Kings Landing\\_PZ\\_09-09-2019.docx](https://wdmowa.sharepoint.com/sites/os/commdev/Documents/___Development%20Projects/Courtyards%20at%20Kings%20Landing%20(fka%20Courtyards%20at%20Sugar%20Creek%20Estates)/Courtyards%20at%20Kings%20Landing%20(fka%20Courtyards%20at%20Sugar%20Creek)%20Preliminary%20Plat%20and%20Site%20Plan/SP-004323-2019_SR_Courtyards%20at%20Kings%20Landing_PZ_09-09-2019.docx)



# SITE PLAN FOR COURTYARDS AT KINGS LANDING

## SINGLE FAMILY RESIDENTIAL DEVELOPMENT CITY OF WEST DES MOINES, DALLAS COUNTY, IOWA

**APPLICANT**


COURTYARDS AT KINGS LANDING LLC  
720 S 68TH STREET SUITE 120  
WEST DES MOINES, IOWA 50266  
CONTACT: NICK JENSEN  
PHONE: (515) 650-0530

**OWNER**

SUGAR CREEK ESTATES LLC  
2400 86TH STREET, SUITE 24  
DES MOINES, IA 50313  
CONTACT: DEREK TEMPLE  
PHONE: 515-276-3456

**ENGINEER**

SNYDER & ASSOCIATES, INC.  
2727 SW SNYDER BLVD.  
ANKENY, IOWA 50023  
CONTACT: ERIC CANNON, P.E.  
PHONE: (515) 964-2020

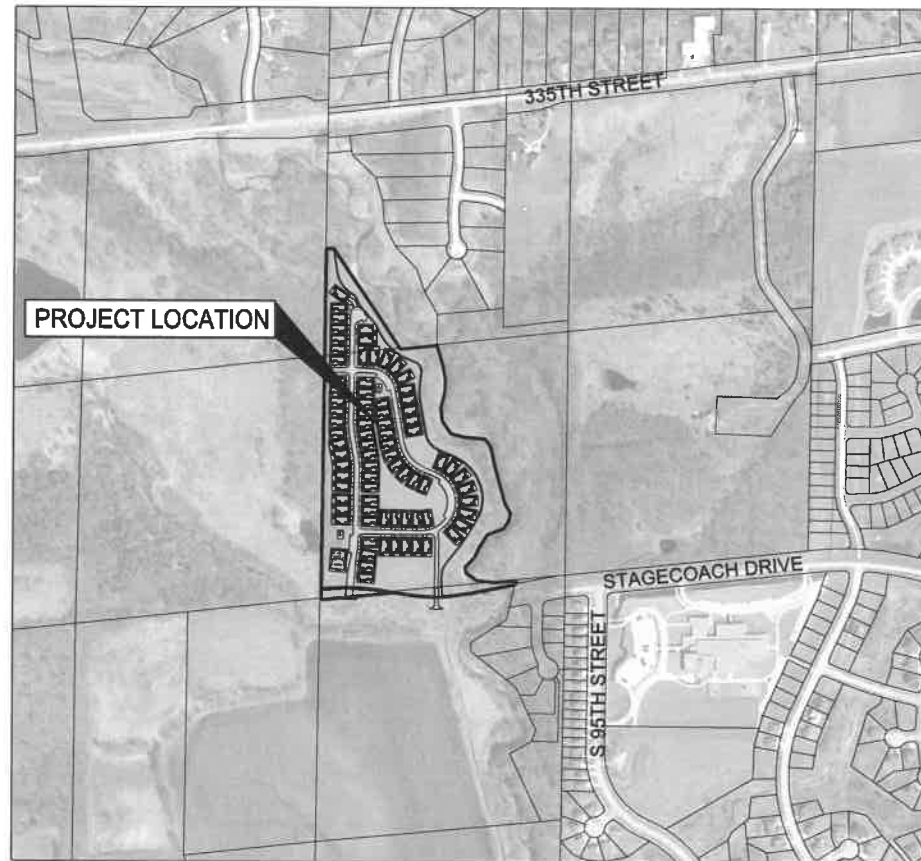


SCALE: 1"=1000'

VICINITY MAP

**INDEX OF SHEETS**


1. TITLE SHEET
2. PROJECT INFORMATION
3. OVERALL SITE LAYOUT PLAN
4. OVERALL GRADE PLAN
- 5-8. DIMENSION AND UTILITY PLAN
- 9-12. STORM SEWER PLAN
- 13-16. GRADING AND EROSION CONTROL PLAN
- 17-19. PLANTING NOTES AND DETAILS
20. INTERSECTION AND MISCELLANEOUS DETAILS



I hereby certify that the portion of this technical submission described below was prepared by me or under my direct supervision and responsible charge. I am a duly licensed Professional Landscape Architect under the laws of the State of Iowa.

Lara F. Guldenfennig, ASLA Date  
License Number 668  
Pages or sheets covered by this seal:  
Sheets 17-19

License Expires:  
June 30, 2020



I hereby certify that this engineering document was prepared by me or under my direct personal supervision and that I am a duly licensed Professional Engineer under the laws of the State of Iowa.

Eric D. Cannon, P.E. Date  
License Number 18954  
My License Renewal Date is December 31, 2019  
Pages or sheets covered by this seal:  
Sheets 1-16, 20


5	AS PER CITY COMMENTS	9/3/19	Pg.
4	REVISED GRADES AND UTILITIES	8/17/19	
3	AS PER CITY COMMENTS	7/18/19	
2	AS PER CITY COMMENTS	7/10/19	
1	DATE		
Engineer:	KMM	Checked By: EDC	Scale: 1"= 500'
Technician:	RMM	Date: 04/29/19	Field Bc:
Project No:	117.0693A		Sheet 1 of

**COURTYARDS AT KINGS LANDING**

**TITLE SHEET**

**SNYDER & ASSOCIATES, INC.**

2727 S.W. SNYDER BLVD.  
ANKENY, IOWA 50023  
515-964-2020 | www.snyder-associates.com



**SNYDER & ASSOCIATES**

Project No: 117.0693A

Sheet 1 of 20

**LEGEND**

Features	Existing	Proposed
Spot Elevation	93.0	93.0
Contour Elevation	-93-	-93-
Fence (Barbed, Field, Hag)	-x-x-	-x-x-
Fence (Chain Link)	-x-x-	-x-x-
Fence (Wood)	-x-x-	-x-x-
Fence (Silt)	-x-x-	-x-x-
Tree Line	-x-x-	-x-x-
Tree Stump	-x-x-	-x-x-
Deciduous Tree or Shrub	(Symbol)	(Symbol)
Coniferous Tree or Shrub	(Symbol)	(Symbol)
Communication	C(x)	C
Overhead Communication	OC(x)	OC
Fiber Optic	FO(x)	FO
Underground Electric	E(x)	E
Overhead Electric	OE(x)	OE
Gas Main with Size	4" G(x)	4" G
High Pressure Gas Main with Size	HPG(x)	HPG
Water Main with Size	8" W(x)	8" W
Sanitary Sewer with Size	8" S(x)	8" S
Duct Bank	DUCT(x)	
Test Hole Location for SUE w/ID	21	
(X) Denotes the survey quality service level for utilities		
Sanitary Manhole	12" ST	12" ST
Storm Sewer with Size	12" ST	12" ST
Storm Manhole	(Symbol)	(Symbol)
Single Storm Sewer Intake	(Symbol)	(Symbol)
Double Storm Sewer Intake	(Symbol)	(Symbol)
Fire Hydrant	(Symbol)	(Symbol)
Fire Hydrant on Building	(Symbol)	(Symbol)
Water Main Valve	(Symbol)	(Symbol)
Water Service Valve	(Symbol)	(Symbol)
Well	(Symbol)	(Symbol)
Utility Pole	(Symbol)	(Symbol)
Guy Anchor	(Symbol)	(Symbol)
Utility Pole with Light	(Symbol)	(Symbol)
Utility Pole with Transformer	(Symbol)	(Symbol)
Street Light	(Symbol)	(Symbol)
Yard Light	(Symbol)	(Symbol)
Electric Box	(Symbol)	(Symbol)
Electric Transformer	(Symbol)	(Symbol)
Traffic Sign	(Symbol)	(Symbol)
Communication Pedestal	(Symbol)	(Symbol)
Communication Manhole	(Symbol)	(Symbol)
Communication Handhole	(Symbol)	(Symbol)
Fiber Optic Manhole	(Symbol)	(Symbol)
Fiber Optic Handhole	(Symbol)	(Symbol)
Gas Valve	(Symbol)	(Symbol)
Gas Manhole	(Symbol)	(Symbol)
Gas Apparatus	(Symbol)	(Symbol)
Fence Post or Guard Post	(Symbol)	(Symbol)
Underground Storage Tank	(Symbol)	(Symbol)
Above Ground Storage Tank	(Symbol)	(Symbol)
Sign	(Symbol)	(Symbol)
Satellite Dish	(Symbol)	(Symbol)
Mailbox	(Symbol)	(Symbol)
Soil Boring	(Symbol)	(Symbol)

**UTILITY QUALITY SERVICE LEVELS**

QUALITY LEVELS OF UTILITIES ARE SHOWN IN THE PARENTHESES WITH THE UTILITY TYPE AND WHEN APPLICABLE, SIZE. THE QUALITY LEVELS ARE BASED ON THE CI/ ASCE 38-02 STANDARD.

**QUALITY LEVEL (Q)** INFORMATION IS DERIVED FROM EXISTING UTILITY RECORDS OR ORAL RECOLLECTIONS.

**QUALITY LEVEL (C)** INFORMATION IS OBTAINED BY SURVEYING AND PLOTTING VISIBLE ABOVE-GROUND UTILITY FEATURES AND USING PROFESSIONAL JUDGMENT IN CORRELATING THIS INFORMATION WITH QUALITY D INFORMATION.

**QUALITY LEVEL (B)** INFORMATION IS OBTAINED THROUGH THE APPLICATION OF APPROPRIATE SURFACE GEOPHYSICAL METHODS TO DETERMINE THE EXISTENCE AND APPROXIMATE HORIZONTAL POSITION OF SUBSURFACE UTILITIES.

**QUALITY LEVEL (A)** IS HORIZONTAL AND VERTICAL POSITION OF UNDERGROUND UTILITIES OBTAINED BY ACTUAL EXPOSURE OR VERIFICATION OF PREVIOUSLY EXPOSED SUBSURFACE UTILITIES, AS WELL AS THE TYPE, SIZE, CONDITION, MATERIAL, AND OTHER CHARACTERISTICS.

**UTILITY WARNING**

THE UTILITIES SHOWN HAVE BEEN LOCATED FROM FIELD SURVEY INFORMATION AND/OR RECORDS OBTAINED. THE SURVEYOR MAKES NO GUARANTEE THAT THE UTILITIES OR SUBSURFACE FEATURES SHOWN COMPRISE ALL SUCH ITEMS IN THE AREA, EITHER IN SERVICE OR ABANDONED. THE SURVEYOR FURTHER DOES NOT WARRANT THAT THE UTILITIES OR SUBSURFACE FEATURES SHOWN ARE IN THE EXACT LOCATION INDICATED EXCEPT WHERE NOTED AS QUALITY LEVEL A.

**UTILITY CONTACT INFORMATION**

UTILITY CONTACT FOR MAPPING INFORMATION SHOWN AS RECEIVED FROM THE IOWA ONE CALL DESIGN REQUEST SYSTEM, TICKET NUMBER 551902360.

W1-WATER	WEST DES MOINES WATER WORKS WILLIAM MABUCE 515-222-3510 william.mabuce@wdmww.com
E1-ELECTRIC G1-GAS	MIDAMERICAN ENERGY CRAIG RANFELD 515-252-6632 MECDSMDesignLocates@midamericon.com
S5-SANITARY SEWER	DES MOINES METRO WASTEWATER NICK CARTER 515-323-8135 nfcarter@dmgov.org
CLEAR PER MAP	WEST DES MOINES TRAFFIC JIM DICKINSON 515-222-3482 jim.dickinson@wdm.iowa.org
CLEAR PER MAP	CENTURYLINK TOM STURMER 720-578-8090 thomas.sturmer@centurylink.com
CLEAR PER EMAIL	MEDIACOM COMMUNICATIONS CORP PAUL MAY 515-246-2252 pmay@mediacomcc.com



**GENERAL NOTES**

- NOTIFY UTILITY PROVIDERS PRIOR TO BEGINNING ANY CONSTRUCTION ACTIVITIES AND COORDINATE WITH UTILITY PROVIDERS AS NECESSARY DURING CONSTRUCTION. CONTRACTOR IS RESPONSIBLE FOR DETERMINING EXISTENCE, EXACT LOCATION, AND DEPTH OF ALL UTILITIES. PROTECT ALL UTILITIES AND STRUCTURES NOT SHOWN FOR REMOVAL OR MODIFICATION. ANY DAMAGES TO UTILITY ITEMS NOT SHOWN FOR REMOVAL OR MODIFICATION SHALL BE REPAIRED TO THE UTILITY OWNER'S SPECIFICATIONS AT THE CONTRACTOR'S EXPENSE.
- LENGTH OF UTILITIES SHOWN ON PLANS ARE DIMENSIONED FROM CENTERLINE OF STRUCTURE TO CENTERLINE OF STRUCTURE.
- ALL TRAFFIC CONTROL SHALL BE PROVIDED IN ACCORDANCE WITH REQUIREMENTS SET FORTH IN THE MANUAL ON UNIFORM TRAFFIC CONTROL DEVICES (MUTCD). WHEN CONSTRUCTION ACTIVITIES OBSTRUCT PORTIONS OF THE ROADWAY, FLAGGERS SHALL BE PROVIDED. FLAGGERS SHALL CONFORM TO THE MUTCD IN APPEARANCE, EQUIPMENT AND ACTIONS.
- CONSTRUCT MANHOLES AND APPURTENANCES AS WORK PROGRESSES. BACKFILL WITH SUITABLE MATERIAL AND COMPACT TO 95% MAXIMUM DENSITY.
- IN THE EVENT OF A DISCREPANCY BETWEEN THE QUANTITY ESTIMATES AND THE DETAILED PLANS, THE DETAILED PLANS SHALL GOVERN.
- ALL FIELD TILES ENCOUNTERED DURING CONSTRUCTION SHALL BE RECONNECTED AND NOTED ACCORDINGLY ON THE AS-BUILT DOCUMENTS.
- DIMENSIONS, BUILDING LOCATION, UTILITIES AND GRADING OF THIS SITE ARE BASED ON AVAILABLE INFORMATION AT THE TIME OF DESIGN. DEVIATIONS MAY BE NECESSARY IN THE FIELD. ANY SUCH CHANGES OR CONFLICTS BETWEEN THIS PLAN AND FIELD CONDITIONS ARE TO BE REPORTED TO THE ARCHITECT/ENGINEER PRIOR TO STARTING CONSTRUCTION. THE CONTRACTOR SHALL BE RESPONSIBLE FOR LAYOUT VERIFICATION OF ALL SITE IMPROVEMENTS PRIOR TO CONSTRUCTION.
- CONTRACTOR TO LOAD AND TRANSPORT ALL MATERIALS CONSIDERED TO BE UNDESIRABLE TO BE INCORPORATED INTO THE PROJECT TO AN APPROVED OFF-SITE WASTE SITE.
- CONTRACTOR TO STRIP AND STOCKPILE TOPSOIL FROM ALL AREAS TO BE CUT OR FILLED, AS PER NPDES GENERAL PERMIT NO. 2, MAINTAIN ALL TOPSOIL ON-SITE. RESPREAD TO MINIMUM 4" DEPTH TO FINISH GRADES.
- ALL PROPOSED CONTOURS AND SPOT ELEVATIONS SHOWN ARE FINISHED GRADES AND/OR TOP OF CURB, UNLESS OTHERWISE NOTED.
- THE CONTRACTOR IS RESPONSIBLE FOR CLEANING DIRT AND DEBRIS FROM NEIGHBORING STREETS, DRIVEWAYS, AND SIDEWALKS CAUSED BY CONSTRUCTION ACTIVITIES IN A TIMELY MANNER.
- THE ADJUSTMENT OF ANY EXISTING UTILITY APPURTENANCES TO FINAL GRADE IS CONSIDERED INCIDENTAL TO THE SITE WORK.
- THE CONTRACTOR SHALL BE RESPONSIBLE FOR INSTALLING EROSION CONTROL MEASURES AS NECESSARY. CONTRACTOR SHALL ALSO BE RESPONSIBLE FOR MAINTAINING ANY EXISTING EROSION CONTROL MEASURES ON SITE AT THE TIME OF CONSTRUCTION. GRADING AND SOIL EROSION CONTROL CODE REQUIREMENTS SHALL BE MET BY CONTRACTOR. A GRADING PERMIT IS REQUIRED FOR THIS PROJECT IF GRADING BEGINS PRIOR TO APPROVAL OF THE PRELIMINARY PLAT/SITE PLAN.
- CONTRACTOR TO COORDINATE NATURAL GAS, ELECTRICAL, TELEPHONE AND ANY OTHER FRANCHISE UTILITY SERVICES WITH UTILITY SERVICE PROVIDER, WEST DES MOINES, AND THE OWNER PRIOR TO CONSTRUCTION.
- CONTRACTOR TO VERIFY ALL UTILITY CROSSINGS AND MAINTAIN MINIMUM 18" VERTICAL AND HORIZONTAL CLEARANCE BETWEEN UTILITIES. CONTRACTOR TO COORDINATE UTILITY ROUTING TO BUILDINGS AND VERIFY CONNECTION LOCATIONS AND INVERTS PRIOR TO CONSTRUCTION.
- ALL CONSTRUCTION WITHIN PUBLIC R.O.W./EASEMENTS, AND/OR ANY CONNECTION TO THE PUBLIC SEWERS AND STREETS, SHALL COMPLY WITH THE WEST DES MOINES STANDARD CONSTRUCTION SPECIFICATIONS FOR SUBDIVISIONS, DSM METRO DESIGN STANDARDS AND WDM ADDENDUMS.
- AT LEAST ONE WEEK PRIOR TO ANY CONSTRUCTION WITHIN PUBLIC R.O.W./EASEMENTS AND/OR ANY CONNECTION TO PUBLIC SEWERS AND STREETS, THE CONTRACTOR SHALL CONTACT THE ENGINEERING SERVICES 222-3475 TO OBTAIN APPLICABLE CITY PERMITS THAT MAY BE NECESSARY. CITY APPROVAL OF THIS PLAN IS SUBJECT TO THE APPLICANT OBTAINING ALL NECESSARY EASEMENTS/AGREEMENTS AND APPLICABLE PERMITS. AN EXCAVATION PERMIT IS REQUIRED FOR ANY WORK IN THE PUBLIC RIGHT-OF-WAY.
- ALL WATER MAIN, SANITARY SEWER AND STORM SEWER ARE PRIVATE, UNLESS OTHERWISE NOTED.
- ALL SIDEWALK RAMPS IN THE PUBLIC RIGHT-OF-WAY COMPLY WITH PROWAG REQUIREMENTS. ALL NEW PUBLIC PEDESTRIAN RAMPS SHALL BE AS-BUILT AND CERTIFIED BY AN IOWA LICENSED ENGINEER STATING THEY MEET PUBLIC RIGHT-OF-WAY ACCESSIBILITY GUIDELINES (PROWAG).
- THE PROJECT CIVIL ENGINEER SHALL PROVIDE AS-BUILT DOCUMENTATION THAT THE STORM WATER DRAINAGE SYSTEM HAS BEEN CONSTRUCTED AS DESIGNED. THE AS-BUILT SHALL BE FORWARDED TO THE CITY BEFORE ISSUANCE OF THE FINAL OCCUPANCY PERMIT, AND SHALL INCLUDE ELEVATIONS, DETENTION AND RETENTION POND CAPACITY, PIPING RESTRICTIONS, AND ANY PERTINENT ASPECTS OF THE STORM WATER SYSTEM.
- A REPORT CERTIFIED BY A THIRD-PARTY RECOGNIZED TESTING AGENCY, ACCEPTABLE TO THE CITY, SHALL BE SUBMITTED TO DOCUMENT THE THICKNESS AND STRENGTH OF THE PAVEMENT, THE SUB-GRADE, COMPACTION, COMPLIANCE WITH THE METRO DESIGN STANDARDS FOR STREETS, AND THE STANDARDS LISTED IN THE WEST DES MOINES "OFF STREET PARKING ORDINANCE" FOR PRIVATE STREETS, PARKING LOTS, AND DRIVEWAYS.
- LANE CLOSURE NOTICES MUST BE SUBMITTED TO WEST DES MOINES PUBLIC WORKS FOR APPROVAL A MINIMUM OF 48 HOURS IN ADVANCE OF CLOSURE.
- COORDINATE STAGING AND TRAFFIC CONTROL WITH WDM EMERGENCY SERVICES.
- STREET LOT A AND OUTLOT X ARE TO BE DEDICATED TO THE CITY OF WEST DES MOINES.
- ALL STREETS ARE TO BE PRIVATE.
- ALL STREETS NEED TO ALLOW FOR EMERGENCY VEHICLE MANEUVERABILITY, SIGNING, PAVEMENT MARKINGS, AND OTHER TRAFFIC CONTROL DEVICES ON ALL STREETS (PUBLIC OR PRIVATE) NEED TO BE IN CONFORMANCE WITH THE MUTCD (FEDERAL HIGHWAY ADMINISTRATION).

**WEST DES MOINES STANDARD NOTES**

- THE GENERAL CONTRACTOR SHALL BE RESPONSIBLE FOR THE COORDINATION OF WORK OF ALL SUBCONTRACTOR(S) INVOLVED IN THE PROJECT.
- CONTACT BUILDING INSPECTION (515-222-3630) A MINIMUM OF 24 HOURS IN ADVANCE FOR PRIVATE UTILITY INSTALLATION INSPECTIONS. PRIVATE UTILITIES SHALL BE INSTALLED PER WEST DES MOINES STANDARD CONSTRUCTION SPECIFICATIONS FOR PUBLIC IMPROVEMENTS AND THE CURRENT UNIFORM PLUMBING CODE.
- DESIGNATED BUFFERS SHALL BE LABELED AS A "NO BUILD AREA".
- ALL LIGHTS ARE TO BE DOWNCAST CUTOFF VARIETY, WALL PACKS ARE PROHIBITED. THE MAXIMUM ILLUMINATION ALLOWED AT THE PROPERTY LINE IS 1 FOOT-CANDLE.

**WEST DES MOINES WATER WORKS STANDARD NOTES**

- ALL WATER WORK, PUBLIC OR PRIVATE, SHALL BE DONE IN ACCORDANCE WITH WEST DES MOINES WATER WORKS STANDARD SPECIFICATIONS.
- CONTRACTOR SHALL NOTIFY WEST DES MOINES WATER WORKS (515-222-3465) AT LEAST ONE WEEK PRIOR TO BUILDING CONSTRUCTION.
- ANY WATER USE FROM A HYDRANT, PUBLIC OR PRIVATE, REQUIRES THE USE OF A WEST DES MOINES WATER WORKS HYDRANT METER. CALL 515-222-3465 TO RESERVE A METER.
- THE GENERAL CONTRACTOR SHALL BE RESPONSIBLE FOR COMPLIANCE WITH THE WEST DES MOINES WATER WORKS AND THE CITY'S CROSS CONNECTION CONTROL/CONTAINMENT PROVISION.
- THE GENERAL CONTRACTOR SHALL BE RESPONSIBLE FOR THE PROPER INSTALLATION OF AN APPROVED BACKFLOW PREVENTION ASSEMBLY(IES) FOR CONTAINMENT IN ALL NEW CONSTRUCTION. BACKFLOW PREVENTION TO BE INSTALLED PER CITY ORDINANCE 1297, 54-1998. CONTRACTOR SHALL NOTIFY WEST DES MOINES WATER WORKS, RALPH RENTERIA, ENGINEERING TECHNICIAN (515-222-3465) A MINIMUM OF 24 HOURS AFTER INSTALLATION AND TESTING OF ALL BACKFLOW DEVICES TO SCHEDULE FINAL INSPECTION.

**LEGAL DESCRIPTION**

PART OF OUTLOT "X", THURON AN OFFICIAL PLAT AND PARCEL 17-121AS RECORDED IN BOOK 20 PAGE 2264 OF THE DALLAS COUNTY RECORDER'S OFFICE ALL BEING IN THE WEST 1/2 OF THE SOUTHWEST 1/4 OF SECTION 15, TOWNSHIP 78 NORTH, RANGE 26 WEST OF THE 5TH P.M. CITY OF WEST DES MOINES, DALLAS COUNTY, IOWA, CONTAINING 26.00 AC (1,176,278 SF.).

TOTAL PROJECT AREA = 24.01 ACRES

**ZONING**

RM - MEDIUM DENSITY RESIDENTIAL

**COMPREHENSIVE LAND USE**

EXISTING: SINGLE FAMILY RESIDENTIAL  
PROPOSED: MEDIUM DENSITY RESIDENTIAL DISTRICT

**FIRM DESIGNATION**

THIS SITE IS WITHIN ZONE "A" (AREAS DETERMINED TO BE OUTSIDE THE 0.2% ANNUAL CHANCE FLOODPLAIN) AS REFERENCED ON FLOOD INSURANCE RATE MAP (FIRM), MAP NO 19153C0315F, MAP REVISED MARCH 16, 2019

**IMPERVIOUS AREA**

384,069 SF TOTAL IMPERVIOUS AREA (32.4% OF SITE)

**PARKING REQUIREMENTS**

**REQUIRED**  
1 SPACES PER DWELLING  
79 X 11 = 79 SPACES REQUIRED  
20 SPACE PER 1000 SF OF CLUBHOUSE ASSEMBLY AREA  
1,400 SF OF ASSEMBLY AREA = 28 STALLS  
1 SPACE FOR EVERY 15 DWELLING UNITS  
79 UNITS / 15 = 5 STALLS  
TOTAL 112 SPACES REQUIRED

**PROVIDED**  
2 DRIVEWAY SPACES PER UNIT  
79 X 2 = 158 SPACES PROVIDED  
42 VISITOR PARKING STALLS PROVIDED  
TOTAL 200 SPACES PROVIDED

NO ON STREET PARKING ALLOWED ON SOUTH 100TH STREET FROM STAGECOACH DRIVE TO STREET D

**PARKLAND DEDICATION**

PARKLAND REQUIREMENT: 1.70 ACRES  
PARKLAND DEDICATED: 5.42 ACRES (OUTLOT X)

**CITY OF WEST DES MOINES CONTROL DATUM**

CITY OF WEST DES MOINES DATUM (GEOID12A) NAVD88 - 774.01)

WEST DES MOINES BM#087  
3960 FEET WEST OF INTERSECTION OF SOUTH 88TH STREET (DALLAS COUNTY), 3 FEET NORTH OF EAST/WEST FENCE, 10 FEET EAST OF NORTH/SOUTH FENCE, ON 335TH STREET ACROSS FROM HOUSE # 3307 AND #3309.  
ELEVATION=167.68

WEST DES MOINES BM#095  
1.1 MILES EST OF INTERSECTION OF 88TH STREET AND 335TH STREET, (DALLAS COUNTY), TOP OF SOUTHWEST CONCRETE BRIDGE RAIL ON BRIDGE OVER FOX CREEK.  
ELEVATION=107.68

**BENCHMARKS**

CITY OF WEST DES MOINES 1988 (NAVD88 - GEOID12A)  
IARTN DERIVED - US SURVEY FEET  
BM1 ELEVATION=194.80  
CITY OF WEST DES MOINES BENCHMARK #37. CONCRETE MONUMENT WITH BRASS DISK SOUTHWEST CORNER OF SITE.

**CONTROL POINTS**

IOWA STATE PLANE SOUTH COORDINATE SYSTEM  
NAD83(2011)EPOCH 2010.00 IARTN DERIVED - US SURVEY FEET  
CP1 N=565217.15 E=1546019.43  
1/2" REBAR WITH RED SNYDER CONTROL CAP SOUTHEAST CORNER OF SITE, AS SHOWN ON SURVEY.  
CP2 N=565984.37 E=1545902.36  
1/2" REBAR WITH RED SNYDER CONTROL CAP CENTER OF SITE ALONG EAST TREE LINE, AS SHOWN ON SURVEY.  
CP3 N=566883.34 E=1545399.45  
1/2" REBAR WITH RED SNYDER CONTROL CAP NORTH CORNER OF SITE, AS SHOWN ON SURVEY.  
CP4 N=566114.46 E=1545360.67  
1/2" REBAR WITH RED SNYDER CONTROL CAP CENTER OF SITE ALONG WEST TREE LINE, AS SHOWN ON SURVEY.  
CP5 N=565095.93 E=1545297.03  
CONCRETE MONUMENT WITH BRASS DISK SOUTHWEST CORNER OF SITE, AS SHOWN ON SURVEY.

MARK	REVISION	DATE	BY
5	AS PER CITY COMMENTS	9/23/19	KMM
4	REVISED GRADES AND UTILITIES	8/7/19	KSS
3	AS PER CITY COMMENTS	7/19/19	RAM
2	AS PER CITY COMMENTS	7/10/19	RAM

Engineer: KMM  
Checked By: EDC  
Scale: 1"=1'  
Technician: RAM  
Date: 04/29/19  
Field No.:  
Project No.: 117.0693A  
Sheet 2 of 20

**WEST DES MOINES, IA**

**COURTYARDS AT KINGS LANDING**



**PROJECT INFORMATION**

2727 S.W. SNYDER BLVD.  
ANKENY, IOWA 50023  
515-964-2020 | www.snyder-associates.com

**SNYDER & ASSOCIATES, INC.**

Project No: 117.0693A  
Sheet 2 of 20

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# COURTYARDS AT KINGS LANDING
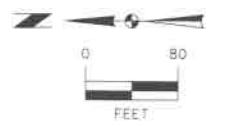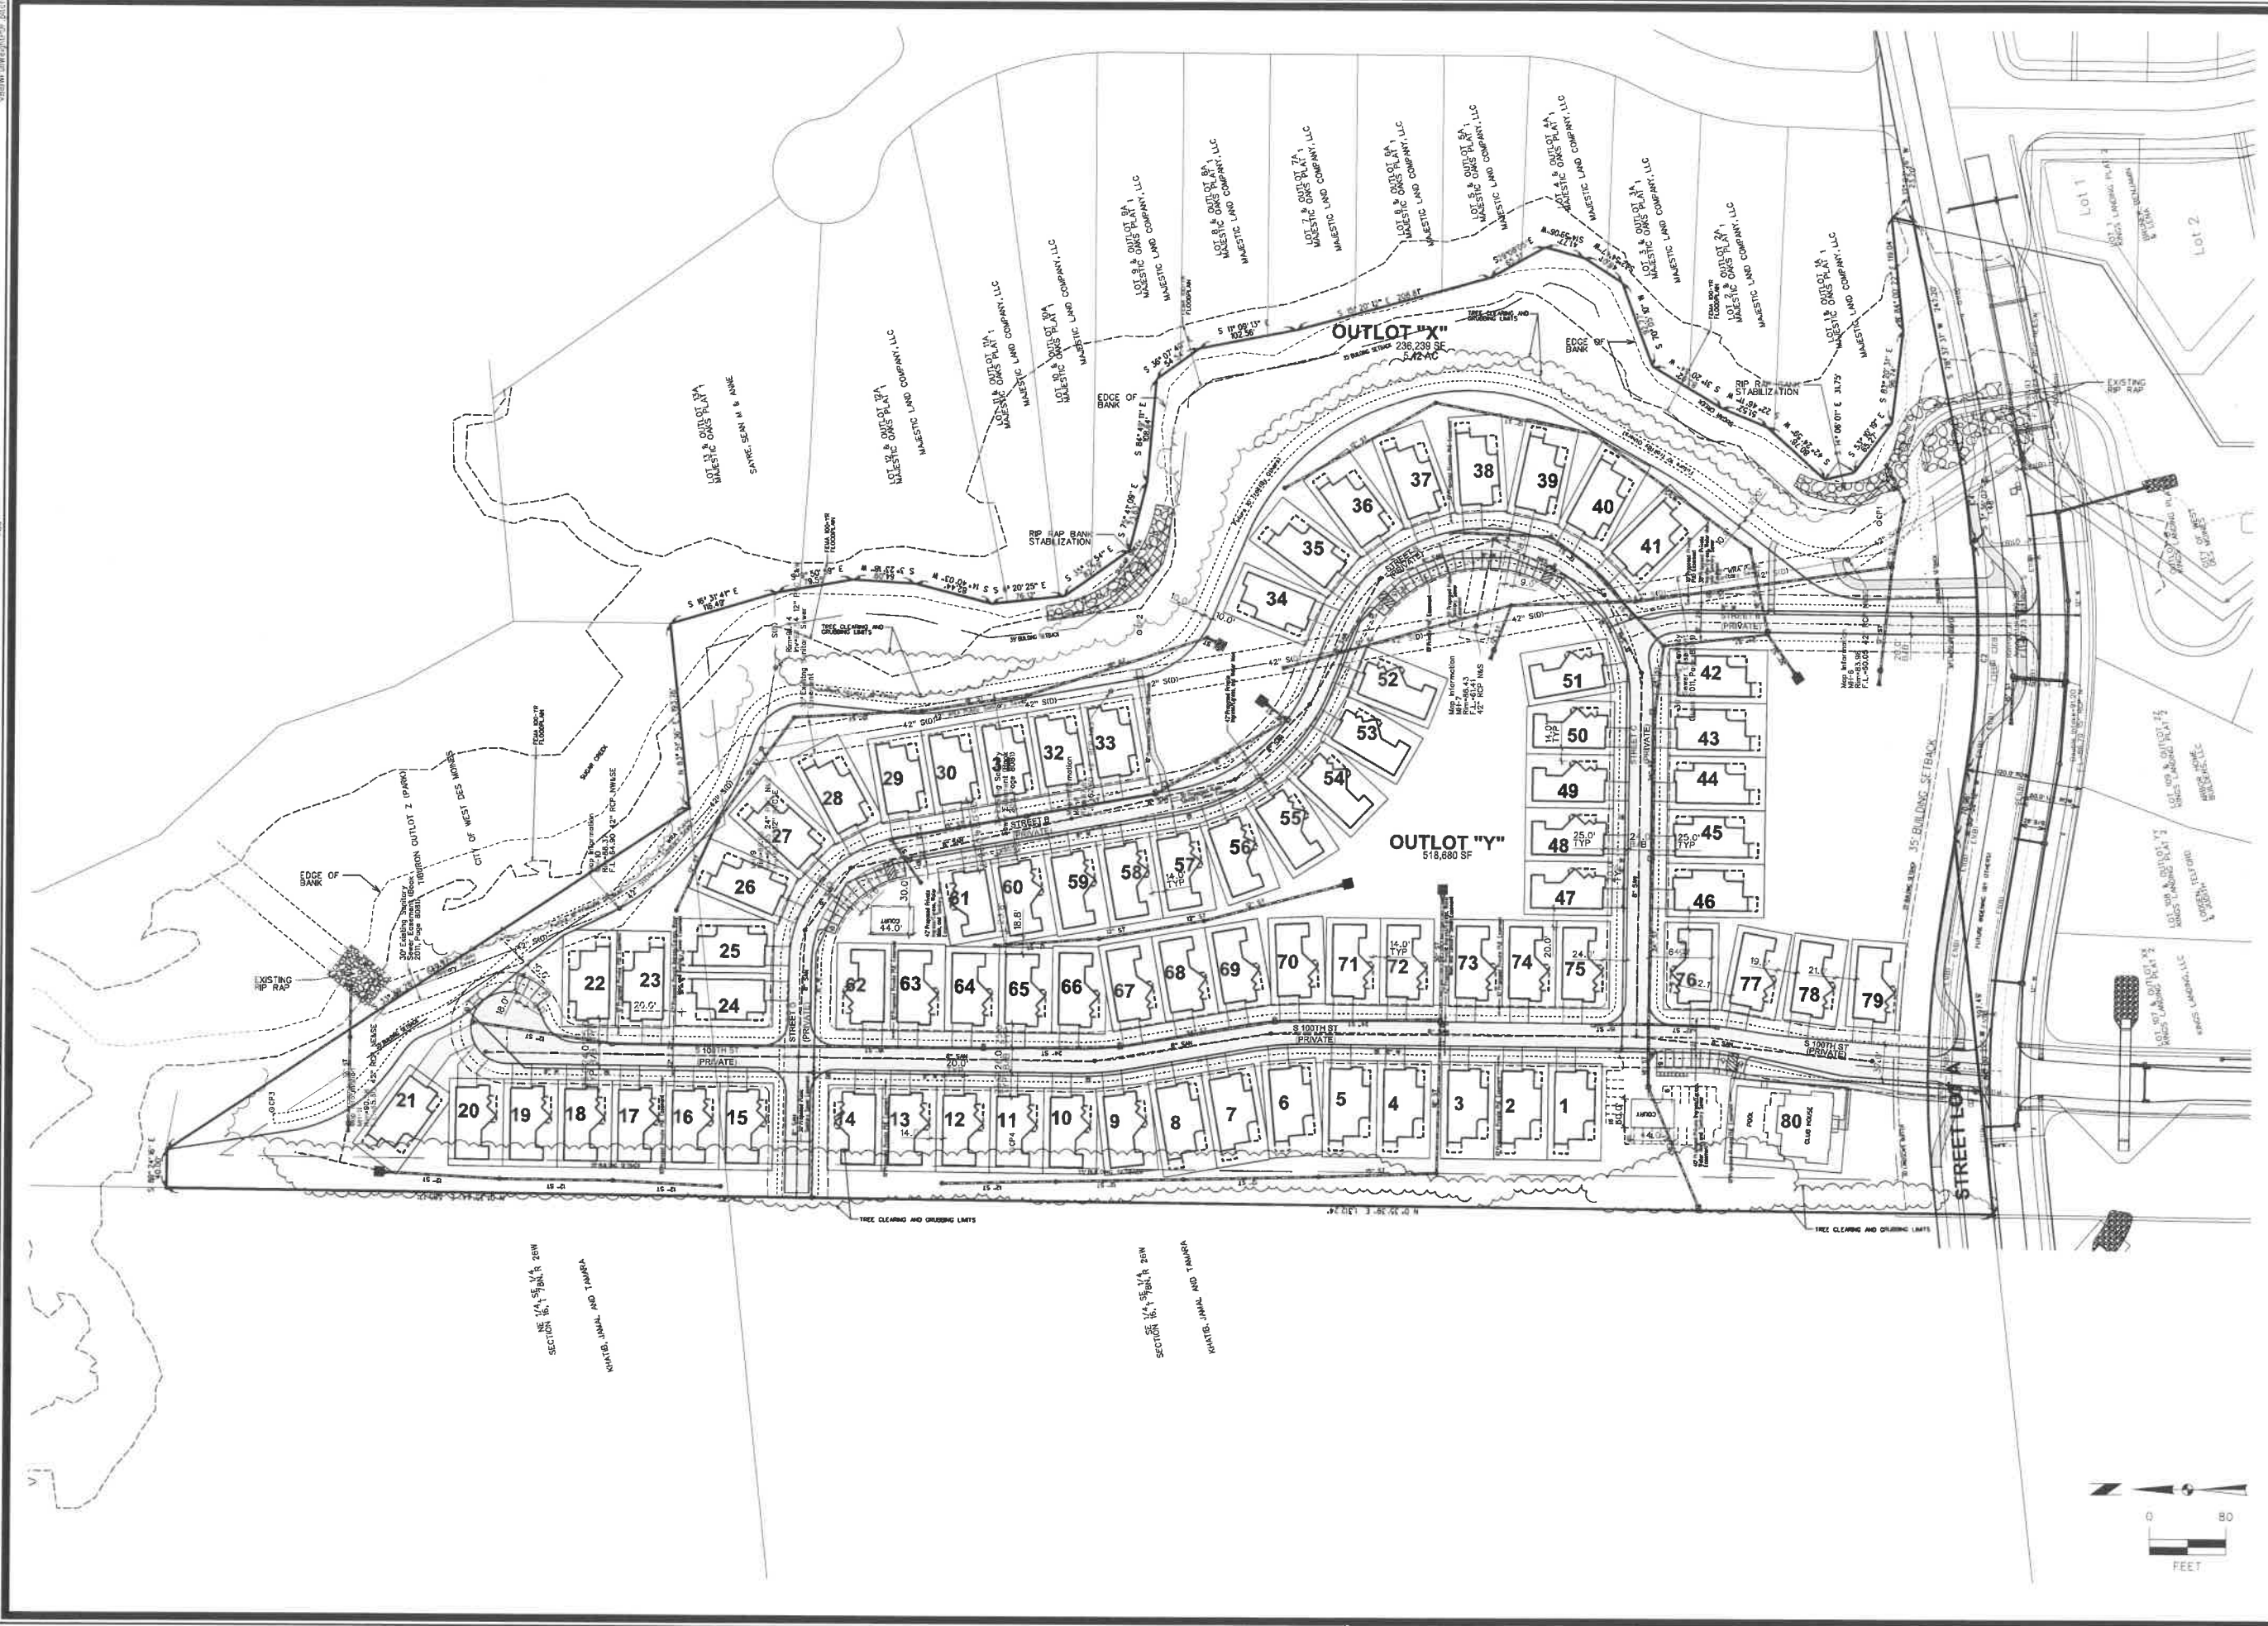
## OVERALL SITE LAYOUT



**SNYDER & ASSOCIATES**

Project No: 117.0693A

Sheet 3 of 20

WEST DES MOINES, IA

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 515-964-2020 | www.snyder-associates.com

# SNYDER & ASSOCIATES, INC.

MARK	REVISION	DATE	BY
5	AS PER CITY COMMENTS	9/3/19	RMM
4	REVISED GRADES AND UTILITIES	8/17/19	RSS
3	AS PER CITY COMMENTS	7/19/19	RMM
2	AS PER CITY COMMENTS	7/10/19	RMM



  

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Project No: 117.0693A



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# COURTYARDS AT KINGS LANDING

## MASTER GRADE PLAN

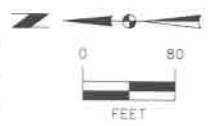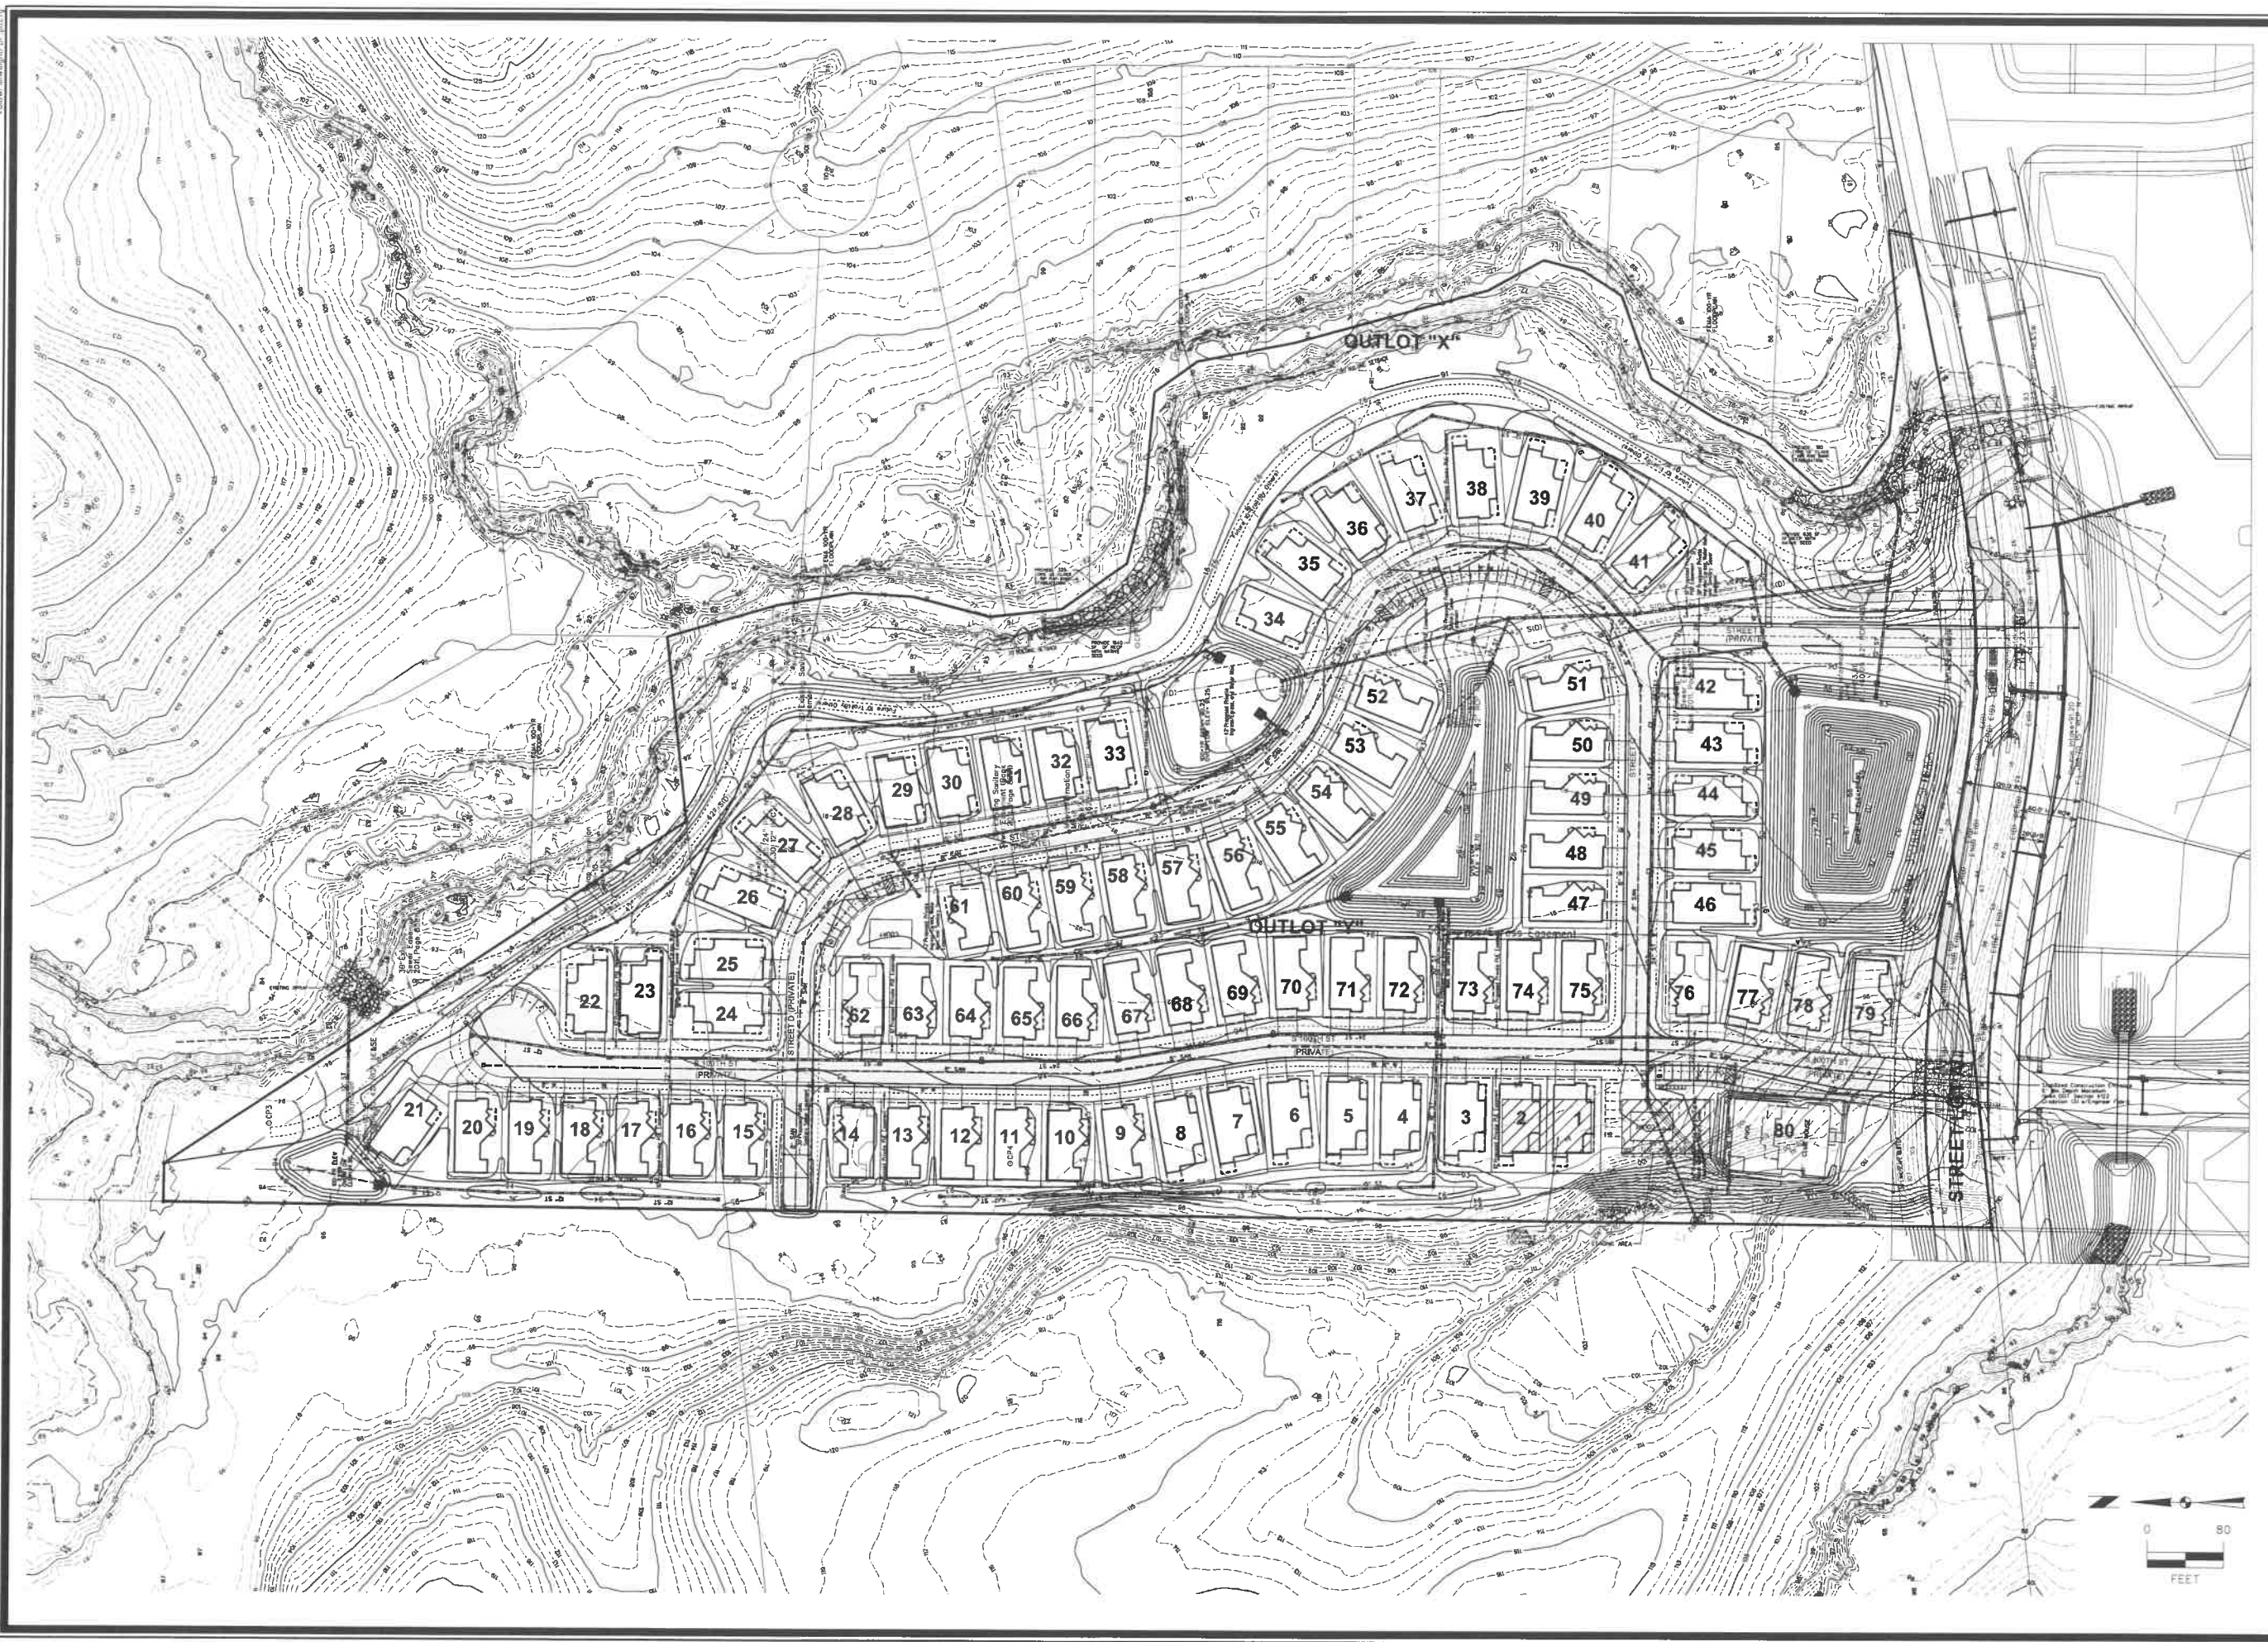

Project No: 117.0693A

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WEST DES MOINES, IA

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NO.	DATE	BY	REVISION
5	9/3/19	RMM	AS PER CITY COMMENTS
4	8/17/19	KSS	REVISED GRADES AND UTILITIES
3	7/19/19	RMM	AS PER CITY COMMENTS
2	7/10/19	RMM	AS PER CITY COMMENTS


  

DATE	BY	REVISION
04/29/19	EDC	Checked By
04/29/19	RMM	Engineer

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Project No: 117.0693A  
Page: 4 of 20




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CHECKED BY: EDC  
DATE: 11-14-19  
SCALE: 1"=40'  
FIELD NO: 117.0693A  
SHEET NO: 5 OF 20

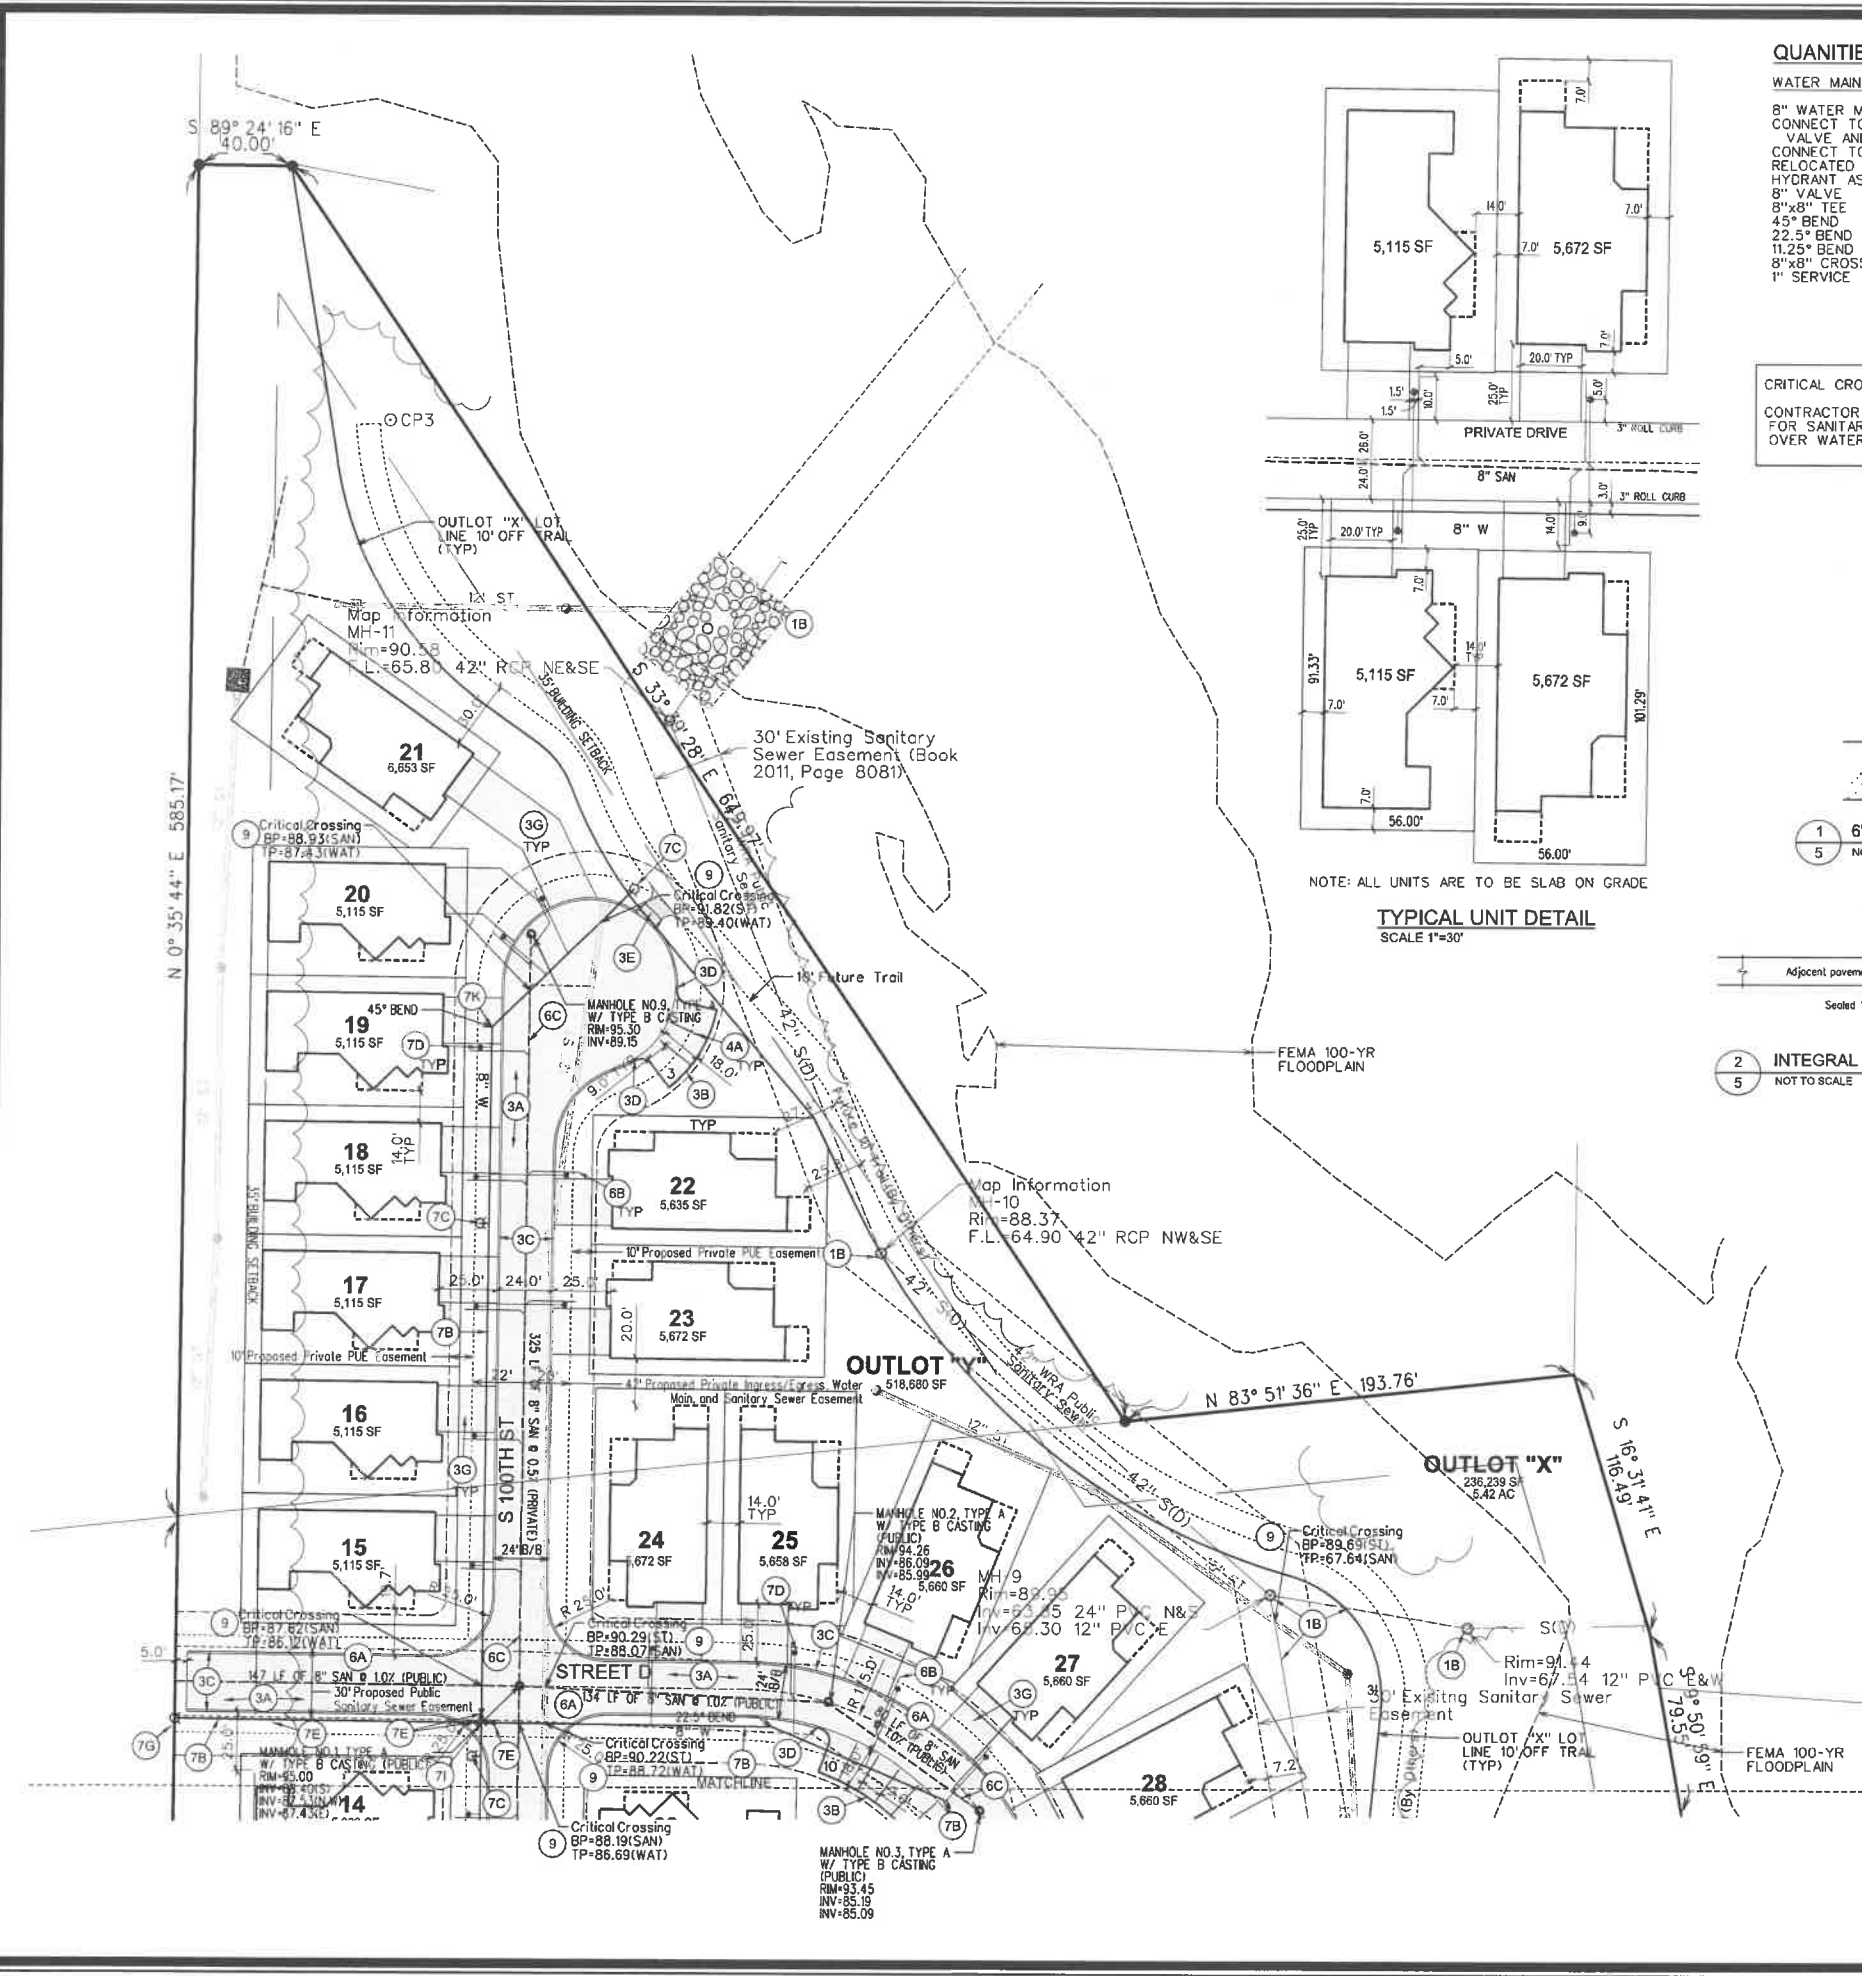



**QUANTITIES**

ITEM	QUANTITY
8" WATER MAIN	3832 LF.
CONNECT TO EXISTING W/TAPPING VALVE AND SLEEVE	1 EA.
CONNECT TO EXISTING RELOCATED HYDRANT ASSEMBLY	1 EA.
HYDRANT ASSEMBLY	1 EA.
8" VALVE	11 EA.
8"x8" TEE	9 EA.
45° BEND	2 EA.
22.5° BEND	10 EA.
11.25° BEND	2 EA.
8"x8" CROSS	1 EA.
1" SERVICE	79 EA.

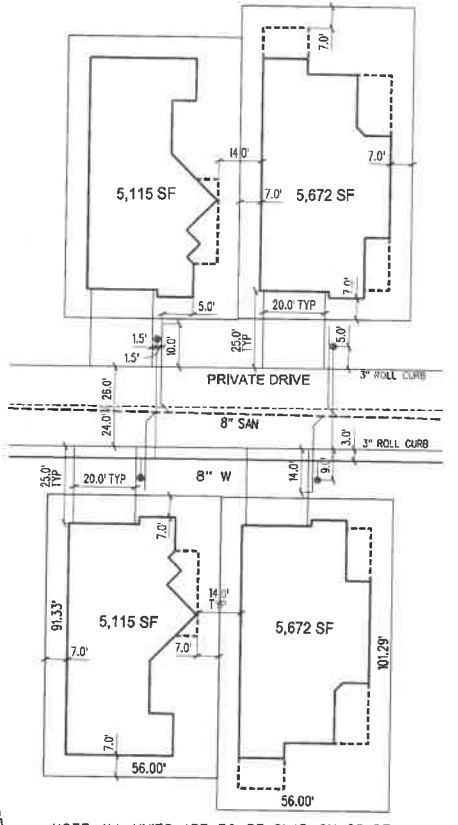


**TYPICAL UNIT DETAIL**  
SCALE 1"=30'

**CRITICAL CROSSING NOTE:**  
CONTRACTOR TO USE C900 PIPE MATERIAL FOR SANITARY SEWER WHEN CROSSING OVER WATER MAIN.

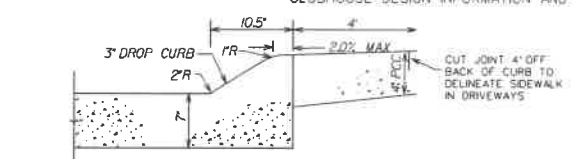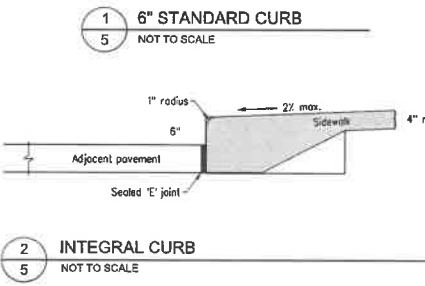

**3" ROLL CURB**  
NOT TO SCALE

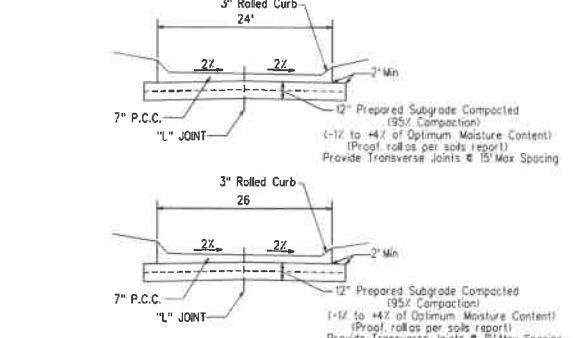

**TYPICAL PRIVATE STREET CROSS SECTION**  
NOT TO SCALE

- NOTES**
- SUBGRADE SHALL CONSIST OF A FIRM UNYIELDING CLAY (CL OR CH) OR CLASS "A" ROADSTONE BASE.
  - CONCRETE SHALL HAVE THE MIX DESIGN AS SHOWN FOR STREET PAVEMENT IN THE CONSTRUCTION PLACE TOPSIDE OVER ALL AREAS DISTURBED.
  - FINISH SHALL CONFORM TO STANDARD SPECIFICATIONS FOR SIDEWALKS AND PROVIDE FINAL BROOM FINISH.
  - CURING AS SPECIFIED FOR CONCRETE PAVEMENT IN THE STANDARD SPECIFICATIONS.
  - REBAR SHALL BE NON-EPOXY COATED STEEL AS PER THE STANDARD SPECIFICATIONS.

**DIMENSION AND UTILITY PLAN CONSTRUCTION NOTES**

- EXISTING FEATURES, PROTECT THE FOLLOWING:  
A. EXISTING PAVEMENTS TO REMAIN.  
B. EXISTING UTILITIES, ANY DAMAGES TO EXISTING UTILITIES THAT ARE NOT SCHEDULED FOR MODIFICATION OR DEMOLITION SHALL BE REPAIRED AT THE CONTRACTOR'S EXPENSE WITH THE WORK BEING PERFORMED TO THE UTILITY OWNER'S SPECIFICATIONS.
- DEMOLITION, REMOVE AND DISPOSE OF THE FOLLOWING:  
A. PAVEMENT, REMOVE EXISTING CURB SAWCUT TO FULL DEPTH. CONNECT WITH BD JOINT AS PER WEST DES MOINES DRAWING 7-19.  
B. REMOVE AND RELOCATE EXISTING UTILITIES, COORDINATE WITH UTILITY PROVIDER PRIOR TO CONSTRUCTION.
- PAVEMENTS, PROVIDE THE FOLLOWING:  
A. 7" DEPTH PCC PAVEMENT ON 12" DEPTH PREPARED SUBGRADE IN TWO 6" LIFTS COMPACTED TO 95% STANDARD PROCTOR DENSITY.  
B. 6" PCC FULL CURB  
C. 3" PCC ROLL CURB  
D. TAPER FROM FULL 6" CURB TO 3" ROLL CURB WHERE NOTED.  
E. PCC SIDEWALKS, 4" DEPTH PAVEMENT.  
F. PEDESTRIAN RAMP WITH A MAXIMUM SLOPE OF 8.33%.  
G. 5" DEPTH PCC DRIVEWAY.  
H. CLUSTER MAIL BOX PAD AS PER USPS SPECIFICATIONS AND REQUIREMENTS.  
I. 5" DEPTH PCC TRAIL ON 6" PREPARED SUBGRADE.  
J. INTEGRAL CURB AND 4" PCC SIDEWALK, SEE DETAIL.
- PAVEMENT MARKINGS, PROVIDE THE FOLLOWING:  
A. PAINTED PARKING STALL LINES.  
B. PAINTED STATE OF IOWA APPROVED ACCESSIBLE PARKING SYMBOL.  
C. ACCESSIBLE AISLE, 45° STRIPING AT 3' ON CENTER WHERE SHOWN.
- SIGNAGE, PROVIDE THE FOLLOWING:  
A. PROVIDE VAN ACCESSIBLE PARKING SIGNAGE AS PER ADAAG REQUIREMENTS.  
B. PROVIDE "ONE-WAY DO NOT ENTER" SIGNAGE.
- PRIVATE SANITARY SEWER SERVICE:  
A. PUBLIC SANITARY SEWER MAIN, SEE CONSTRUCTION DOCUMENTS FOR DETAILS.  
B. 4" SANITARY SEWER SERVICE LINE.  
C. 8" PRIVATE SANITARY SEWER MAIN.
- PRIVATE WATER SERVICE, PROVIDE THE FOLLOWING AS PER WEST DES MOINES WATER WORKS (WOMWW) RULES AND REGULATIONS:  
A. CONNECTION TO EXISTING 12" WATER MAIN WITH 8" TEE TAPPING VALVE AND SLEEVE.  
B. 8" PRIVATE WATER SERVICE LINE WITH FITTINGS AND BENDS AS NECESSARY, MINIMUM 5.5' DEEP.  
C. HYDRANT ASSEMBLY.  
D. 1" WATER SERVICE WITH CURB STOP.  
E. 8" VALVE.  
F. REMOVE AND RELOCATE EXISTING HYDRANT ASSEMBLY.  
G. RELOCATED HYDRANT ASSEMBLY.  
H. DIRECTIONAL BORE 8" WATER MAIN.  
I. 8"x8" CROSS.  
J. 8"x8" TEE.  
K. 45° BEND.  
L. CONNECT TO 12" WATER MAIN WITH 12"x8" REDUCER.
- COORDINATE NATURAL GAS AND ELECTRICAL SERVICES AND METER LOCATION WITH UTILITY SERVICE PROVIDER PRIOR TO CONSTRUCTION. SEE ARCHITECTURAL AND MECHANICAL PLANS FOR INTERIOR UTILITY ROUTING, METER LOCATION, DESIGN INFORMATION AND COORDINATE UTILITY CONNECTIONS ACCORDINGLY.
- CRITICAL CROSSING, CONTRACTOR TO VERIFY ALL CROSSINGS AND PROVIDE 18" MINIMUM SEPARATION.
- COORDINATE WITH COMMUNICATION LOCAL UTILITY PROVIDER FOR MC PHONE, CABLE AND INTERNET SERVICE PRIOR TO CONSTRUCTION.
- SEE ARCHITECTURAL PLANS FOR DETAILED POOL AND CLUBHOUSE DESIGN INFORMATION AND ELEVATIONS.




NO.	AS PER CITY COMMENTS	DATE	BY
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4	REVISED GRADES AND UTILITIES	8/17/19	KSS
3	AS PER CITY COMMENTS	7/19/19	KMM
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Engineer: KMM  
Checked By: EDC  
Date: 04/29/19  
Field No: 117.0693A  
Project No: 117.0693A  
Sheet 5 of 20

**COURTYARDS AT KINGS LANDING**  
**DIMENSION AND UTILITY PLAN**  
**SNYDER & ASSOCIATES, INC.**



Project No: 117.0693A  
Sheet 5 of 20

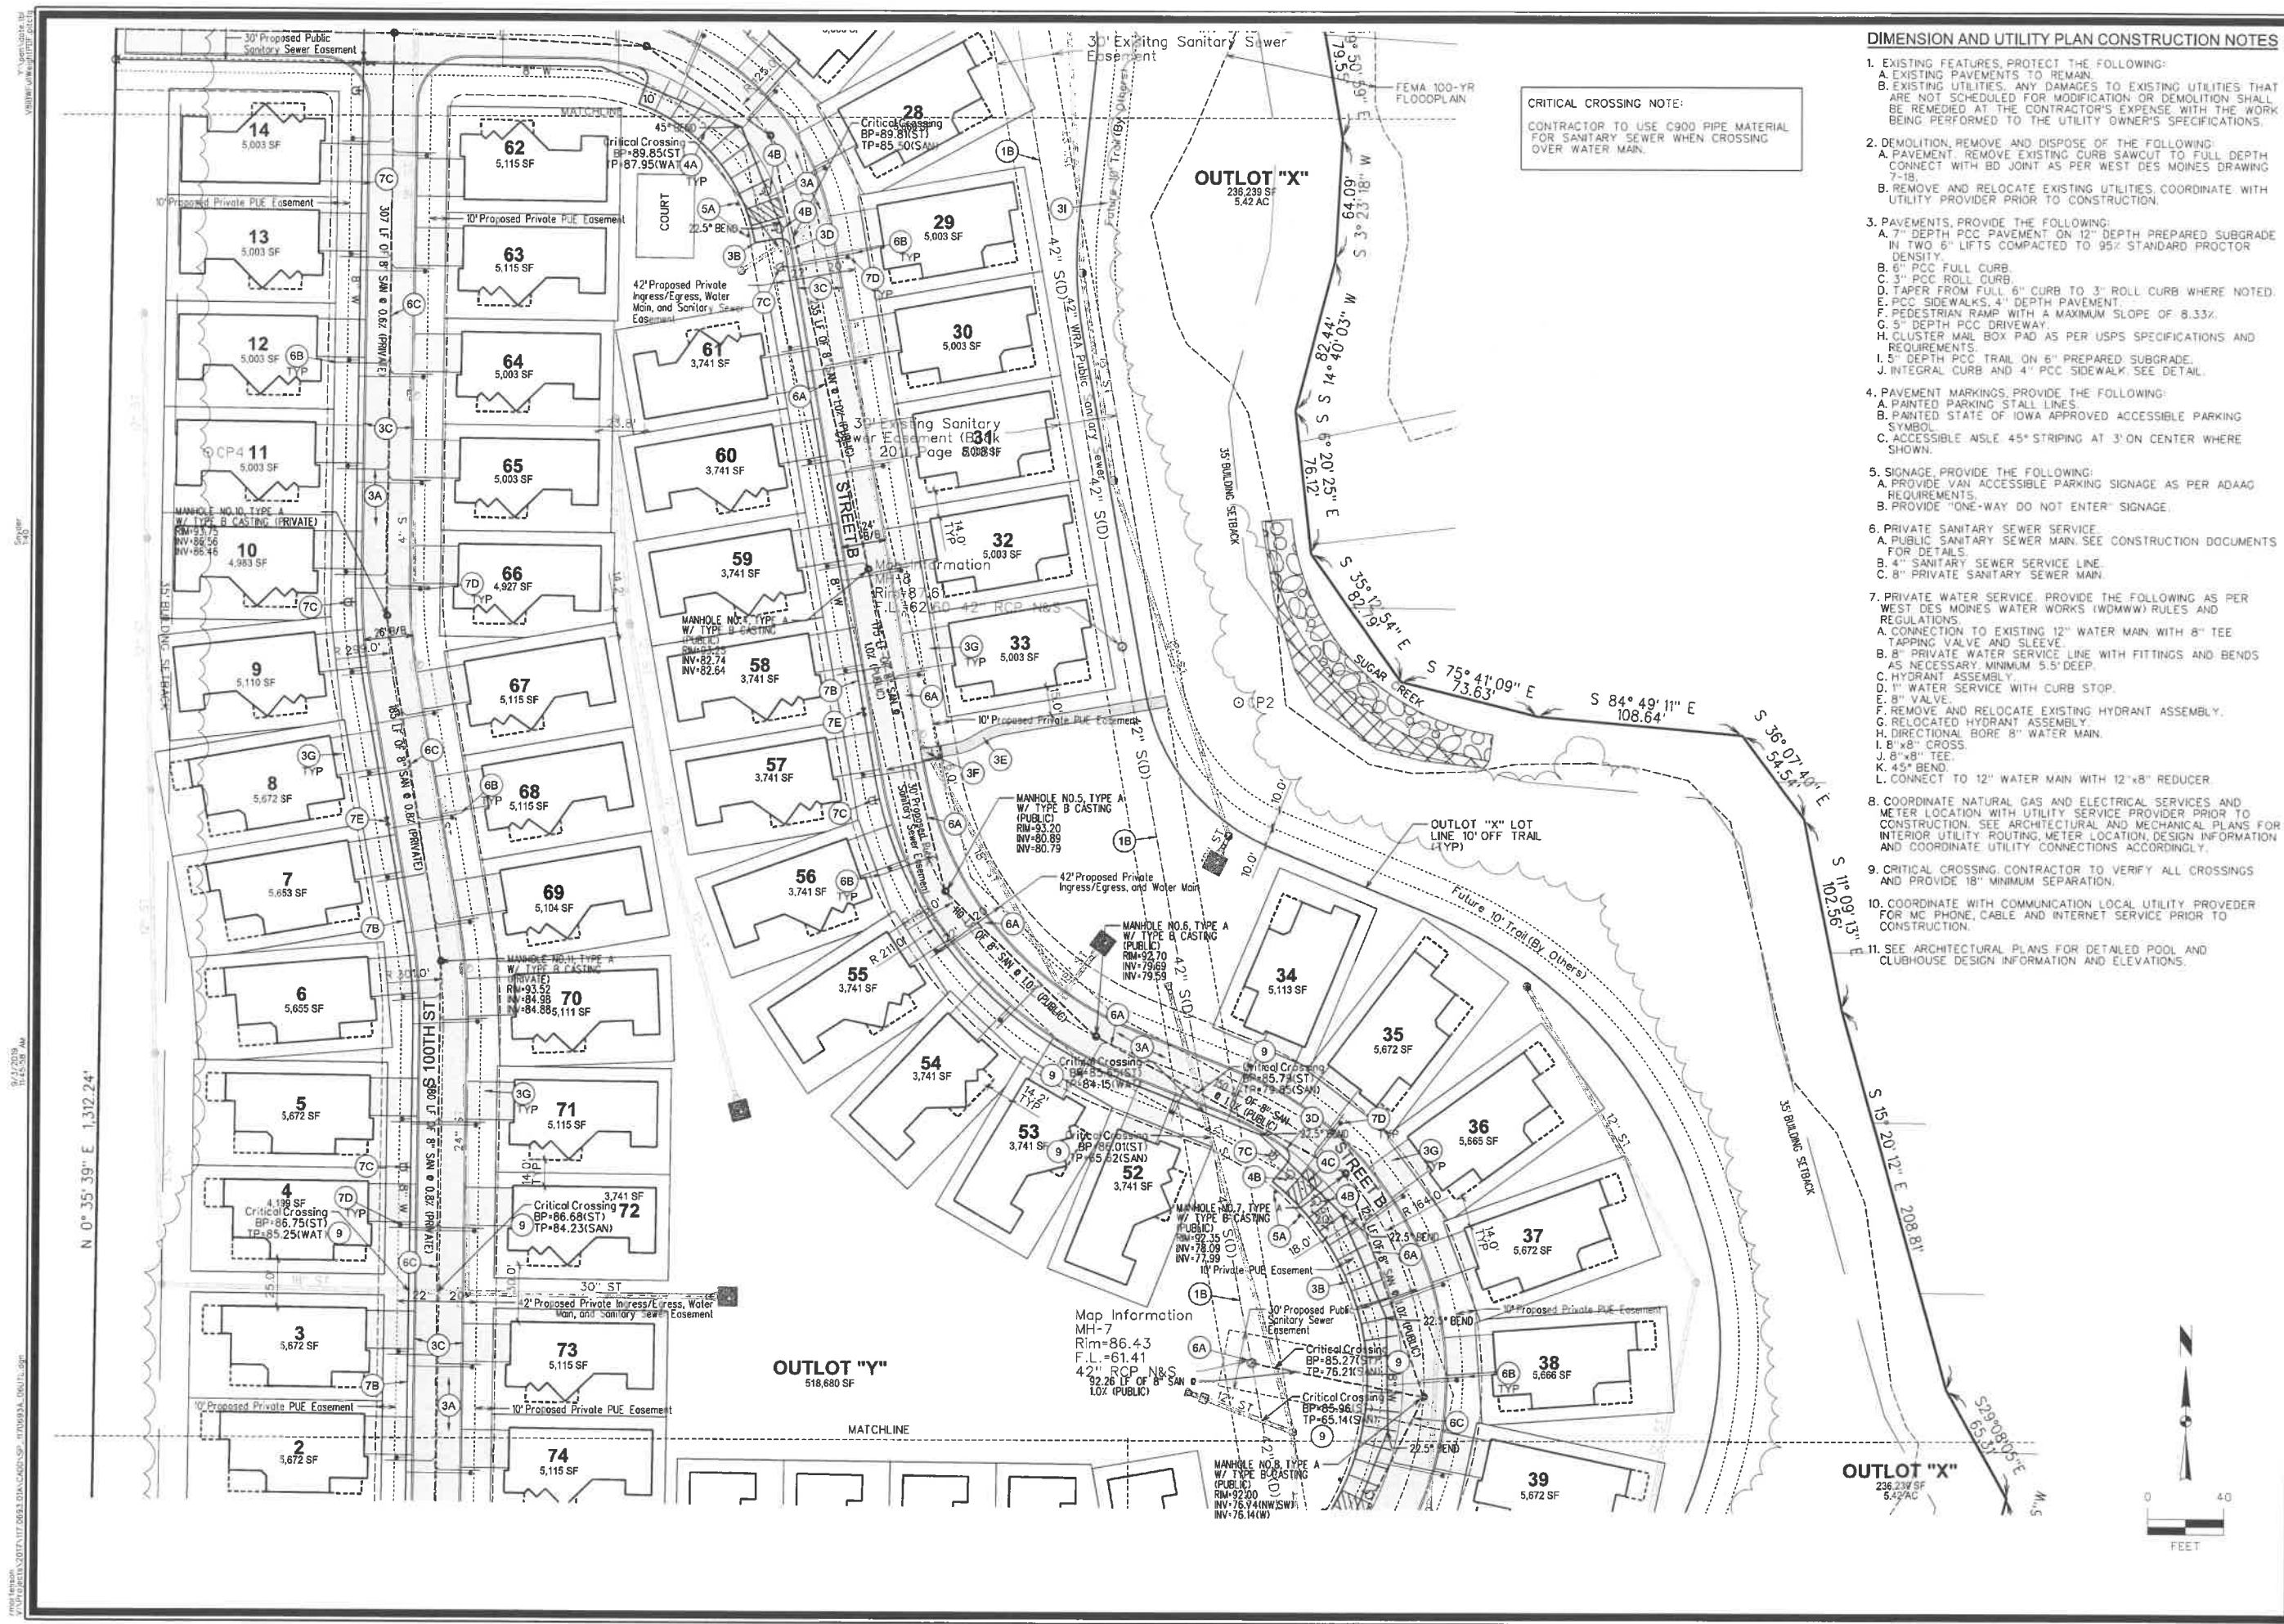

**DIMENSION AND UTILITY PLAN CONSTRUCTION NOTES**

- EXISTING FEATURES, PROTECT THE FOLLOWING:
  - EXISTING PAVEMENTS TO REMAIN.
  - EXISTING UTILITIES, ANY DAMAGES TO EXISTING UTILITIES THAT ARE NOT SCHEDULED FOR MODIFICATION OR DEMOLITION SHALL BE REMEDIATED AT THE CONTRACTOR'S EXPENSE WITH THE WORK BEING PERFORMED TO THE UTILITY OWNER'S SPECIFICATIONS.
- DEMOLITION, REMOVE AND DISPOSE OF THE FOLLOWING:
  - PAVEMENT, REMOVE EXISTING CURB SAWCUT TO FULL DEPTH CONNECT WITH BD JOINT AS PER WEST DES MOINES DRAWING 7-18.
  - REMOVE AND RELOCATE EXISTING UTILITIES, COORDINATE WITH UTILITY PROVIDER PRIOR TO CONSTRUCTION.
- PAVEMENTS, PROVIDE THE FOLLOWING:
  - 7" DEPTH PCC PAVEMENT ON 12" DEPTH PREPARED SUBGRADE IN TWO 6" LIFTS COMPACTED TO 95% STANDARD PROCTOR DENSITY.
  - 6" PCC FULL CURB.
  - 3" PCC ROLL CURB.
  - TAPER FROM FULL 6" CURB TO 3" ROLL CURB WHERE NOTED.
  - PCC SIDEWALKS, 4" DEPTH PAVEMENT.
  - PEDESTRIAN RAMP WITH A MAXIMUM SLOPE OF 8.33%.
  - 5" DEPTH PCC DRIVEWAY.
  - CLUSTER MAIL BOX PAD AS PER USPS SPECIFICATIONS AND REQUIREMENTS.
  - 5" DEPTH PCC TRAIL ON 6" PREPARED SUBGRADE.
  - INTEGRAL CURB AND 4" PCC SIDEWALK, SEE DETAIL.
- PAVEMENT MARKINGS, PROVIDE THE FOLLOWING:
  - PAINTED PARKING STALL LINES.
  - PAINTED STATE OF IOWA APPROVED ACCESSIBLE PARKING SYMBOL.
  - ACCESSIBLE WALK 45° STRIPING AT 3' ON CENTER WHERE SHOWN.
- SIGNAGE, PROVIDE THE FOLLOWING:
  - PROVIDE VAN ACCESSIBLE PARKING SIGNAGE AS PER ADAAG REQUIREMENTS.
  - PROVIDE "ONE-WAY DO NOT ENTER" SIGNAGE.
- PRIVATE SANITARY SEWER SERVICE
  - PUBLIC SANITARY SEWER MAIN, SEE CONSTRUCTION DOCUMENTS FOR DETAILS.
  - 4" SANITARY SEWER SERVICE LINE.
  - 8" PRIVATE SANITARY SEWER MAIN.
- PRIVATE WATER SERVICE, PROVIDE THE FOLLOWING AS PER WEST DES MOINES WATER WORKS (WDMWW) RULES AND REGULATIONS.
  - CONNECTION TO EXISTING 12" WATER MAIN WITH 8" TEE TAPPING VALVE AND SLEEVE.
  - 8" PRIVATE WATER SERVICE LINE WITH FITTINGS AND BENDS AS NECESSARY, MINIMUM 5.5' DEEP.
  - HYDRANT ASSEMBLY.
  - 1" WATER SERVICE WITH CURB STOP.
  - 8" VALVE.
  - REMOVE AND RELOCATE EXISTING HYDRANT ASSEMBLY.
  - RELOCATED HYDRANT ASSEMBLY.
  - DIRECTIONAL BORE 8" WATER MAIN.
  - 8"x8" CROSS.
  - 45° BEND.
  - CONNECT TO 12" WATER MAIN WITH 12"x8" REDUCER.
- COORDINATE NATURAL GAS AND ELECTRICAL SERVICES AND METER LOCATION WITH UTILITY SERVICE PROVIDER PRIOR TO CONSTRUCTION, SEE ARCHITECTURAL AND MECHANICAL PLANS FOR INTERIOR UTILITY ROUTING, METER LOCATION, DESIGN INFORMATION AND COORDINATE UTILITY CONNECTIONS ACCORDINGLY.
- CRITICAL CROSSING, CONTRACTOR TO VERIFY ALL CROSSINGS AND PROVIDE 18" MINIMUM SEPARATION.
- COORDINATE WITH COMMUNICATION LOCAL UTILITY PROVIDER FOR PHONE, CABLE AND INTERNET SERVICE PRIOR TO CONSTRUCTION.
- SEE ARCHITECTURAL PLANS FOR DETAILED POOL AND CLUBHOUSE DESIGN INFORMATION AND ELEVATIONS.

MARK	REVISION	DATE	BY
5	AS PER CITY COMMENTS	9/3/19	RMM
4	REVISED GRADES AND UTILITIES	8/12/19	KSS
3	AS PER CITY COMMENTS	7/19/19	RMM
2	AS PER CITY COMMENTS	7/10/19	RMM

Engineer: RMM  
 Checked By: EDC  
 Scale: 1"=40'  
 Date: 04/29/19  
 Field No: 117.0693A  
 Project No: 117.0693A

**WEST DES MOINES, IA**

**COURTYARDS AT KINGS LANDING**

**DIMENSION AND UTILITY PLAN**

**SNYDER & ASSOCIATES, INC.**


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 ANKENY, IOWA 50023  
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**DIMENSION AND UTILITY PLAN CONSTRUCTION NOTES**


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  - A. EXISTING PAVEMENTS TO REMAIN.
  - B. EXISTING UTILITIES. ANY DAMAGES TO EXISTING UTILITIES THAT ARE NOT SCHEDULED FOR MODIFICATION OR DEMOLITION SHALL BE REMEDIATED AT THE CONTRACTOR'S EXPENSE WITH THE WORK BEING PERFORMED TO THE UTILITY OWNER'S SPECIFICATIONS.
2. DEMOLITION, REMOVE AND DISPOSE OF THE FOLLOWING:
  - A. PAVEMENT. REMOVE EXISTING CURB SAWCUT TO FULL DEPTH CONNECT WITH BD JOINT AS PER WEST DES MOINES DRAWING 7-18.
  - B. REMOVE AND RELOCATE EXISTING UTILITIES. COORDINATE WITH UTILITY PROVIDER PRIOR TO CONSTRUCTION.
3. PAVEMENTS, PROVIDE THE FOLLOWING:
  - A. 7" DEPTH PCC PAVEMENT ON 12" DEPTH PREPARED SUBGRADE IN TWO 6" LIFTS COMPACTED TO 95% STANDARD PROCTOR DENSITY.
  - B. 6" PCC FULL CURB.
  - C. 3" PCC ROLL CURB.
  - D. TAPER FROM FULL 6" CURB TO 3" ROLL CURB WHERE NOTED.
  - E. PCC SIDEWALKS, 4" DEPTH PAVEMENT.
  - F. PEDESTRIAN RAMP WITH A MAXIMUM SLOPE OF 8.33%.
  - G. 5" DEPTH PCC DRIVEWAY.
  - H. CLUSTER MAIL BOX PAD AS PER USPS SPECIFICATIONS AND REQUIREMENTS.
  - I. 5" DEPTH PCC TRAIL ON 6" PREPARED SUBGRADE.
  - J. INTEGRAL CURB AND 4" PCC SIDEWALK. SEE DETAIL.
4. PAVEMENT MARKINGS, PROVIDE THE FOLLOWING:
  - A. PAINTED PARKING STALL LINES.
  - B. PAINTED STATE OF IOWA APPROVED ACCESSIBLE PARKING SYMBOL.
  - C. ACCESSIBLE AISLE, 45° STRIPING AT 3' ON CENTER WHERE SHOWN.
5. SIGNAGE, PROVIDE THE FOLLOWING:
  - A. PROVIDE VAN ACCESSIBLE PARKING SIGNAGE AS PER ADAAG REQUIREMENTS.
  - B. PROVIDE "ONE-WAY DO NOT ENTER" SIGNAGE.
6. PRIVATE SANITARY SEWER SERVICE.
  - A. PUBLIC SANITARY SEWER MAIN. SEE CONSTRUCTION DOCUMENTS FOR DETAILS.
  - B. 4" SANITARY SEWER SERVICE LINE.
  - C. 8" PRIVATE SANITARY SEWER MAIN.
7. PRIVATE WATER SERVICE, PROVIDE THE FOLLOWING AS PER WEST DES MOINES WATER WORKS (WDWWW) RULES AND REGULATIONS.
  - A. CONNECTION TO EXISTING 12" WATER MAIN WITH 8" TEE TAPPING VALVE AND SLEEVE.
  - B. 8" PRIVATE WATER SERVICE LINE WITH FITTINGS AND BENDS AS NECESSARY. MINIMUM 5.5' DEEP.
  - C. HYDRANT ASSEMBLY.
  - D. 1" WATER SERVICE WITH CURB STOP.
  - E. 8" VALVE.
  - F. REMOVE AND RELOCATE EXISTING HYDRANT ASSEMBLY.
  - G. RELOCATED HYDRANT ASSEMBLY.
  - H. DIRECTIONAL BORE 8" WATER MAIN.
  - I. 8"x8" CROSS.
  - J. 8"x8" TEE.
  - K. 45° BEND.
  - L. CONNECT TO 12" WATER MAIN WITH 12"x8" REDUCER.
8. COORDINATE NATURAL GAS AND ELECTRICAL SERVICES AND METER LOCATION WITH UTILITY SERVICE PROVIDER PRIOR TO CONSTRUCTION. SEE ARCHITECTURAL AND MECHANICAL PLANS FOR INTERIOR UTILITY ROUTING, METER LOCATION, DESIGN INFORMATION AND COORDINATE UTILITY CONNECTIONS ACCORDINGLY.
9. CRITICAL CROSSING CONTRACTOR TO VERIFY ALL CROSSINGS AND PROVIDE 18" MINIMUM SEPARATION.
10. COORDINATE WITH COMMUNICATION LOCAL UTILITY PROVIDER FOR MC PHONE, CABLE AND INTERNET SERVICE PRIOR TO CONSTRUCTION.
11. SEE ARCHITECTURAL PLANS FOR DETAILED POOL AND CLUBHOUSE DESIGN INFORMATION AND ELEVATIONS.

CRITICAL CROSSING NOTE:  
 CONTRACTOR TO USE C900 PIPE MATERIAL FOR SANITARY SEWER WHEN CROSSING OVER WATER MAIN.



<b>WEST DES MOINES, IA</b> DIMENSION AND UTILITY PLAN	2727 S.W. SNYDER BLVD. ANKENY, IOWA 50023 515-964-2020   www.snyder-associates.com	<b>COURTYARDS AT KINGS LANDING</b> DIMENSION AND UTILITY PLAN <b>SNYDER &amp; ASSOCIATES, INC.</b>	Project No: 117.0693A Sheet 7 of 20	Sheet 7 of 20
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 Project: 117.0693A - COURTYARDS AT KINGS LANDING

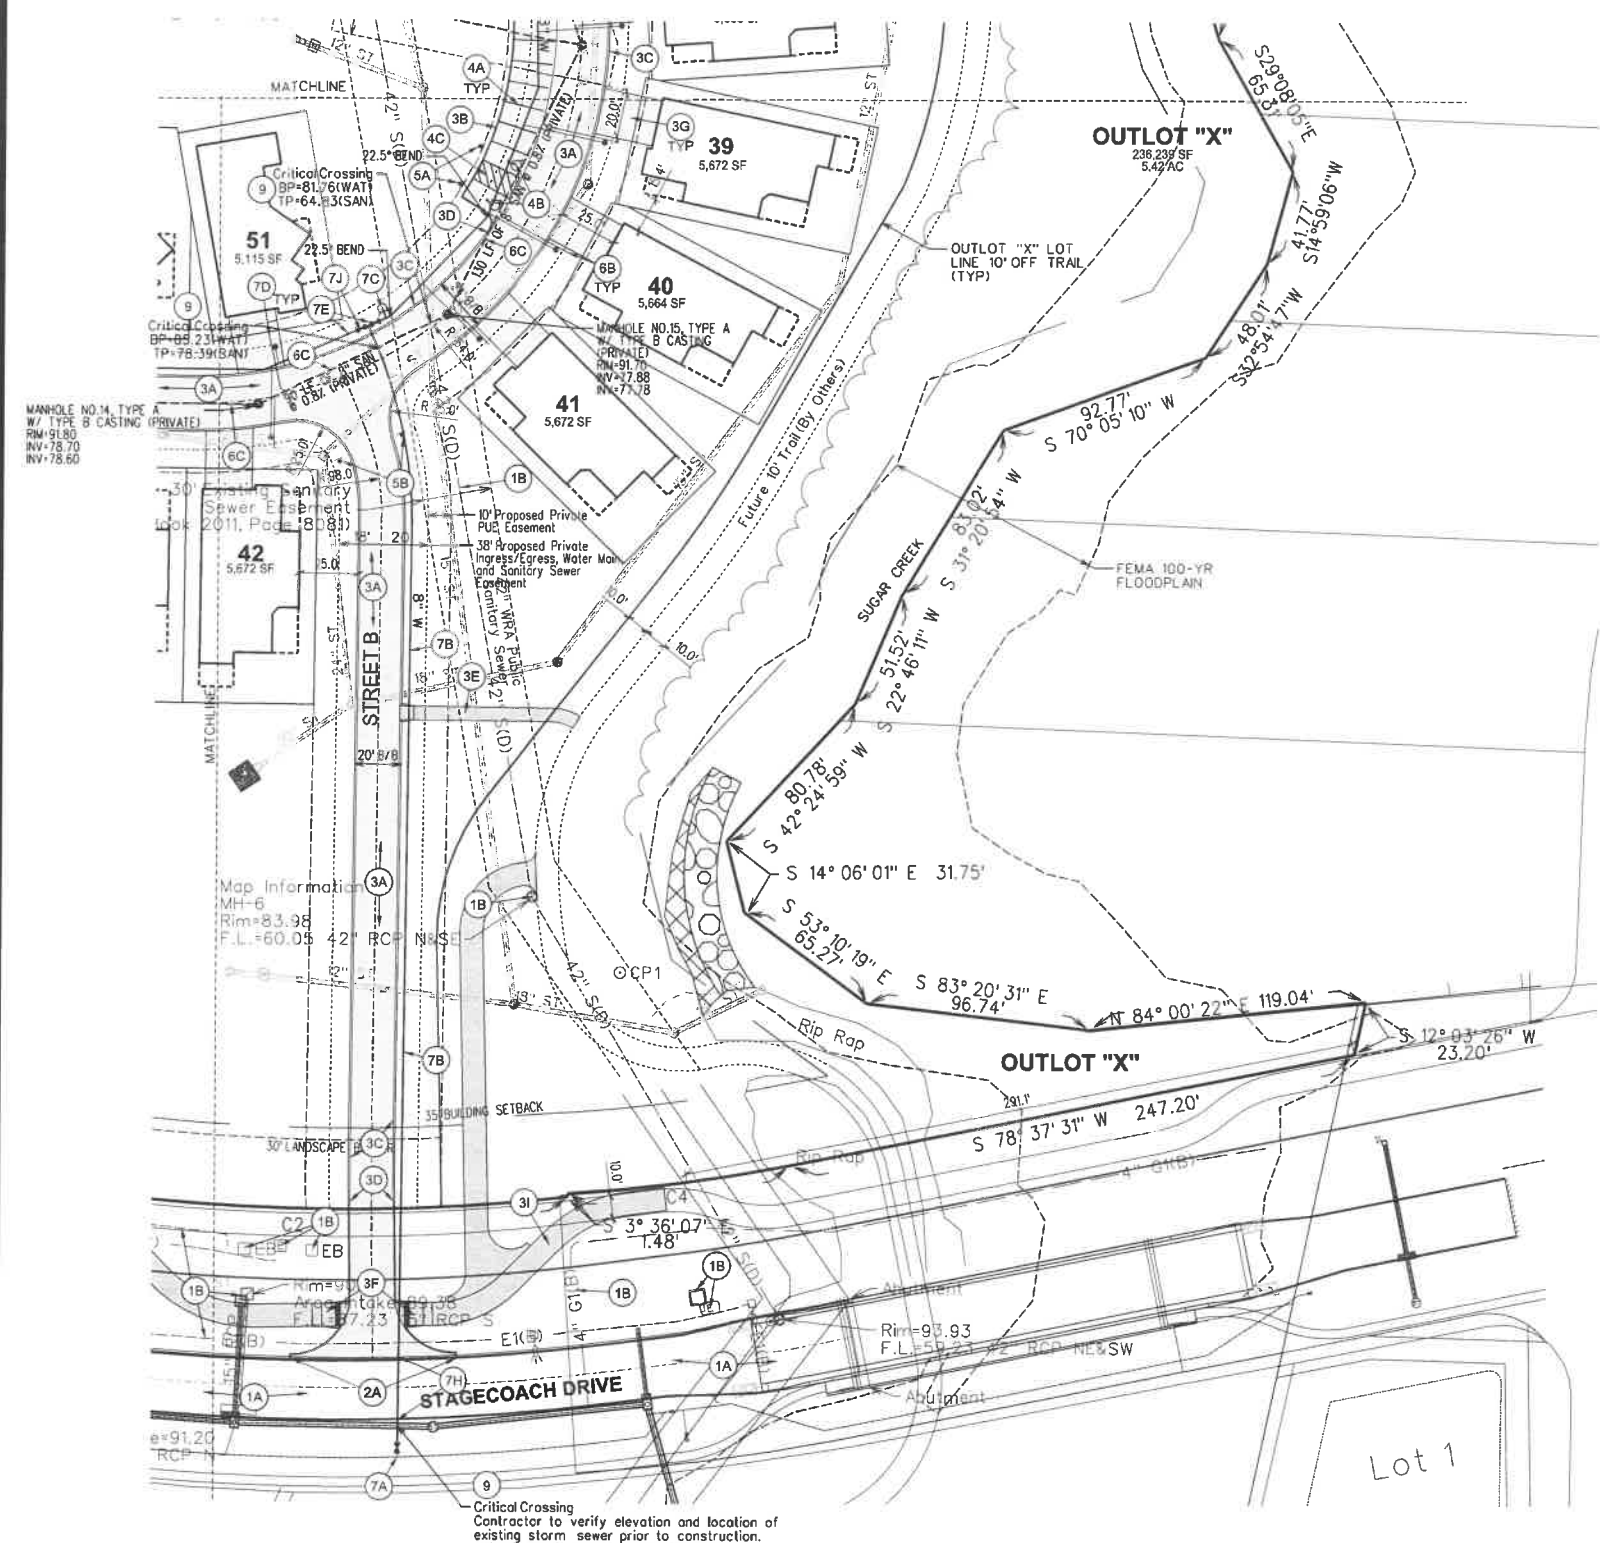

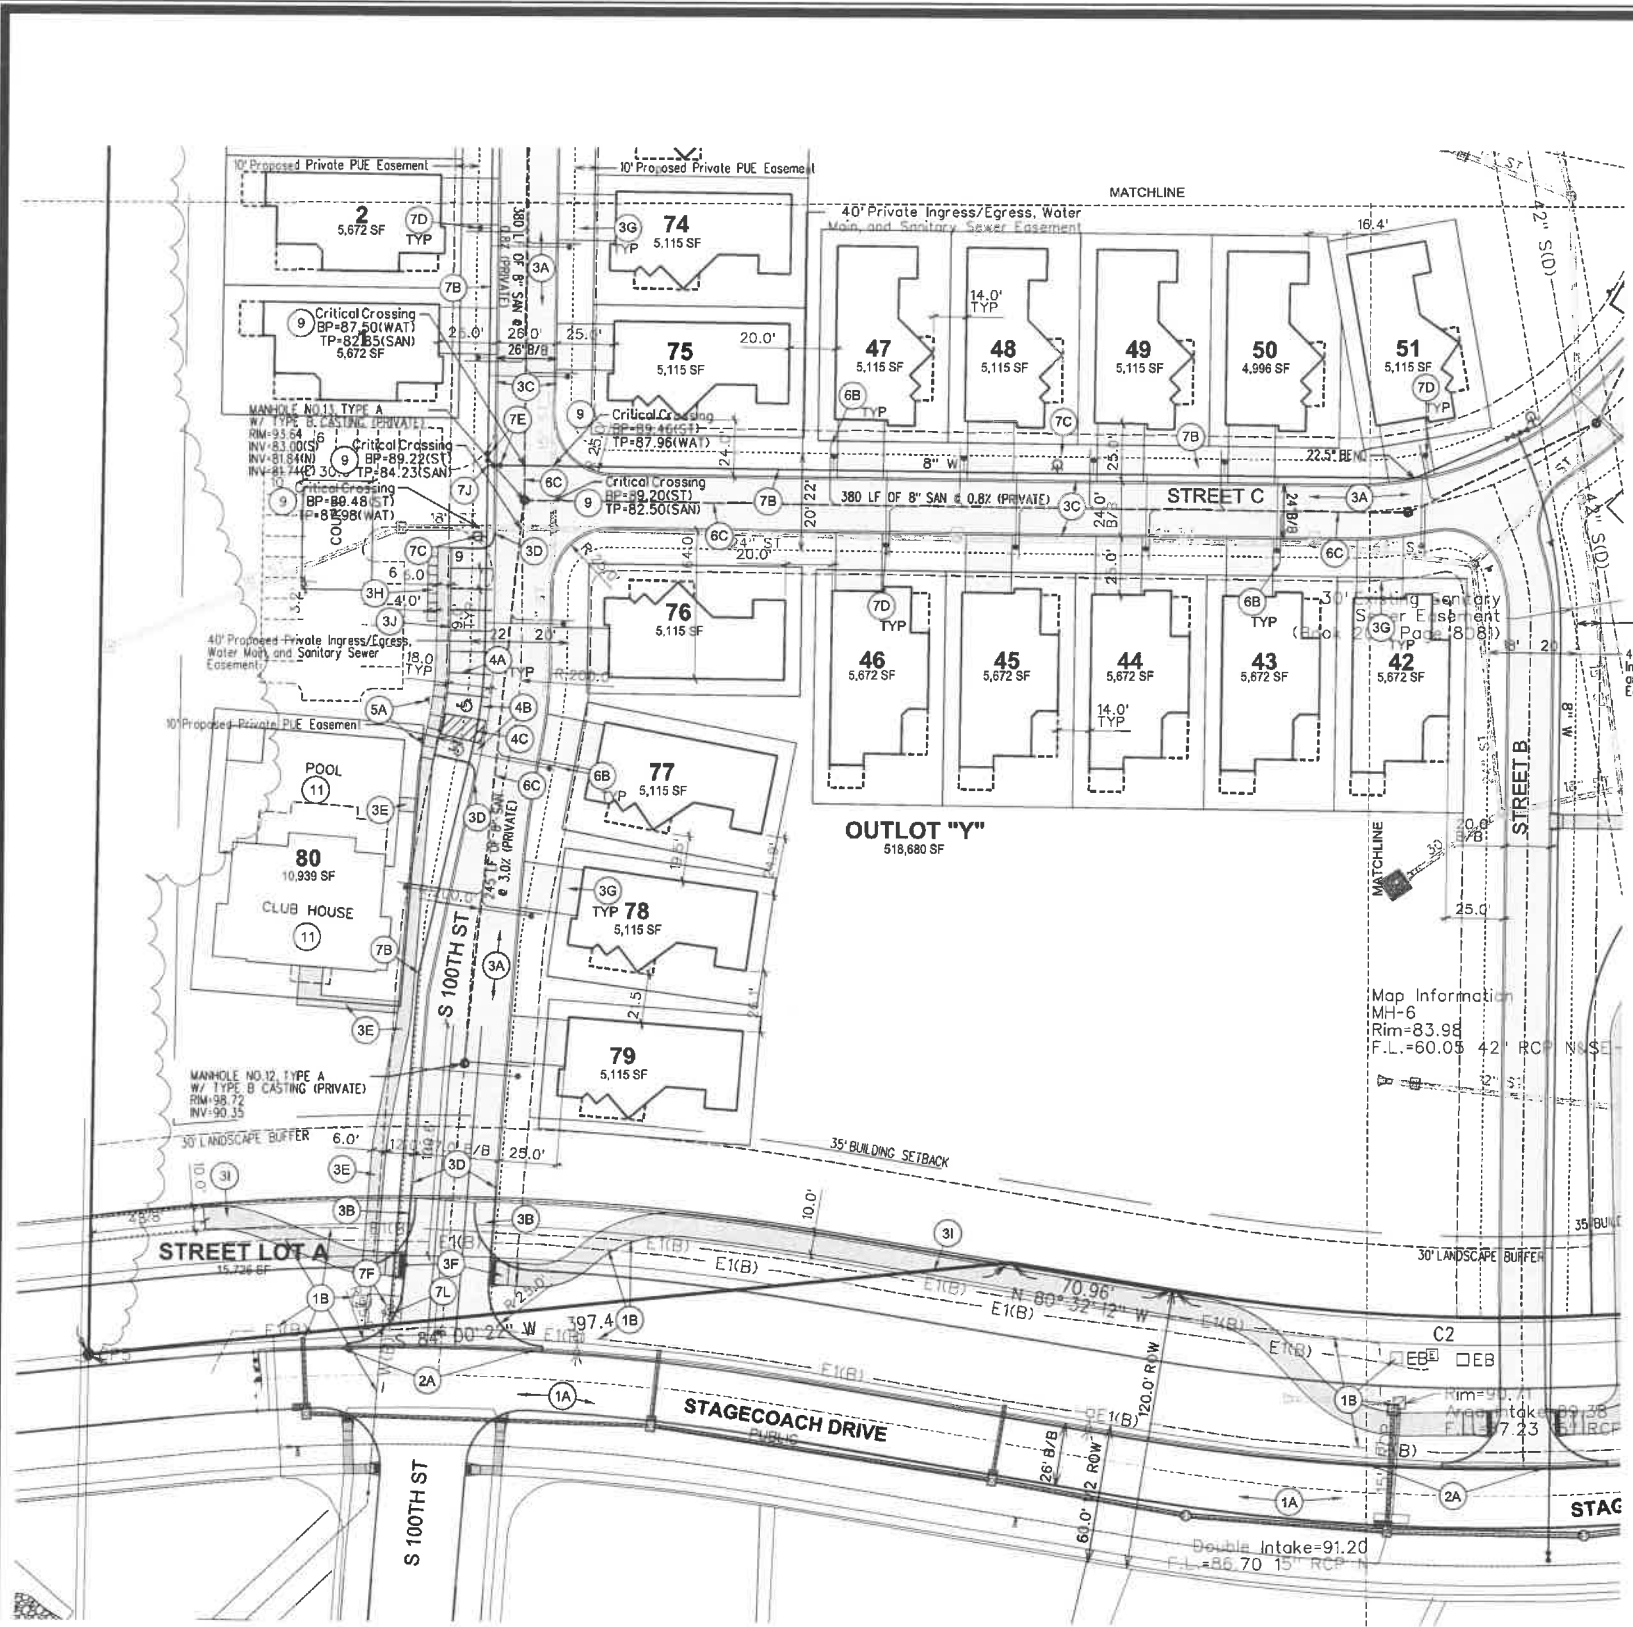**DIMENSION AND UTILITY PLAN CONSTRUCTION NOTES**

1. EXISTING FEATURES, PROTECT THE FOLLOWING:
  - A. EXISTING PAVEMENTS TO REMAIN.
  - B. EXISTING UTILITIES. ANY DAMAGES TO EXISTING UTILITIES THAT ARE NOT SCHEDULED FOR MODIFICATION OR DEMOLITION SHALL BE REMEDIATED AT THE CONTRACTOR'S EXPENSE WITH THE WORK BEING PERFORMED TO THE UTILITY OWNER'S SPECIFICATIONS.
2. DEMOLITION, REMOVE AND DISPOSE OF THE FOLLOWING:
  - A. PAVEMENT. REMOVE EXISTING CURB SAWCUT TO FULL DEPTH. CONNECT WITH BD JOINT AS PER WEST DES MOINES DRAWING 7-18.
  - B. REMOVE AND RELOCATE EXISTING UTILITIES. COORDINATE WITH UTILITY PROVIDER PRIOR TO CONSTRUCTION.
3. PAVEMENTS, PROVIDE THE FOLLOWING:
  - A. 7" DEPTH PCC PAVEMENT ON 12" DEPTH PREPARED SUBGRADE IN 2" TWG 6" LIFTS COMPACTED TO 95% STANDARD PROCTOR DENSITY.
  - B. 6" PCC FULL CURB.
  - C. 3" PCC ROLL CURB.
  - D. TAPER FROM FULL 6" CURB TO 3" ROLL CURB WHERE NOTED.
  - E. PCC SIDEWALKS, 4" DEPTH PAVEMENT.
  - F. PEDESTRIAN RAMP WITH A MAXIMUM SLOPE OF 8.33%.
  - G. 5" DEPTH PCC DRIVEWAY.
  - H. CLUSTER MAIL BOX PAD AS PER USPS SPECIFICATIONS AND REQUIREMENTS.
  - I. 5" DEPTH PCC TRAIL ON 6" PREPARED SUBGRADE.
  - J. INTEGRAL CURB AND 4" PCC SIDEWALK. SEE DETAIL.
4. PAVEMENT MARKINGS, PROVIDE THE FOLLOWING:
  - A. PAINTED PARKING STALL LINES.
  - B. PAINTED STATE OF IOWA APPROVED ACCESSIBLE PARKING SYMBOL.
  - C. ACCESSIBLE AISLE 45° STRIPING AT 3' ON CENTER WHERE SHOWN.
5. SIGNAGE, PROVIDE THE FOLLOWING:
  - A. PROVIDE VAN ACCESSIBLE PARKING SIGNAGE AS PER ADAAG REQUIREMENTS.
  - B. PROVIDE "ONE-WAY DO NOT ENTER" SIGNAGE.
6. PRIVATE SANITARY SEWER SERVICE.
  - A. PUBLIC SANITARY SEWER MAIN. SEE CONSTRUCTION DOCUMENTS FOR DETAILS.
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  - C. 8" PRIVATE SANITARY SEWER MAIN.
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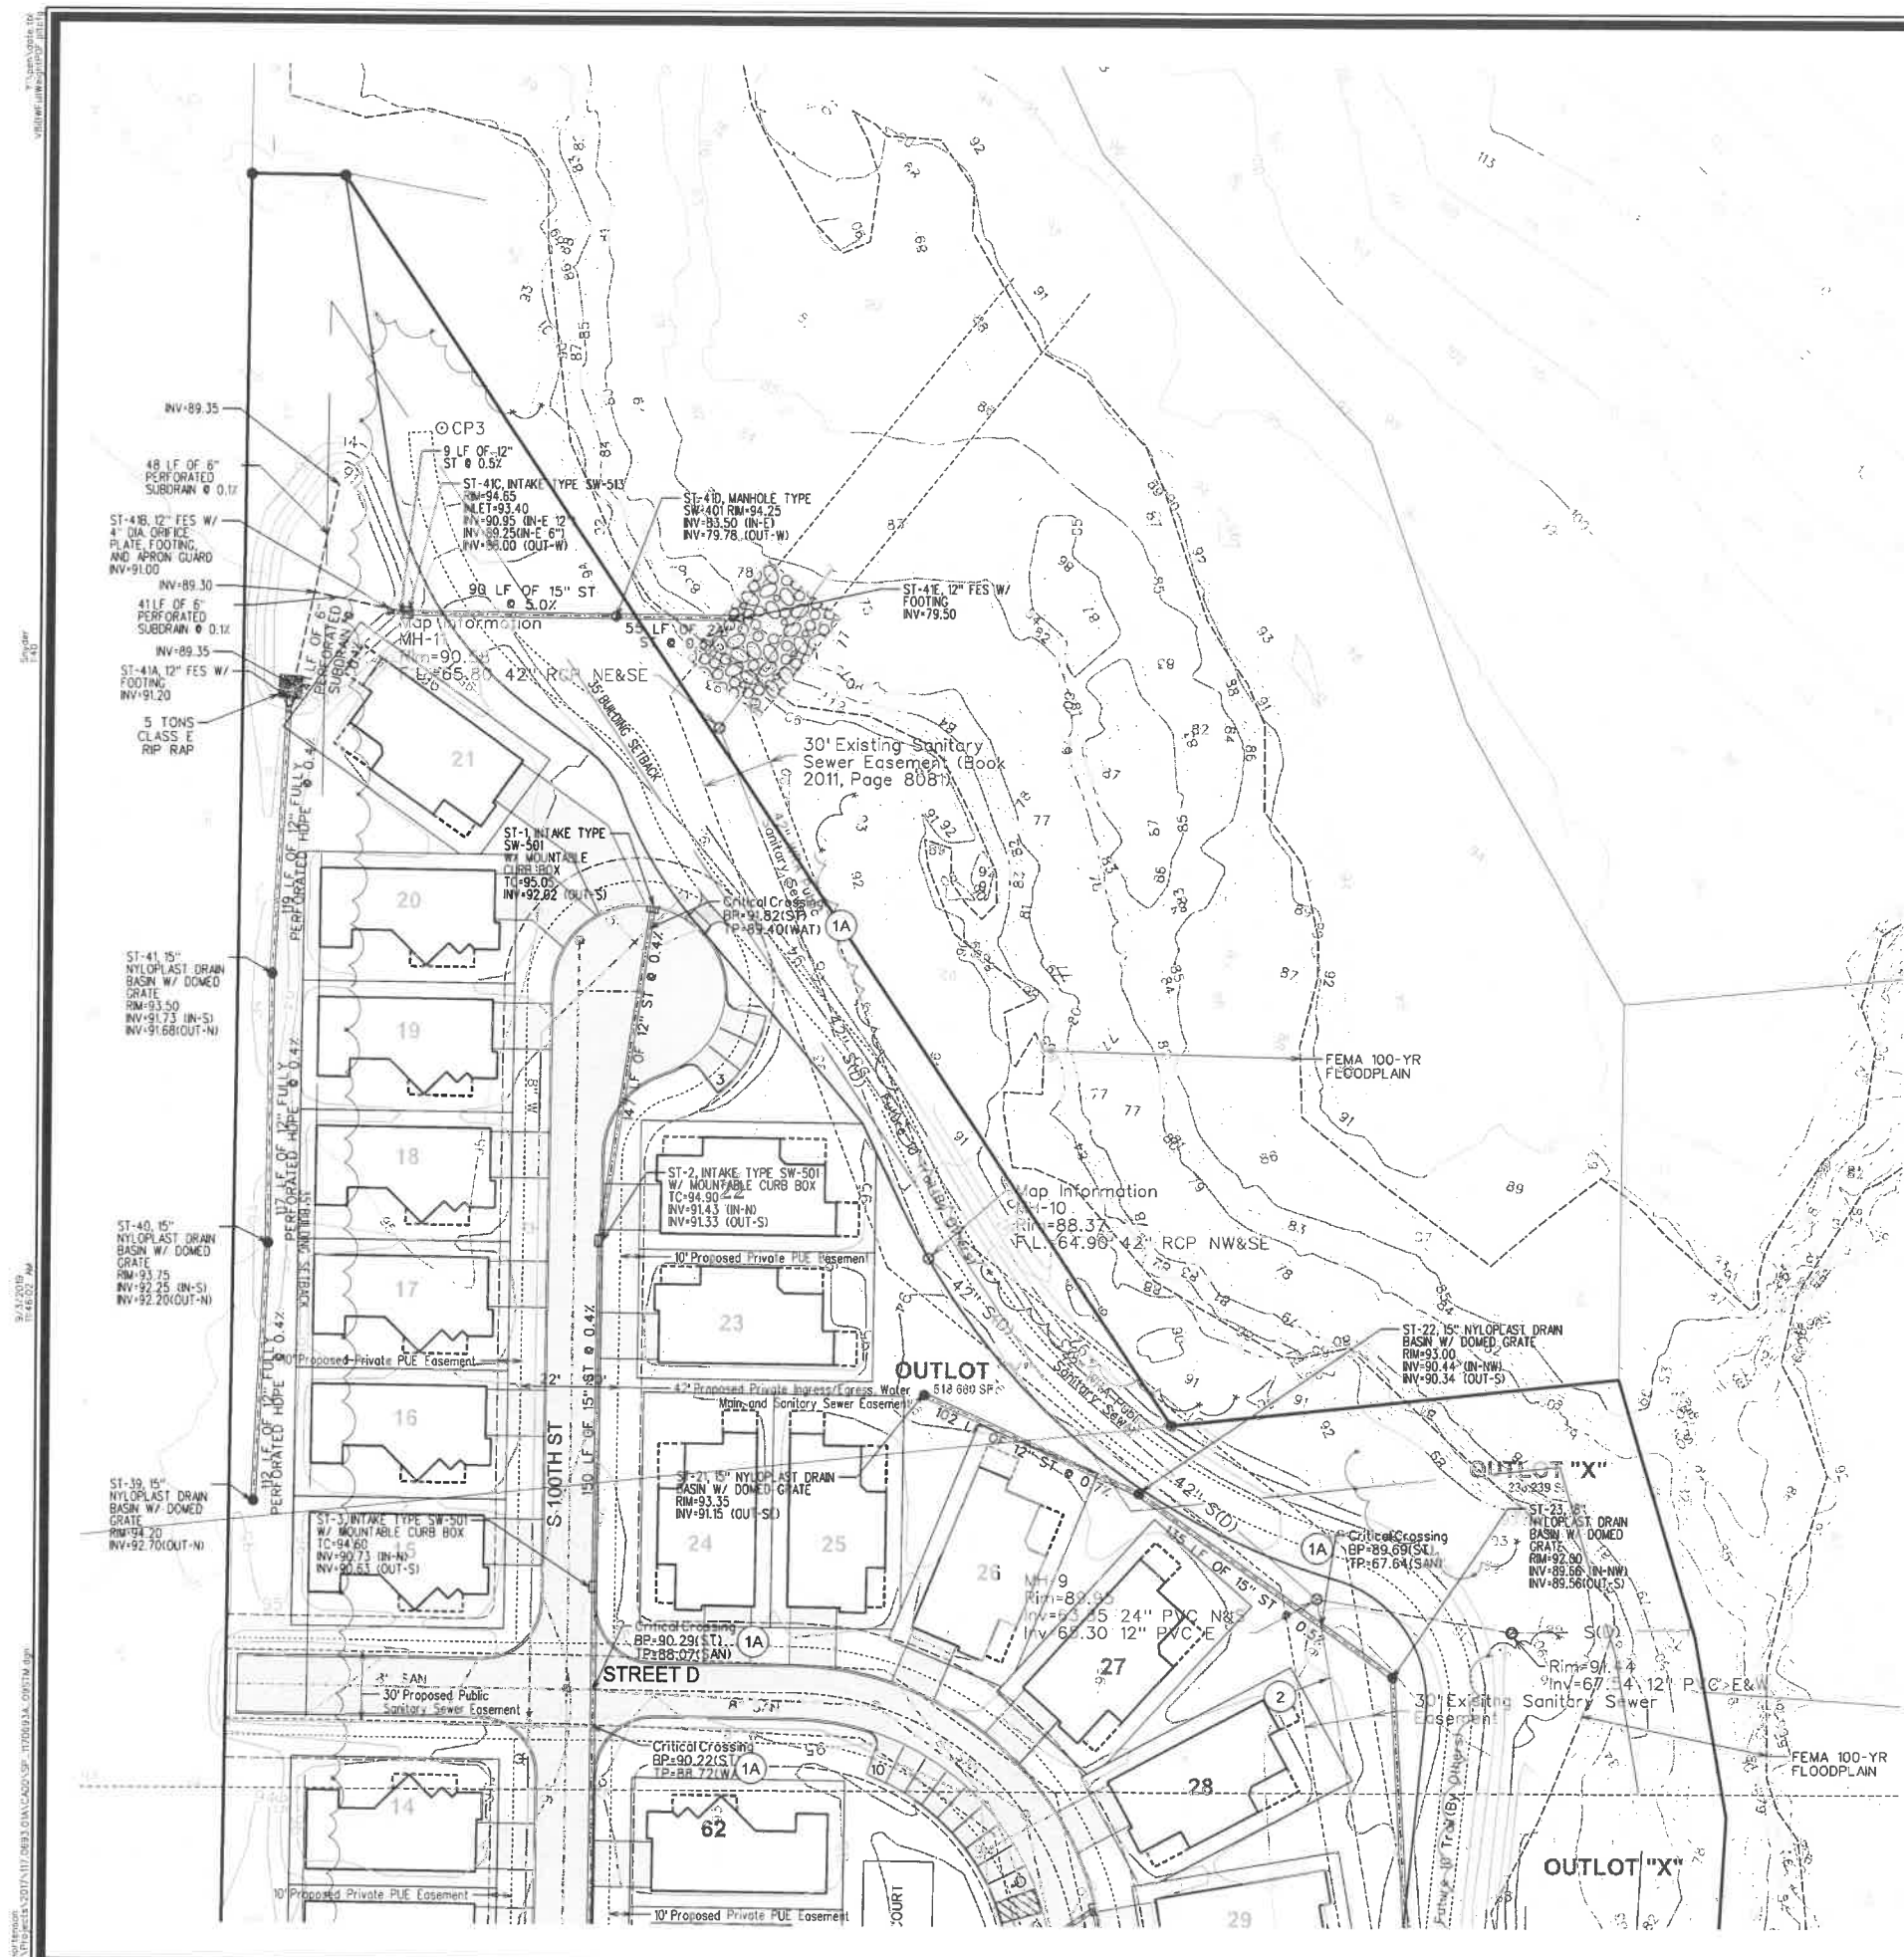
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4	8/17/19	KSS	REVISED GRADES AND UTILITIES
3	7/19/19	MM	AS PER CITY COMMENTS
2	7/10/19	MM	AS PER CITY COMMENTS

Engineer: KMM  
 Checked By: EDC  
 Scale: 1"=40'  
 Technician: RMM  
 Date: 04/29/19  
 Field No: 117.0693A

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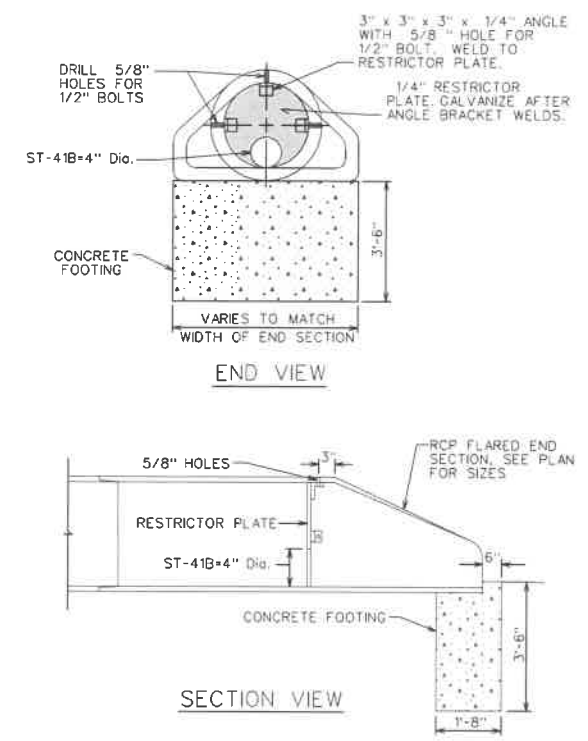
**COURTYARDS AT KINGS LANDING**  
 DIMENSION AND UTILITY PLAN  
**SNYDER & ASSOCIATES, INC.**





**STORM SEWER PLAN CONSTRUCTION NOTES**

- PROVIDE STORM SEWER IMPROVEMENTS AS SHOWN ON THE PLANS, AS PER CITY OF WEST DES MOINES STANDARDS.  
 A. CONTRACTOR TO VERIFY ALL UTILITY CROSSINGS AND MAINTAIN A MINIMUM OF 18" SEPARATION IN LOCATIONS WHERE WATER MAIN IS TO BE PLACED BELOW SEWER, SEWER IS TO BE GASKETED JOINTS TO WITHIN 10' OF WATER MAIN CROSSINGS.
- PROTECT EXISTING UTILITIES. ANY DAMAGES TO EXISTING UTILITIES THAT ARE NOT SCHEDULED FOR MODIFICATION OR DEMOLITION SHALL BE REMEDIATED AT THE CONTRACTOR'S EXPENSE WITH THE WORK BEING PERFORMED TO THE UTILITY OWNER'S SPECIFICATIONS.



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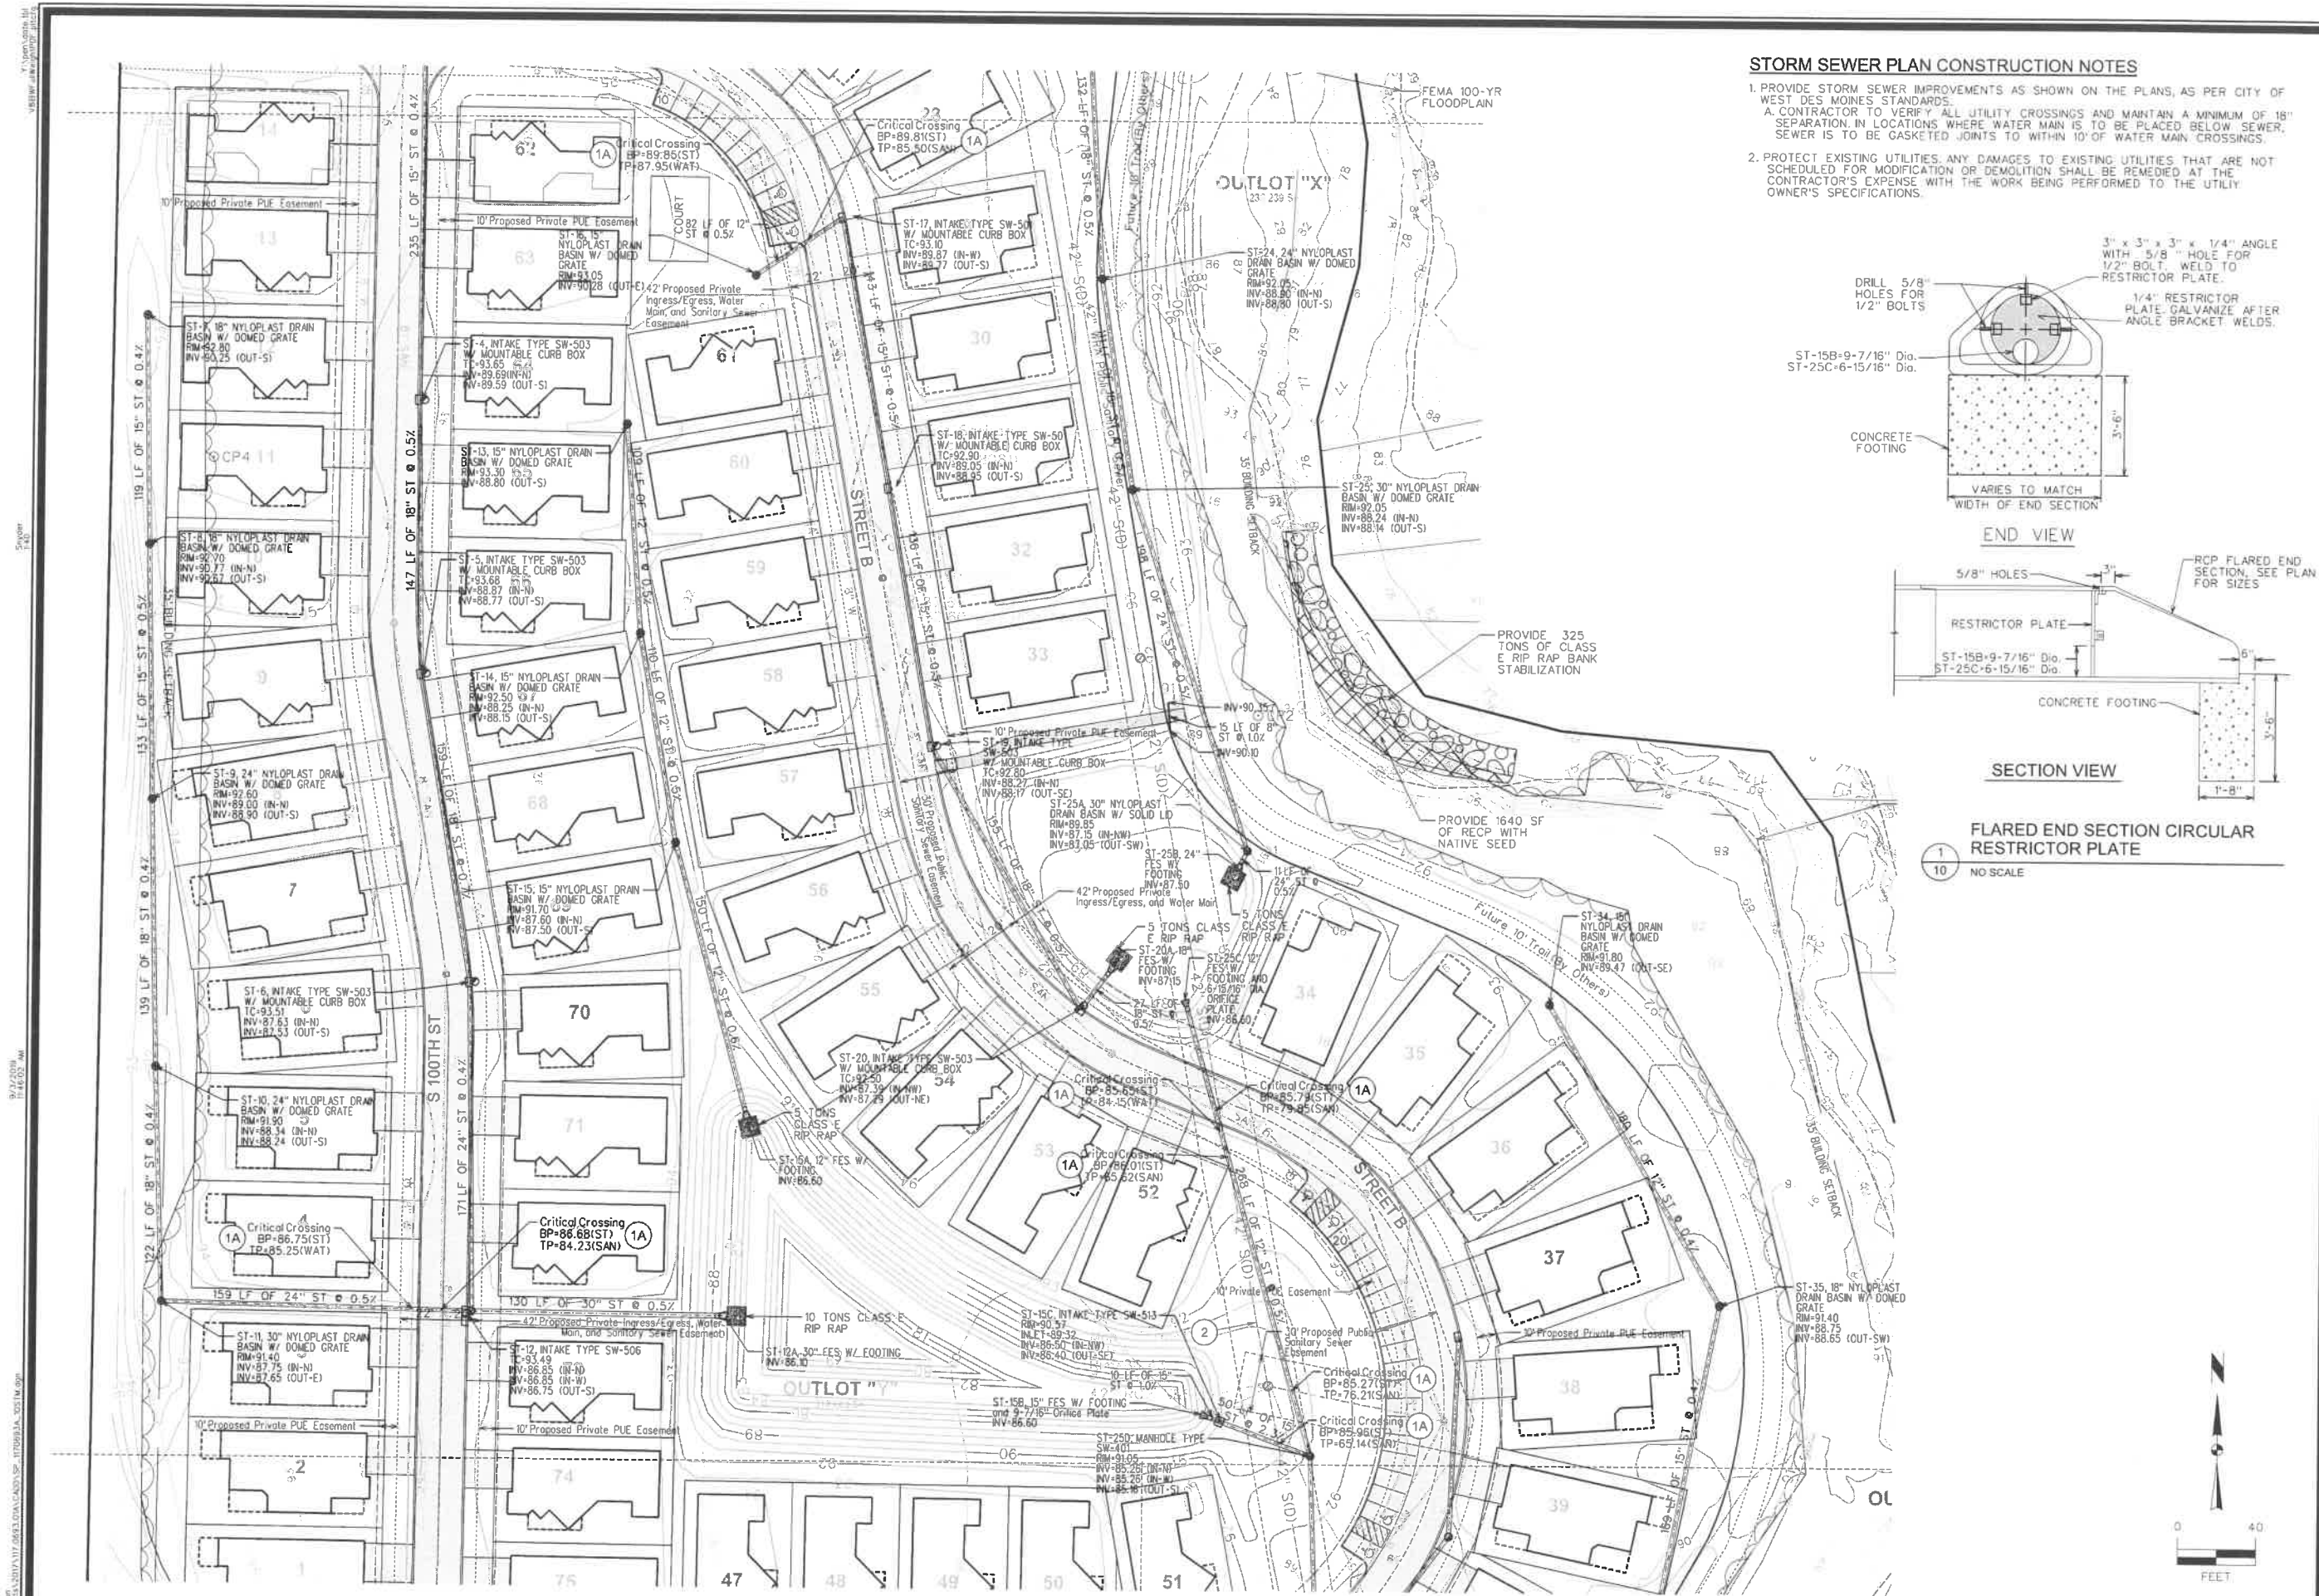


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3	AS PER CITY COMMENTS	7/19/19	RMM
2	AS PER CITY COMMENTS	7/10/19	RMM
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Technician: RMM		Date: 04/29/19	Field Bk:
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**COURTYARDS AT KINGS LANDING**  
**STORM SEWER PLAN**  
**SNYDER & ASSOCIATES, INC.**  
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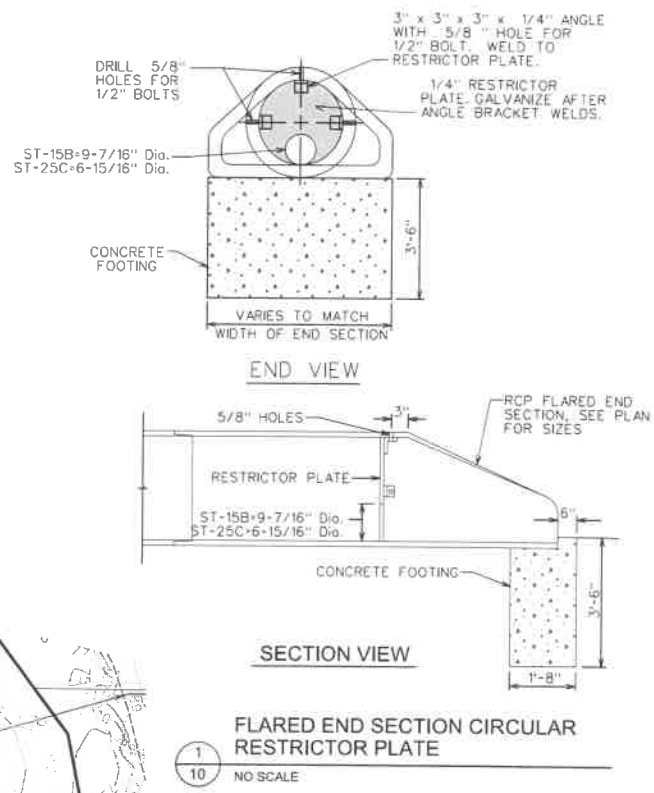
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**COURTYARDS AT KINGS LANDING**  
**STORM SEWER PLAN**


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**COURTYARDS AT KINGS LANDING**  
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**GRADING NOTES**

- CONTRACTOR TO STRIP AND STOCKPILE TOPSOIL ON ALL AREAS TO BE CUT OR FILLED. RESPREAD TO MINIMUM 4" DEPTH TO FINISH GRADES.
- ALL DRAINAGE SWALES AND SLOPES 5 TO 1 OR GREATER TO BE SEEDED USING COMMERCIALY AVAILABLE EROSION CONTROL SEED. MIXTURE APPLIED AT RATE RECOMMENDED BY SUPPLIER.
- EROSION CONTROL: SEED THE SITE AFTER ROUGH GRADING HAS BEEN COMPLETED. PLACE SILT FENCE AND MAINTAIN IN PROBLEM AREAS AFTER GROUND COVER HAS BEEN ESTABLISHED. COMPLY WITH EROSION CONTROL LAW.
- THE GENERAL CONTRACTOR IS RESPONSIBLE FOR CLEANING DIRT AND DEBRIS FROM STREETS, DRIVEWAYS AND SIDEWALKS CAUSED BY CONSTRUCTION ACTIVITIES.
- SCHEDULE OF EROSION CONTROL
  - PERIMETER SILT FENCE PRIOR TO CONSTRUCTION.
  - INTAKE SILT FENCE/SEDIMENT BASKET UPON INSTALLATION OF UTILITIES.
  - FINAL STABILIZATION UPON COMPLETION OF CONSTRUCTION ACTIVITIES.

**QUANTITIES**

SILT FENCE 2,173 LF

**POLLUTION PREVENTION NOTES**

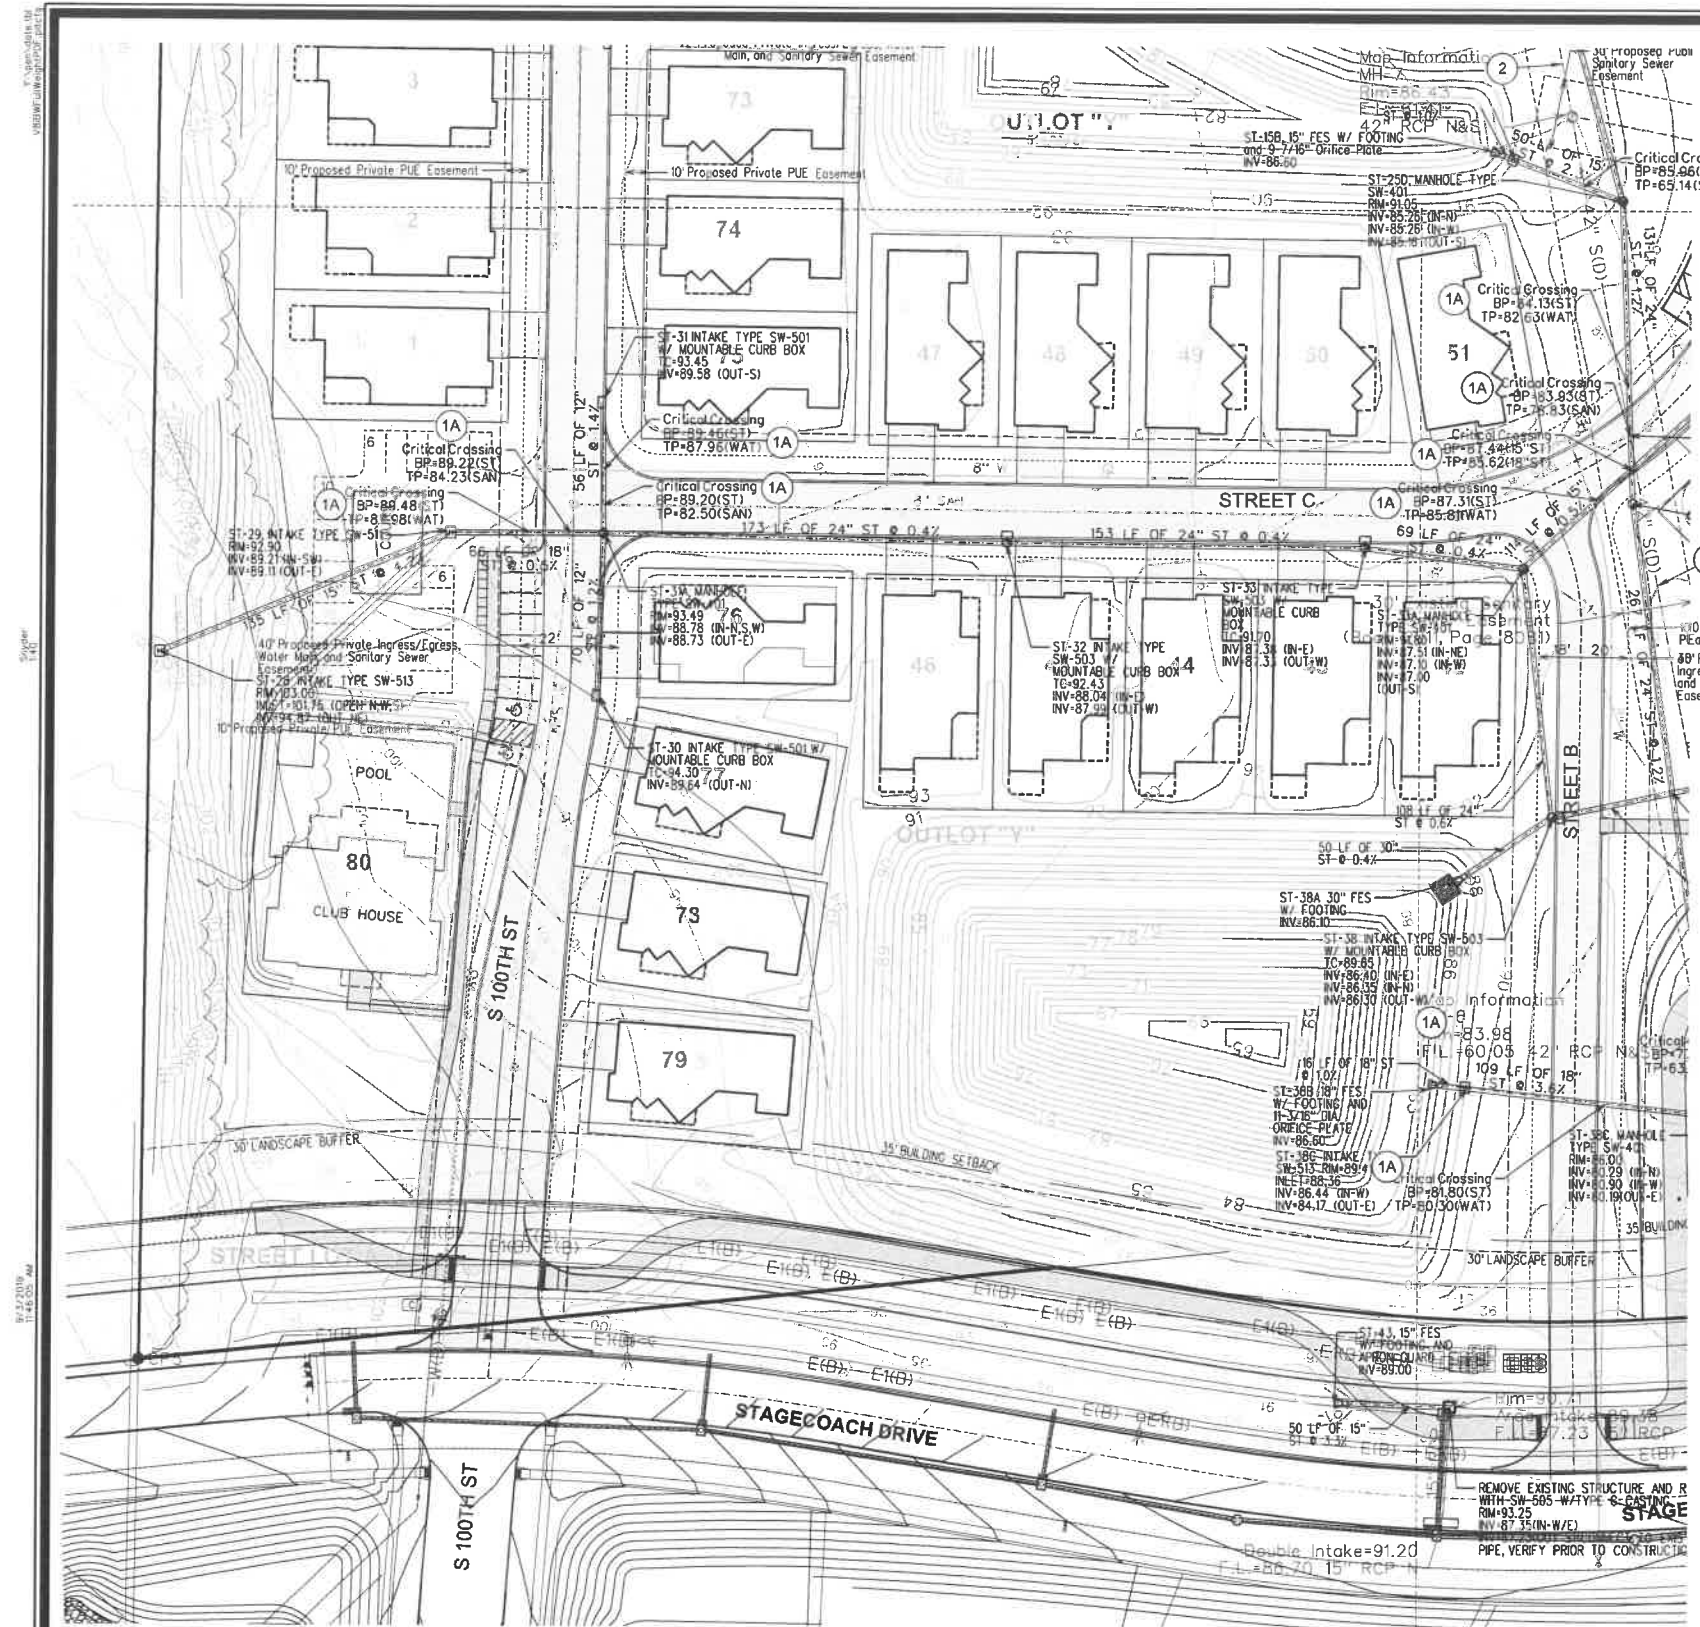**A. POLLUTION PREVENTION AND EROSION PROTECTION**

- CODE COMPLIANCE: THE CONTRACTOR IS RESPONSIBLE FOR COMPLIANCE WITH ALL POTENTIAL POLLUTION AND SOIL EROSION CONTROL REQUIREMENTS OF THE IOWA CODE, THE IOWA DEPARTMENT OF NATURAL RESOURCES (IDNR) NPDES PERMIT, THE U.S. CLEAN WATER ACT AND ANY LOCAL ORDINANCES. THE CONTRACTOR SHALL TAKE ALL NECESSARY STEPS TO PROTECT AGAINST EROSION AND POLLUTION FROM THIS PROJECT SITE AND ALL OFF-SITE BORROW OR DEPOSIT AREAS DURING PERFORMANCE OR AS A RESULT OF PERFORMANCE.
- DAMAGE CLAIMS: THE CONTRACTOR WILL HOLD THE OWNER AND ARCHITECT / ENGINEER HARMLESS FROM ANY AND ALL CLAIMS OF ANY TYPE WHATSOEVER RESULTING FROM DAMAGES TO ADJOINING PUBLIC OR PRIVATE PROPERTY, INCLUDING REASONABLE ATTORNEY FEES INCURRED TO OWNER FURTHER IF THE CONTRACTOR FAILS TO TAKE NECESSARY STEPS TO COMPLETELY REMOVE EARTH SEDIMENTATION OR DEBRIS WHICH COMES ONTO ADJOINING PUBLIC OR PRIVATE PROPERTY THE OWNER MAY, BUT NEED NOT REMOVE SUCH ITEMS AND DEDUCT THE COST THEREOF FROM AMOUNTS DUE TO THE CONTRACTOR.

**B. STORM WATER DISCHARGE PERMIT**


- THIS PROJECT REQUIRES COVERAGE UNDER THE NPDES GENERAL PERMIT NO. 2 FOR STORM WATER DISCHARGES ASSOCIATED WITH CONSTRUCTION ACTIVITIES FROM THE IDNR, AS REQUIRED BY THE ENVIRONMENTAL PROTECTION AGENCY (EPA), THE GENERAL CONTRACTOR AND ALL SUBCONTRACTORS ARE RESPONSIBLE FOR COMPLIANCE WITH AND FULFILLMENT OF ALL REQUIREMENTS OF THE NPDES GENERAL PERMIT NO. 2 AS SPECIFIED IN THE CONTRACT DOCUMENTS.
- ALL DOCUMENTS RELATED TO THE STORM WATER DISCHARGE PERMIT INCLUDING BUT NOT LIMITED TO THE NOTICE OF INTENT, PROOF OF PUBLICATIONS, DISCHARGE AUTHORIZATION LETTER, CURRENT SWPPP, SILT LOG, AND SILT LOG ITEMS, SHALL BE KEPT ON SITE AT ALL TIMES AND MUST BE PRESENTED TO ANY JURISDICTIONAL AGENCIES UPON REQUEST. FAILURE TO COMPLY WITH THE NPDES PERMIT REQUIREMENTS IS A VIOLATION OF THE CLEAN WATER ACT AND THE CODE OF IOWA.
- A "NOTICE OF DISCONTINUATION" MUST BE FILED WITH THE IDNR UPON FINAL STABILIZATION OF THE DISTURBED SITE AND REMOVAL OF ALL TEMPORARY EROSION CONTROL MEASURES. ALL PLANS, INSPECTION REPORTS, AND OTHER DOCUMENTS MUST BE RETAINED FOR A PERIOD OF THREE YEARS AFTER PROJECT COMPLETION. THE CONTRACTOR SHALL RETAIN A RECORD COPY AND PROVIDE THE ORIGINAL DOCUMENTS TO THE OWNER UPON PROJECT ACCEPTANCE AND/OR SUBMITTAL OF THE NOTICE OF DISCONTINUATION.

**C. POLLUTION PREVENTION PLAN**

- THE STORM WATER POLLUTION PREVENTION PLAN (SWPPP) IS A SEPARATE DOCUMENT IN ADDITION TO THESE PLANS. THE CONTRACTOR SHOULD REFER TO THE SWPPP FOR ADDITIONAL REQUIREMENTS AND MODIFICATIONS TO THE POLLUTION PREVENTION PLAN MADE DURING CONSTRUCTION.
- THE SWPPP ILLUSTRATES GENERAL MEASURES AND BEST MANAGEMENT PRACTICES (BMP) FOR COMPLIANCE WITH THE PROJECT'S NPDES PERMIT COVERAGE. ALL BMP'S AND EROSION CONTROL MEASURES REQUIRED AS A RESULT OF CONSTRUCTION ACTIVITIES ARE THE RESPONSIBILITY OF THE CONTRACTOR TO IDENTIFY, NOTE AND IMPLEMENT. ADDITIONAL BMP'S FROM THOSE SHOWN ON THE PLAN MAY BE REQUIRED.
- THE SWPPP AND SITE MAP SHOULD BE EXPEDITIOUSLY REVISED TO REFLECT CONSTRUCTION PROGRESS AND CHANGES AT THE PROJECT SITE.
  - UTILIZE OUTLET STRUCTURES THAT WITHDRAW WATER FROM THE SURFACE WHEN DISCHARGING FROM BASINS PROVIDE AND MAINTAIN NATURAL BUFFERS AROUND SURFACE WATERS, DIRECT WATER TO VEGETATED AREAS TO INCREASE SEDIMENT REMOVAL AND MAXIMIZE STORM WATER INFILTRATION, AND MINIMIZE SOIL COMPACTION.
  - INSTALL PERIMETER AND FINAL SEDIMENT CONTROL MEASURES SUCH AS SILT BARRIERS, DITCH CHECKS, DIVERSION BERMS, OR SEDIMENTATION BASINS DOWNSTREAM OF SOIL DISTURBING ACTIVITIES PRIOR TO SITE CLEARING AND GRADING OPERATIONS.
  - PRESERVE EXISTING VEGETATION IN AREAS NOT NEEDED FOR CONSTRUCTION AND LIMIT TO A MINIMUM THE TOTAL AREA DISTURBED BY CONSTRUCTION OPERATIONS AT ANY TIME.
  - MAINTAIN ALL TEMPORARY AND PERMANENT EROSION CONTROL MEASURES IN WORKING ORDER, INCLUDING CLEANING, REPAIRING, REPLACEMENT AND SEDIMENT REMOVAL THROUGHOUT THE PERMIT PERIOD. CLEAN OR REPLACE SILT CONTROL DEVICES WHEN THE MEASURES HAVE LOST 50% OF THEIR ORIGINAL CAPACITY.
  - INSPECT THE PROJECT AREA AND CONTROL DEVICES (BY QUALIFIED PERSONNEL ASSIGNED BY THE CONTRACTOR) EVERY SEVEN CALENDAR DAYS. RECORD THE FINDINGS OF THESE INSPECTIONS AND ANY RESULTING ACTIONS IN THE SWPPP WITH A COPY SUBMITTED WEEKLY TO THE ENGINEER DURING CONSTRUCTION. REVISE THE SWPPP AND IMPLEMENT ANY RECOMMENDED MEASURES WITHIN 3 DAYS.
  - PREVENT ACCUMULATION OF EARTH AND DEBRIS FROM CONSTRUCTION ACTIVITIES ON ADJOINING PUBLIC OR PRIVATE PROPERTIES INCLUDING STREETS, DRIVEWAYS, SIDEWALKS, DRAINAGEWAYS, OR UNDERGROUND SEWERS. REMOVE ANY ACCUMULATION OF EARTH OR DEBRIS IMMEDIATELY AND TAKE REMEDIAL ACTIONS FOR FUTURE PREVENTION.
  - INSTALL NECESSARY CONTROL MEASURES SUCH AS SILT BARRIERS, EROSION CONTROL MATS, MULCH, DITCH CHECKS OR RIPRAP AS SOON AS AREAS REACH THEIR FINAL GRADES AND AS CONSTRUCTION OPERATIONS PROGRESS TO ENSURE CONTINUOUS RUNOFF CONTROL. PROVIDE INLET AND OUTLET CONTROL MEASURES AS SOON AS STORM SEWERS ARE INSTALLED.
  - RESPREAD A MINIMUM OF 4 INCHES OF TOPSOIL (INCLUDING TOPSOIL FOUND IN SOIL) ON ALL DISTURBED AREAS, EXCEPT WHERE PAVEMENT, BUILDINGS OR OTHER IMPROVEMENTS ARE LOCATED.
  - STABILIZE UNDEVELOPED, DISTURBED AREAS WITH MULCH, TEMPORARY SEED MIX, PERMANENT SEED MIX, SOIL OR PAVEMENT IMMEDIATELY AS FEASIBLE UPON COMPLETION OR DELAY OF GRADING OPERATIONS. INITIATE STABILIZATION MEASURES IMMEDIATELY AFTER CONSTRUCTION ACTIVITY IS FINALLY COMPLETED OR TEMPORARILY CEASED ON ANY PORTION OF THE SITE AND WHICH WILL NOT RESUME FOR A PERIOD EXCEEDING 14 CALENDAR DAYS.
  - COORDINATE LOCATIONS OF STAGING AREAS WITH THE OWNER AND RECORD IN THE SWPPP UNLESS NOTED OTHERWISE. STAGING AREAS SHOULD CONTAIN THE FOLLOWING: JOB TRAILERS, FUELING VEHICLE, MAINTENANCE AREA, TEMPORARY SANITARY FACILITIES, MATERIALS STORAGE, AND CONCRETE WASHOUT FACILITY. CONTROL RUNOFF FROM STAGING AREAS WITH DIVERSION BERMS AND/OR SILT BARRIERS AND DIRECT TO A SEDIMENT BASIN OR OTHER CONTROL DEVICE WHERE POSSIBLE. CONCRETE WASHOUT MUST BE CONTAINED ONSITE.
  - REMOVE ALL TEMPORARY EROSION CONTROL MEASURES AND SITE WASTE PRIOR TO FILING OF THE "NOTICE OF DISCONTINUATION".

**D. PROJECT SPECIFIC REQUIREMENTS FOR POLLUTION PREVENTION AND EROSION PROTECTION**

- RESPONSIBILITIES OF THE OWNER:
  - SIGN NPDES CERTIFICATION STATEMENT AS PERMITEE.
  - ALL REQUIREMENTS NOT ASSIGNED TO OTHERS.
- RESPONSIBILITIES OF THE ENGINEER:
  - CREATE THE INITIAL SWPPP.
  - PUBLISH THE PUBLIC NOTICE OF STORM WATER DISCHARGE.
  - FILE THE NOTICE OF INTENT WITH APPLICATION FEE FOR NPDES GENERAL PERMIT NO. 2 COVERAGE.
  - SUBMIT THE NOTICE OF DISCONTINUATION.
- RESPONSIBILITIES OF THE CONTRACTOR:
  - SIGN NPDES CERTIFICATION STATEMENT AS CO-PERMITEE AND COORDINATING CERTIFICATION OF SUBCONTRACTOR CO-PERMITEES.
  - COMPLY WITH THE REQUIREMENTS OF THE GENERAL PERMIT NO. 2 AND THE SWPPP.
  - INSTALL, MAINTAIN, AND REMOVE EROSION CONTROL AND POLLUTION PREVENTION MEASURES.
  - WEEKLY INSPECTIONS AND CORRESPONDING RECORDS.
  - UPDATE AND MAINTAIN THE ONSITE SWPPP.
  - COOPERATE TO PROVIDE INFORMATION UNDER THE RESPONSIBILITY OF OTHERS.

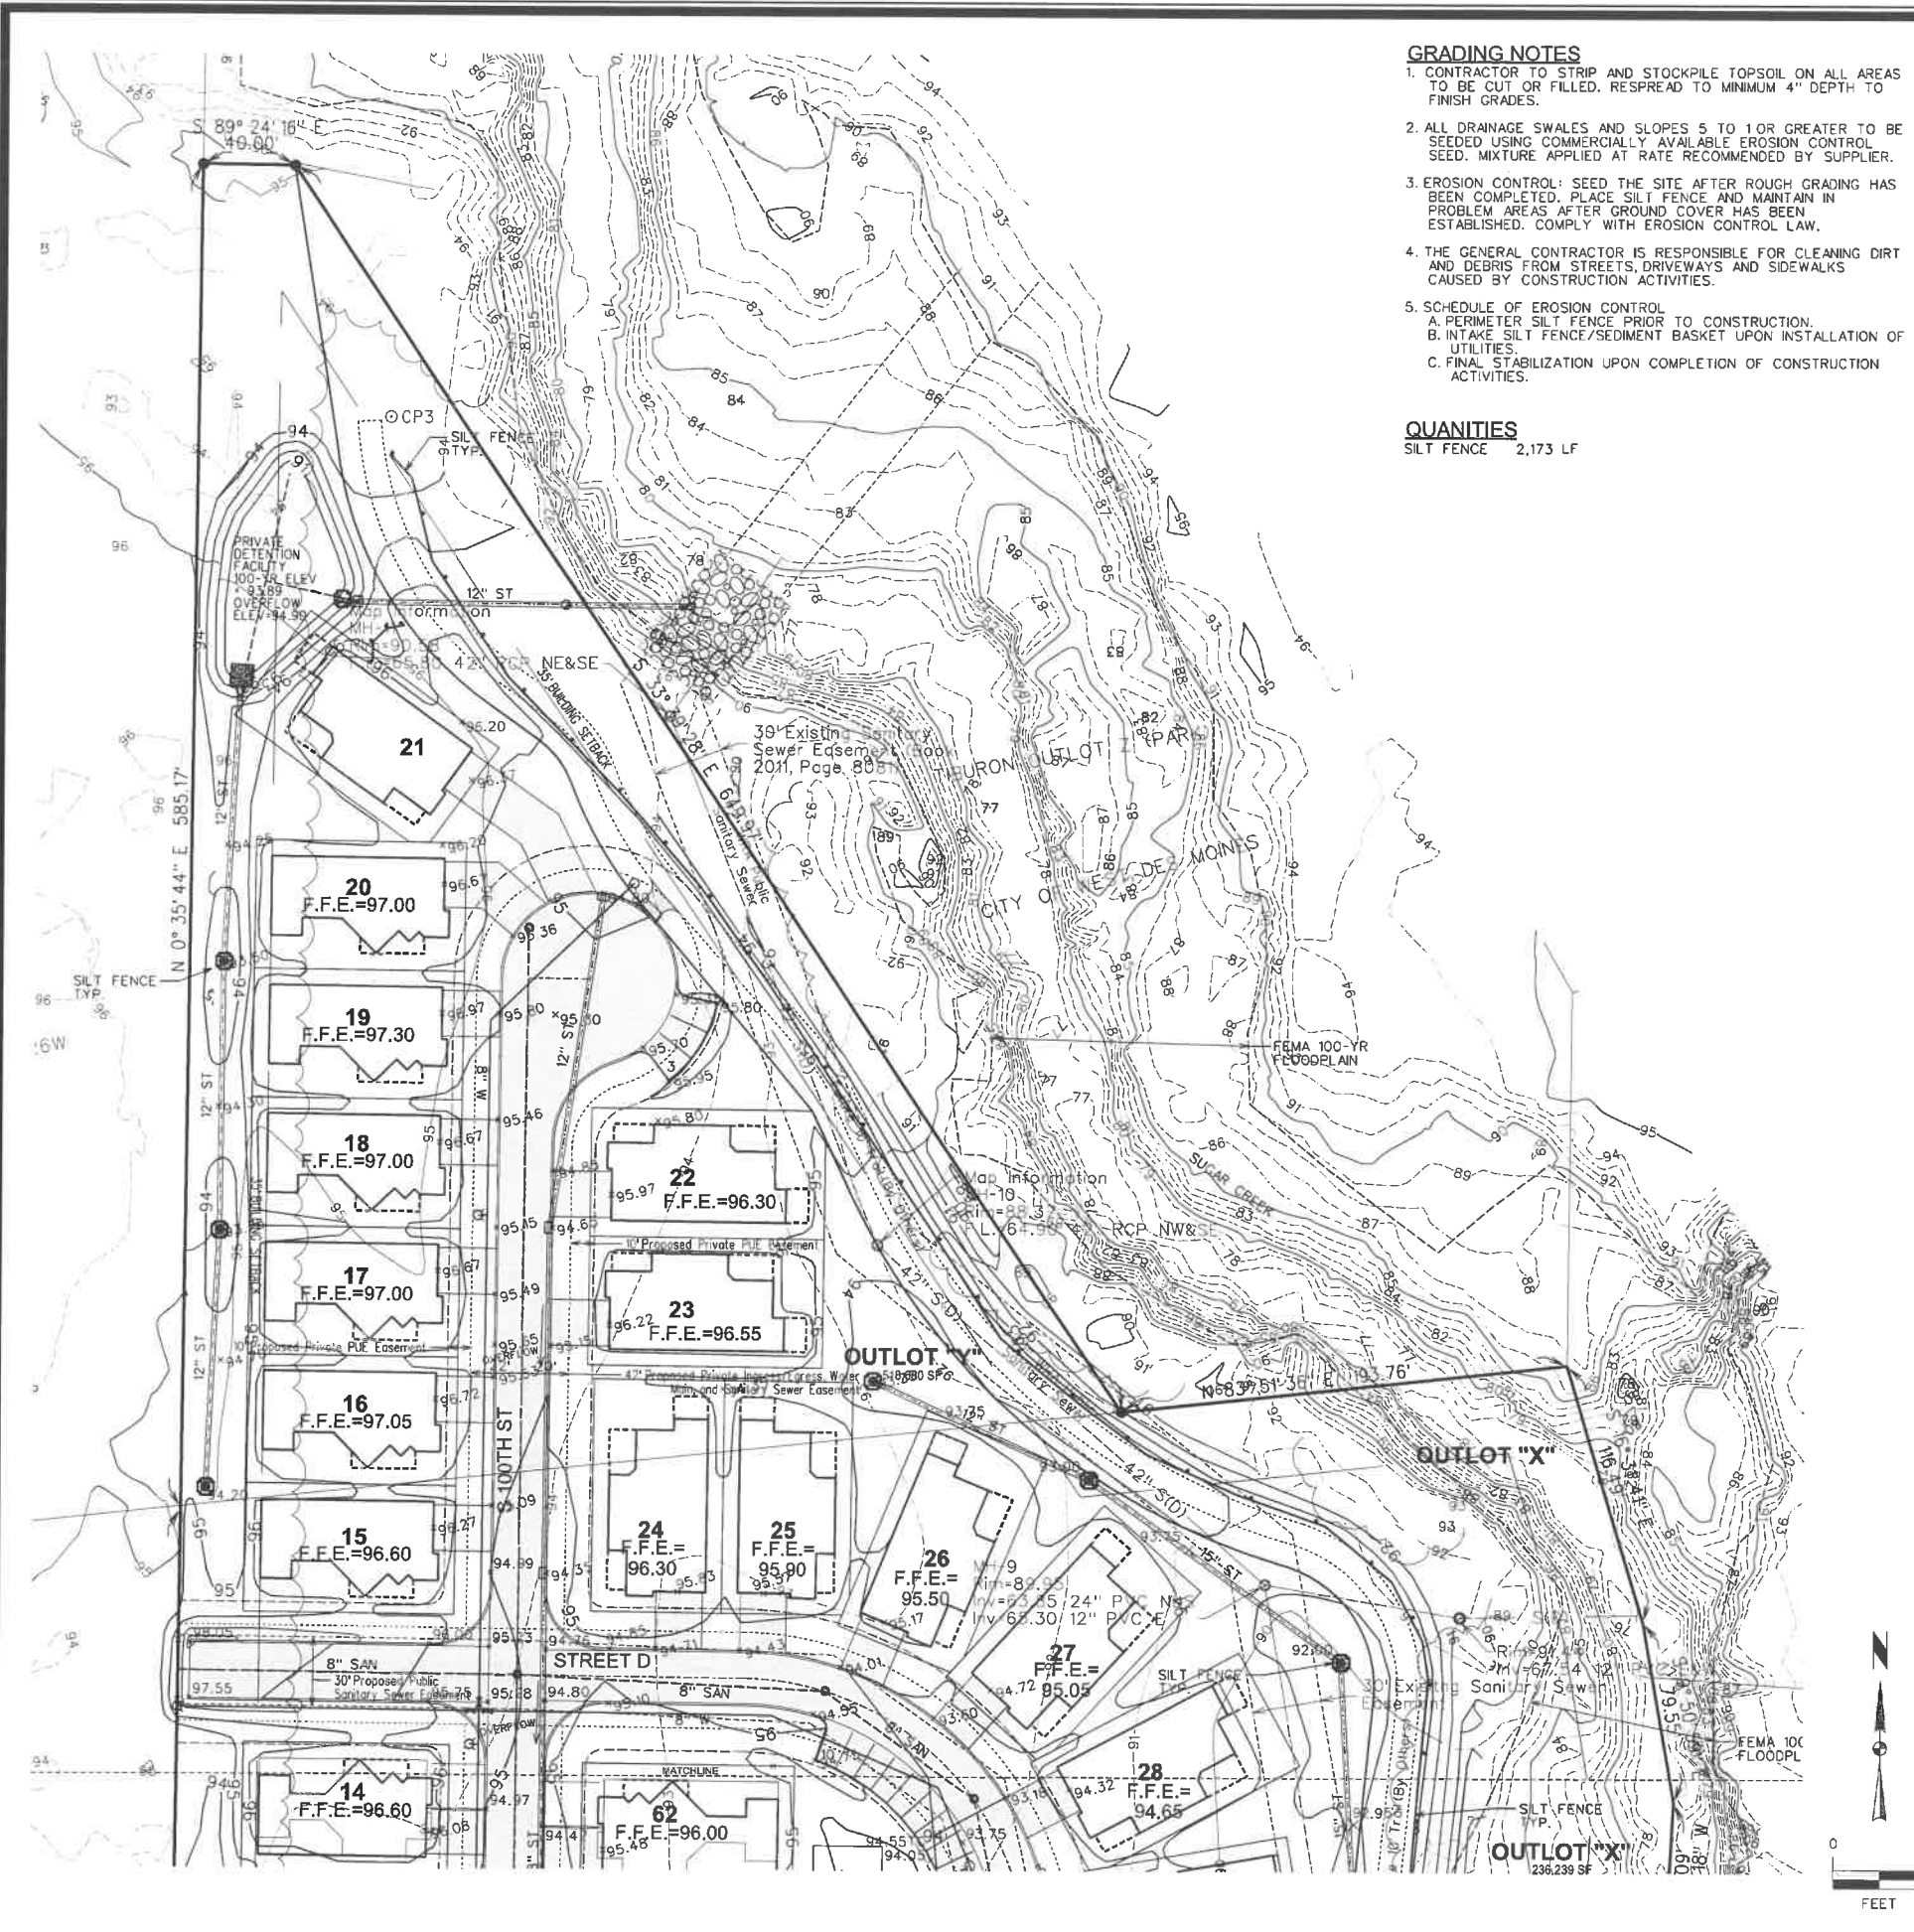

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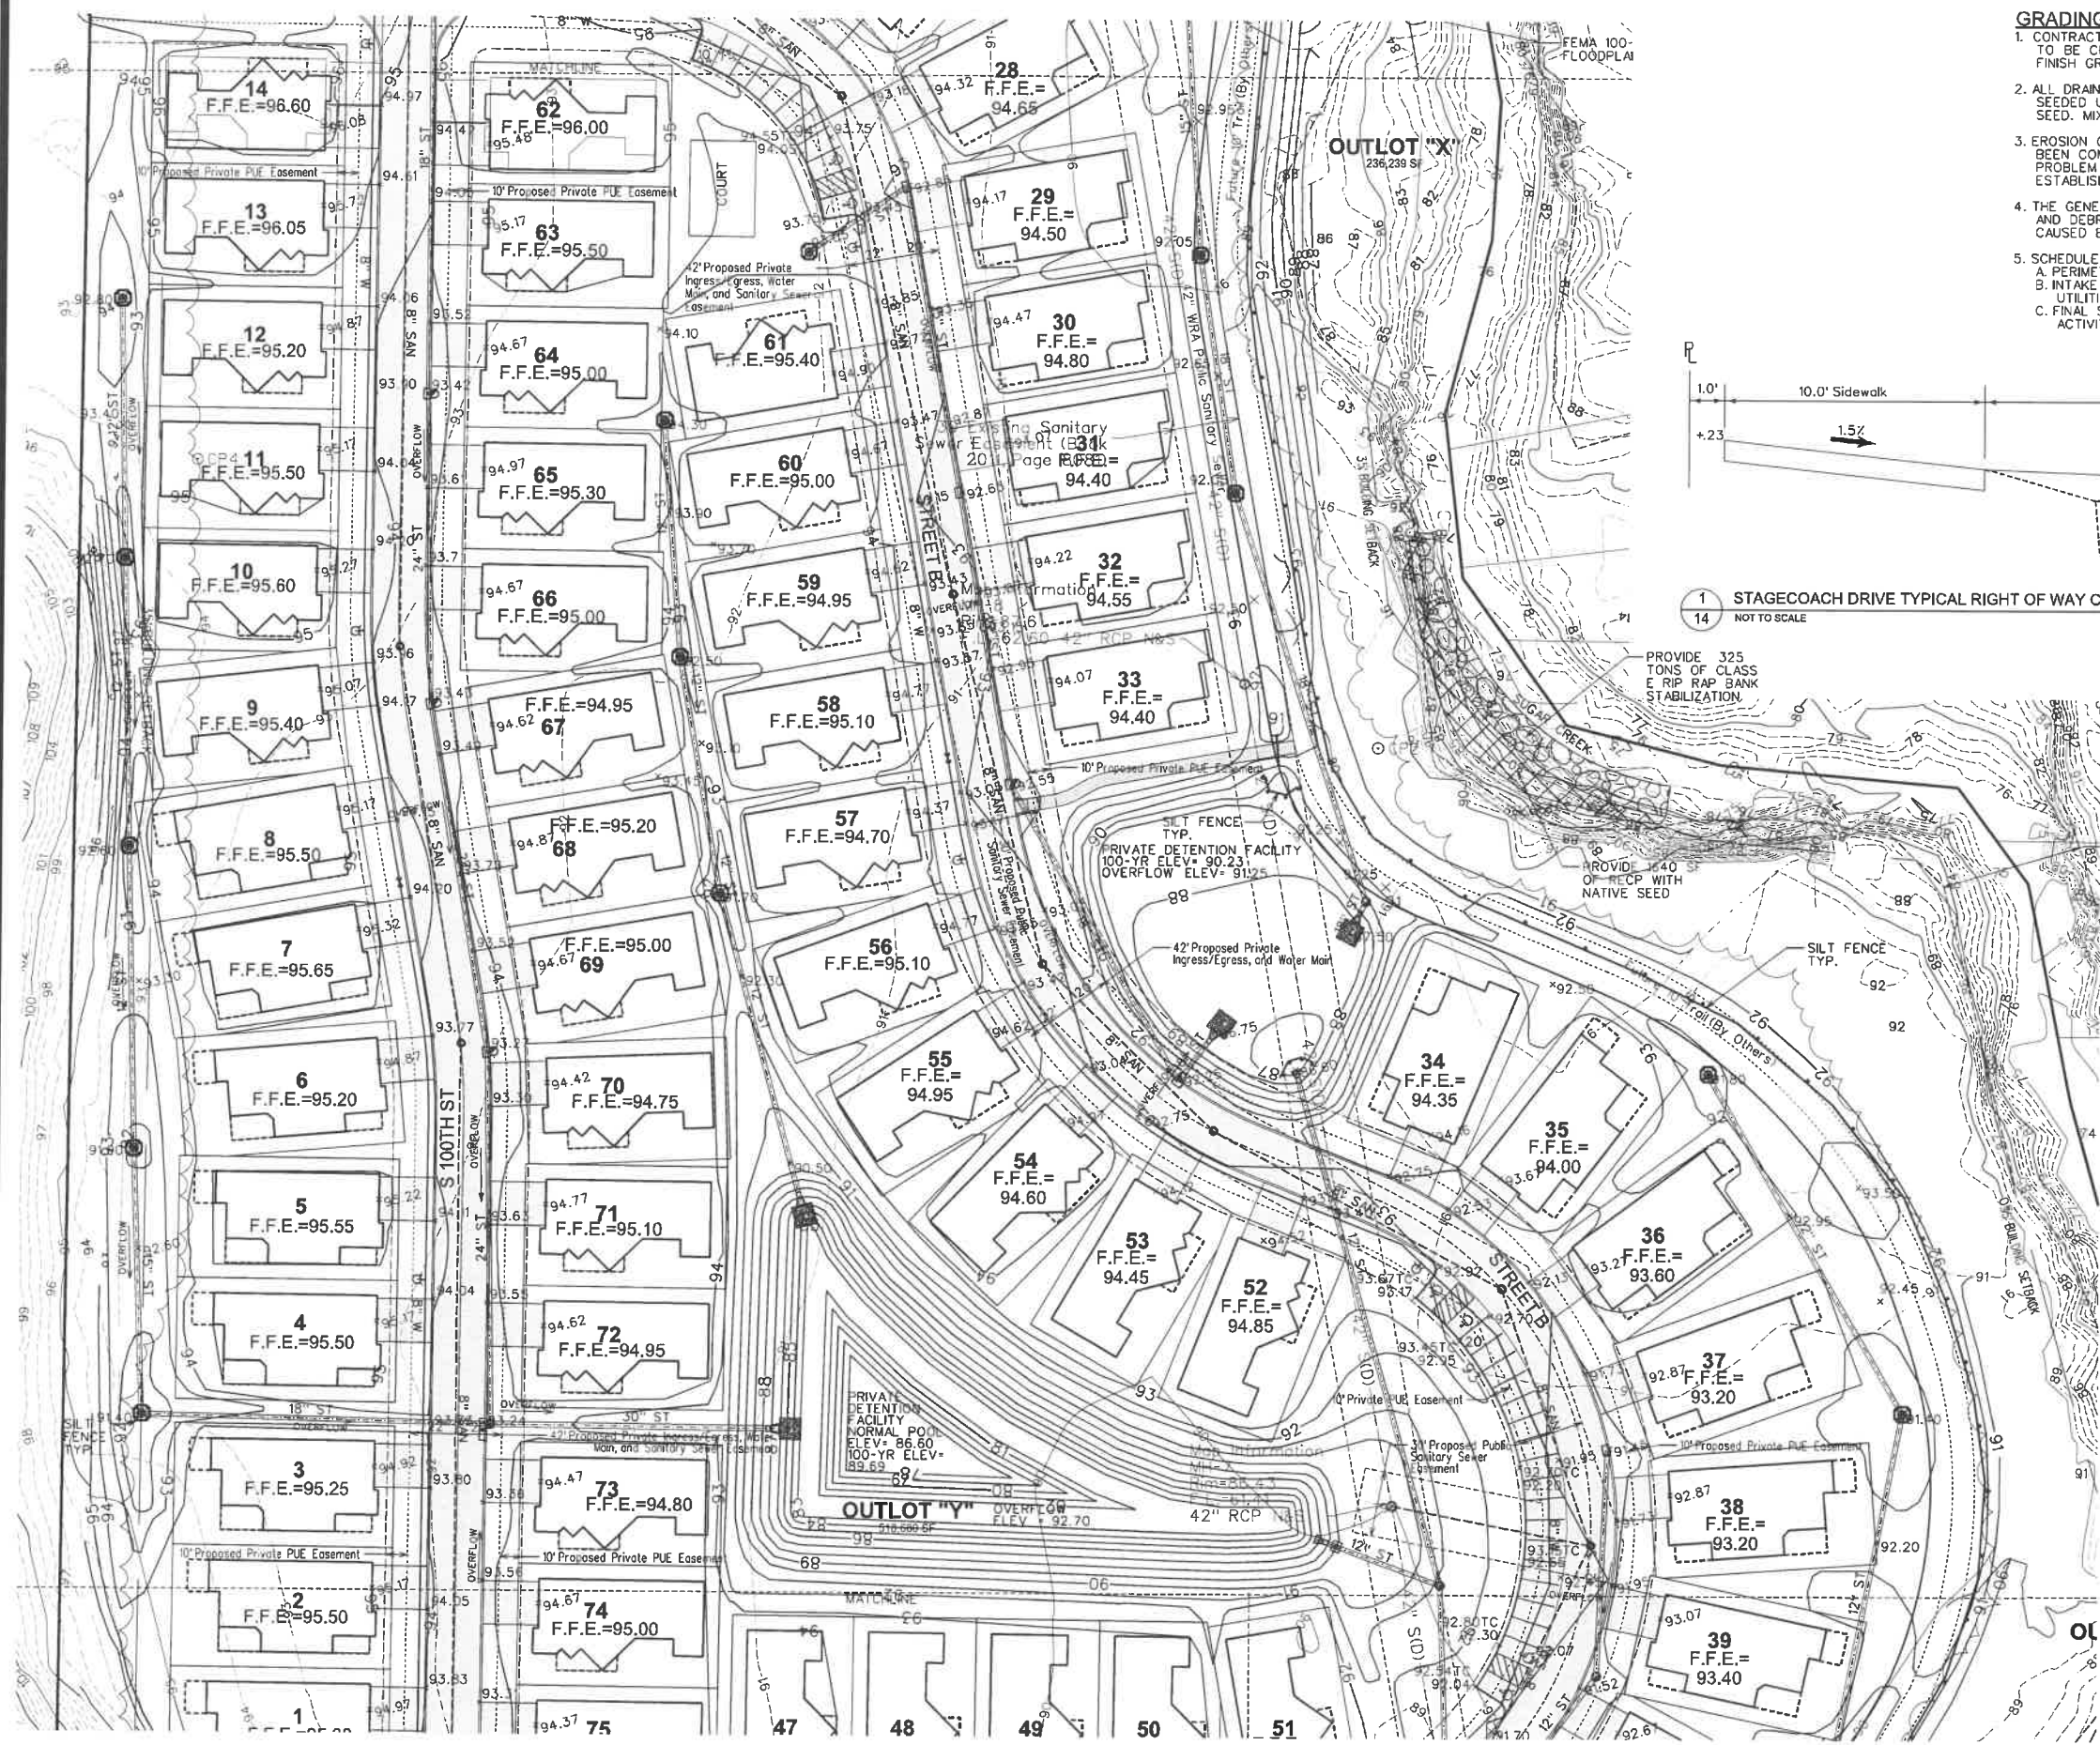
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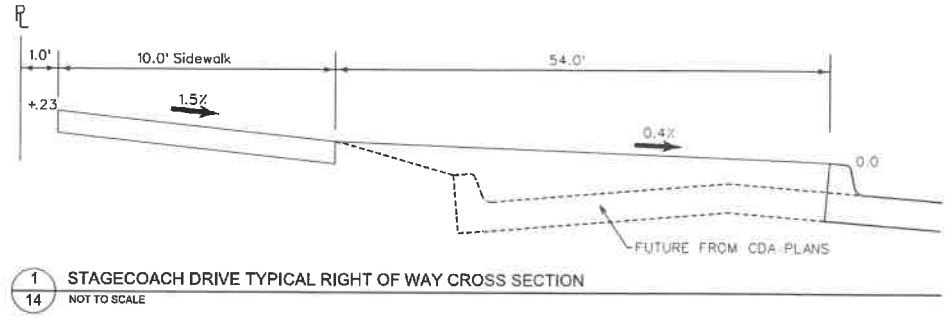




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- GRADING NOTES**
1. CONTRACTOR TO STRIP AND STOCKPILE TOPSOIL ON ALL AREAS TO BE CUT OR FILLED. RESPREAD TO MINIMUM 4" DEPTH TO FINISH GRADES.
  2. ALL DRAINAGE SWALES AND SLOPES 5 TO 1 OR GREATER TO BE SEEDED USING COMMERCIALY AVAILABLE EROSION CONTROL SEED MIXTURE APPLIED AT RATE RECOMMENDED BY SUPPLIER.
  3. EROSION CONTROL: SEED THE SITE AFTER ROUGH GRADING HAS BEEN COMPLETED. PLACE SILT FENCE AND MAINTAIN IN PROBLEM AREAS AFTER GROUND COVER HAS BEEN ESTABLISHED. COMPLY WITH EROSION CONTROL LAW.
  4. THE GENERAL CONTRACTOR IS RESPONSIBLE FOR CLEANING DIRT AND DEBRIS FROM STREETS, DRIVEWAYS AND SIDEWALKS CAUSED BY CONSTRUCTION ACTIVITIES.
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    - B. INTAKE SILT FENCE/SEDIMENT BASKET UPON INSTALLATION OF UTILITIES.
    - C. FINAL STABILIZATION UPON COMPLETION OF CONSTRUCTION ACTIVITIES.





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4	REVISED GRADINGS AND UTILITIES	8/1/19	KSS
3	AS PER CITY COMMENTS	7/19/19	KMM
2	AS PER CITY COMMENTS	7/10/19	KMM
1	DATE		BY
	REVISION		
	Checked By:	EDC	Scale: 1"=40'
	Engineer:	KMM	
	Technician:	RMM	Date: 04/29/19
			Field Bk: Pg: 117.0693A
			Project No: 117.0693A
			Sheet 14 of 20



**COURTYARDS AT KINGS LANDING**  
**GRADING AND EROSION CONTROL PLAN**  
**SNYDER & ASSOCIATES, INC.**  
 WEST DES MOINES, IA  
 2727 S.W. SNYDER BLVD.  
 ANKENY, IOWA 50023  
 515-964-2020 | www.snyder-associates.com





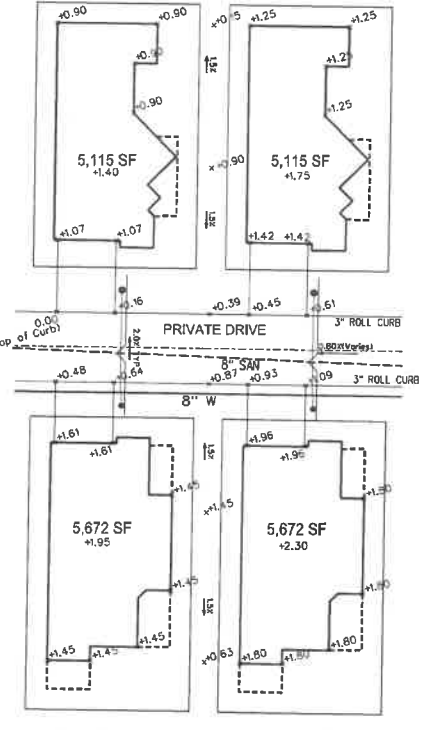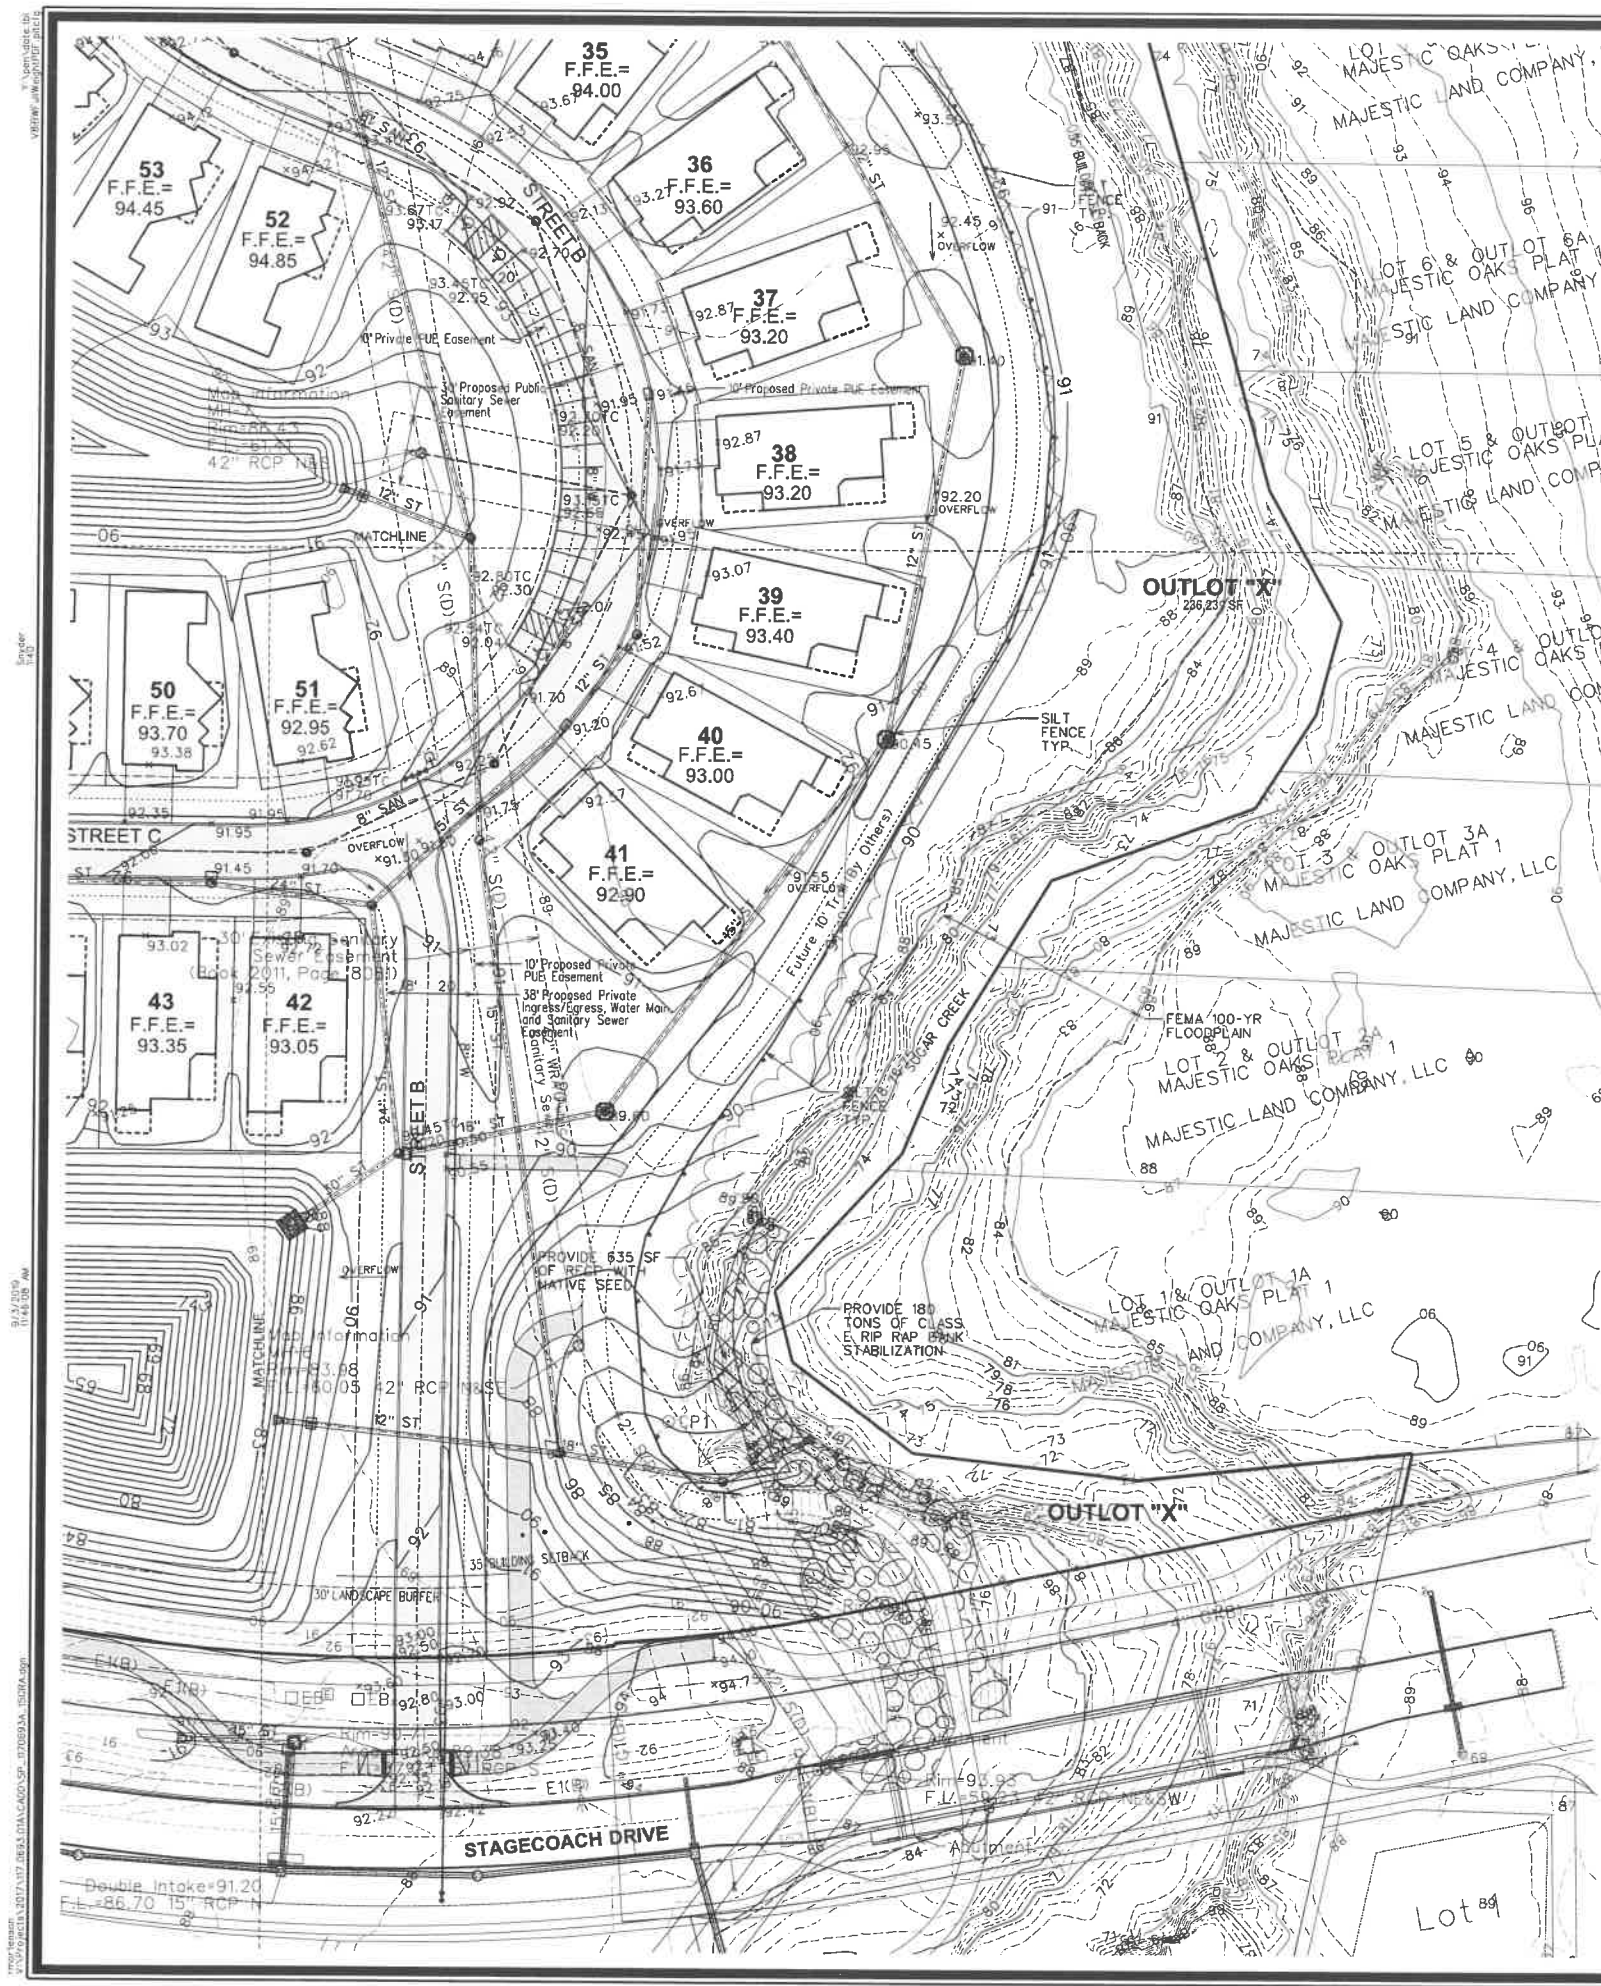

TYPICAL UNIT GRADING DETAIL  
SCALE 1"=30'

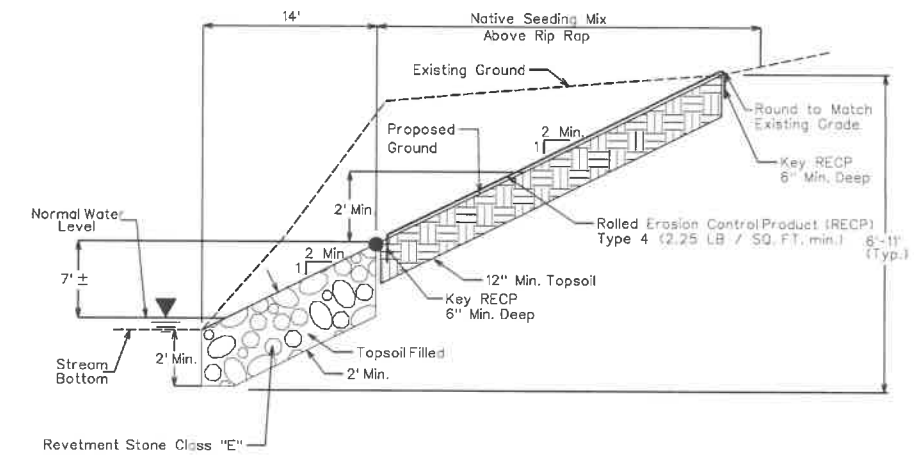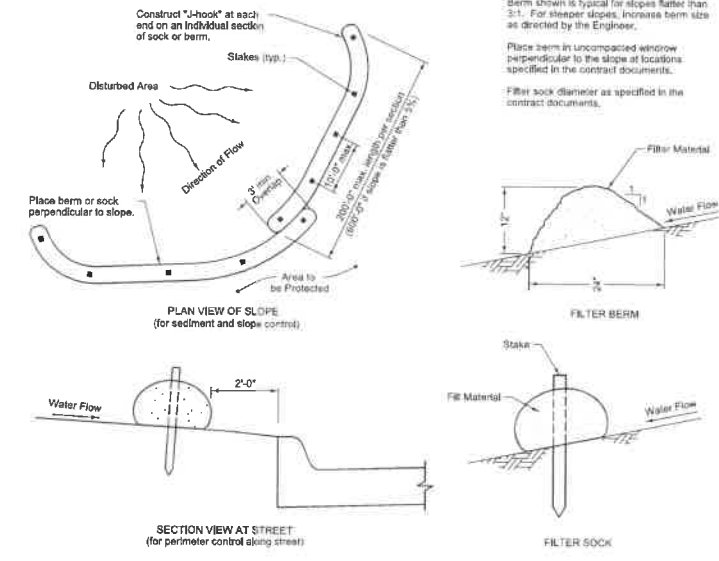

NOTES:  
ON SITE SALVAGED TOPSOIL IS TO BE USED, OVEREXCAVATE TO REMOVE POOR QUALITY SOIL AS NECESSARY.  
PRESERVE/COMPLEMENT EXISTING REVETMENT  
SEE GRADING PLAN FOR APPROXIMATE REVETMENT QUANTITY EACH LOCATION

2 TYPICAL SECTION - ROCK TOE PROTECTION & BANK SHAPING WITHOUT BENCH  
NO SCALE

- GRADING NOTES**
- CONTRACTOR TO STRIP AND STOCKPILE TOPSOIL ON ALL AREAS TO BE CUT OR FILLED, RESPREAD TO MINIMUM 4" DEPTH TO FINISH GRADES.
  - ALL DRAINAGE SWALES AND SLOPES 5 TO 1 OR GREATER TO BE SEEDED USING COMMERCIALY AVAILABLE EROSION CONTROL SEED MIXTURE APPLIED AT RATE RECOMMENDED BY SUPPLIER.
  - EROSION CONTROL: SEED THE SITE AFTER ROUGH GRADING HAS BEEN COMPLETED. PLACE SILT FENCE AND MAINTAIN IN PROBLEM AREAS AFTER GROUND COVER HAS BEEN ESTABLISHED. COMPLY WITH EROSION CONTROL LAW.
  - THE GENERAL CONTRACTOR IS RESPONSIBLE FOR CLEANING DIRT AND DEBRIS FROM STREETS, DRIVEWAYS AND SIDEWALKS CAUSED BY CONSTRUCTION ACTIVITIES.
  - SCHEDULE OF EROSION CONTROL
    - PERIMETER SILT FENCE PRIOR TO CONSTRUCTION.
    - INTAKE SILT FENCE/SEDIMENT BASKET UPON INSTALLATION OF UTILITIES.
    - FINAL STABILIZATION UPON COMPLETION OF CONSTRUCTION ACTIVITIES.


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3	AS PER CITY COMMENTS	7/19/19	MM
2	AS PER CITY COMMENTS	7/10/19	MM
1	MARK REVISION	DATE	BY
	Engineer: KMM	Checked By: EDC	Scale: 1"=40'
	Technician: RMM	Date: 04/29/19	Field Bk: Pp:
	Project No:	117.0693A	Sheet 15 of 20

**WEST DES MOINES, IA**  
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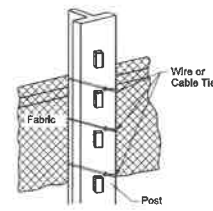
**COURTYARDS AT KINGS LANDING**  
**GRADING AND EROSION CONTROL PLAN**  
**SNYDER & ASSOCIATES, INC.**







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Sheet 15 of 20

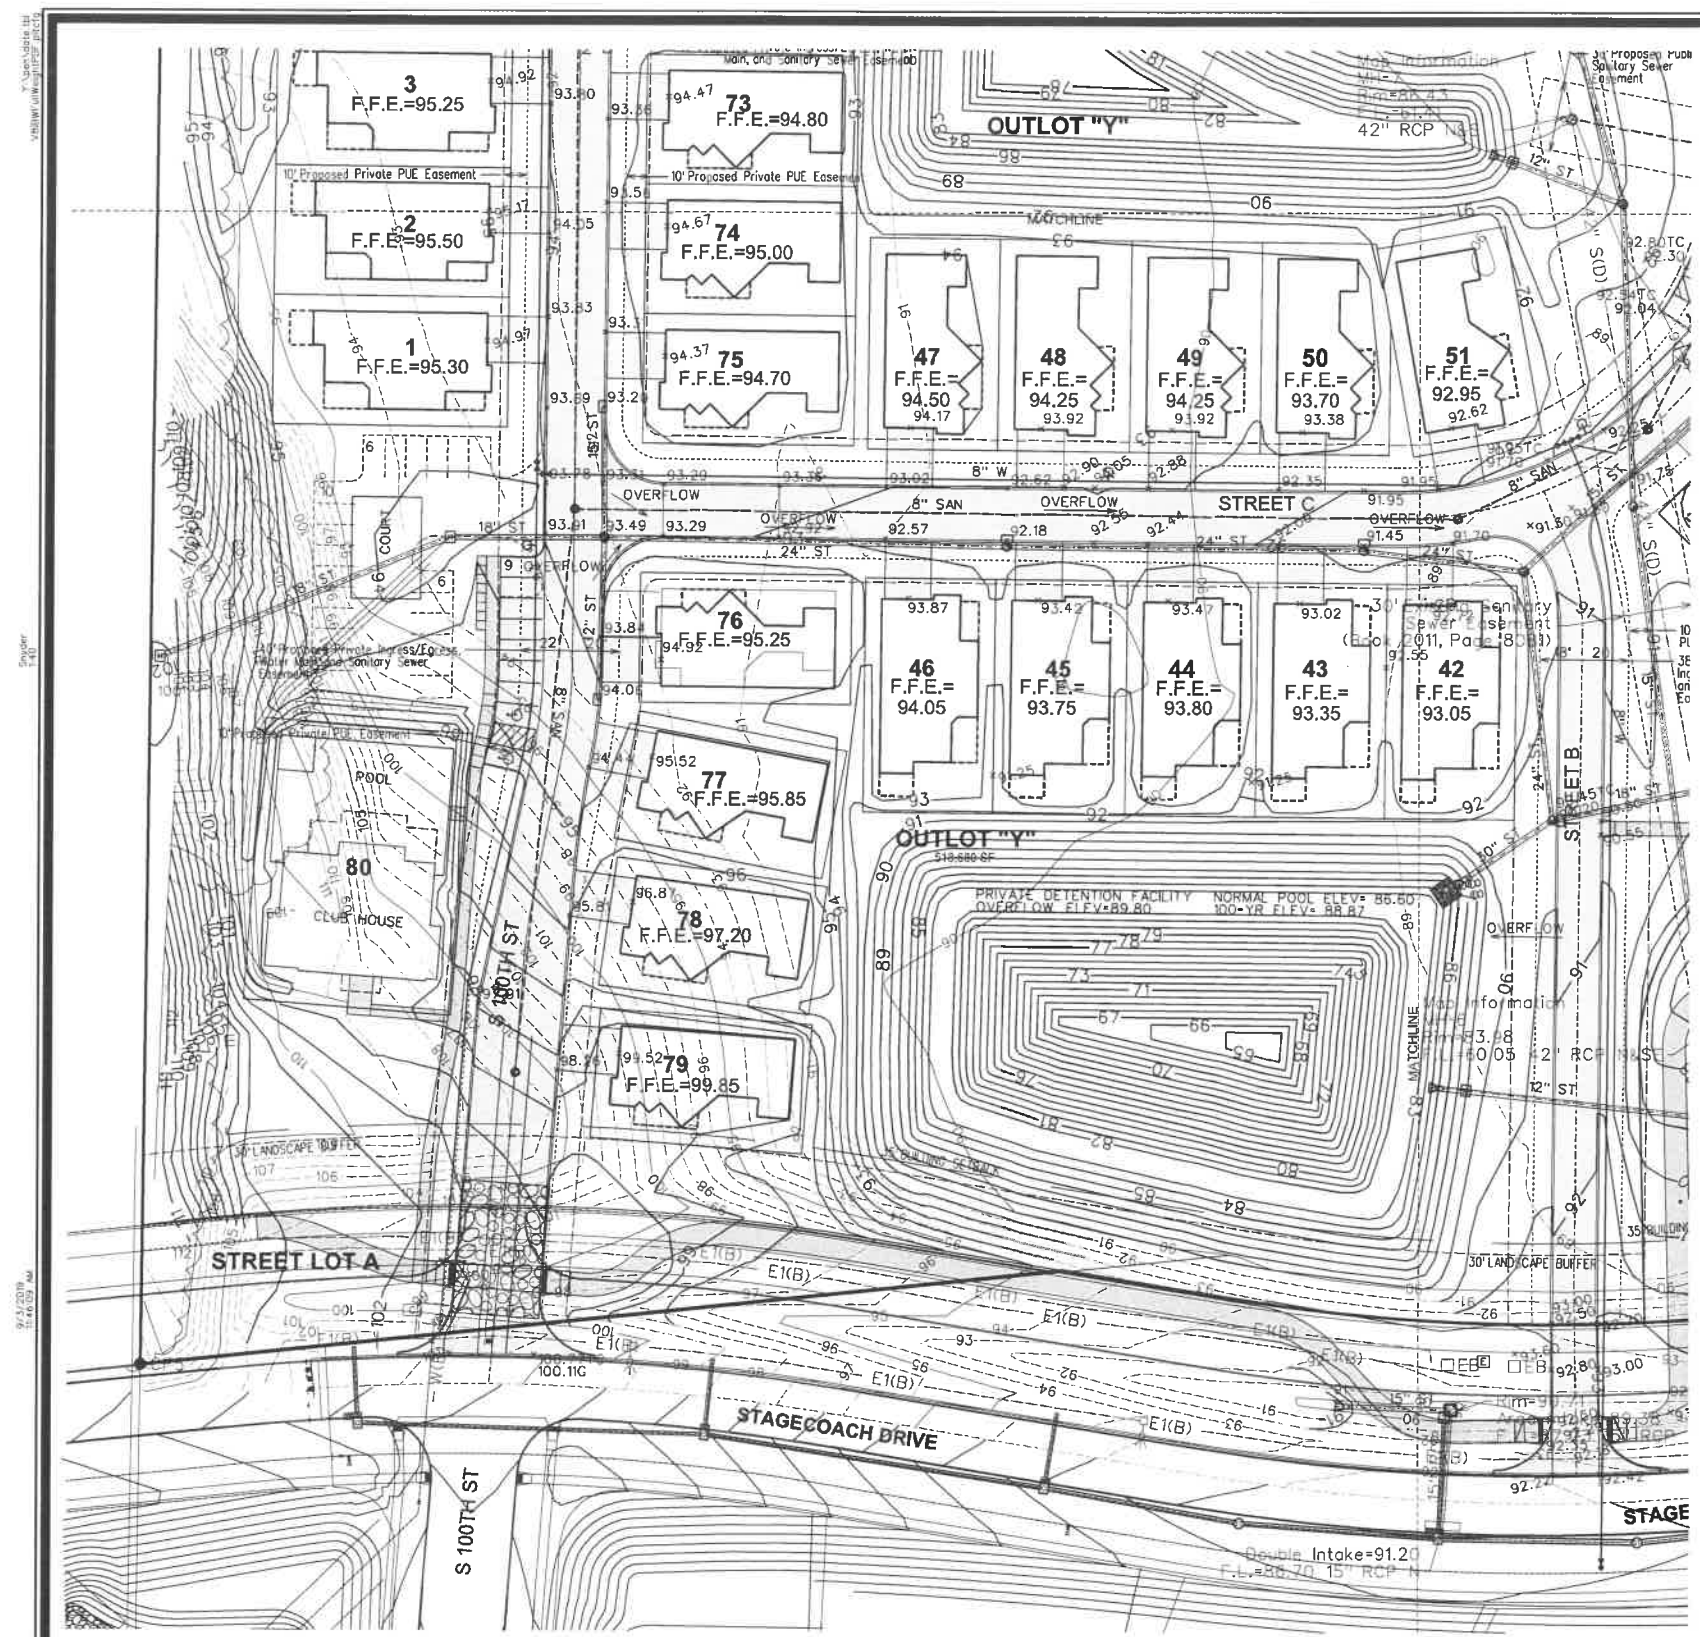


- ### GRADING NOTES
- CONTRACTOR TO STRIP AND STOCKPILE TOPSOIL ON ALL AREAS TO BE CUT OR FILLED. RESPREAD TO MINIMUM 4" DEPTH TO FINISH GRADES.
  - ALL DRAINAGE SWALES AND SLOPES 5 TO 1 OR GREATER TO BE SEEDED USING COMMERCIALY AVAILABLE EROSION CONTROL SEED MIXTURE APPLIED AT RATE RECOMMENDED BY SUPPLIER.
  - EROSION CONTROL: SEED THE SITE AFTER ROUGH GRADING HAS BEEN COMPLETED. PLACE SILT FENCE AND MAINTAIN IN PROBLEM AREAS AFTER GROUND COVER HAS BEEN ESTABLISHED. COMPLY WITH EROSION CONTROL LAW.
  - THE GENERAL CONTRACTOR IS RESPONSIBLE FOR CLEANING DIRT AND DEBRIS FROM STREETS, DRIVEWAYS AND SIDEWALKS CAUSED BY CONSTRUCTION ACTIVITIES.
  - SCHEDULE OF EROSION CONTROL
    - PERIMETER SILT FENCE PRIOR TO CONSTRUCTION.
    - INTAKE SILT FENCE/SEDIMENT BASKET UPON INSTALLATION OF UTILITIES.
    - FINAL STABILIZATION UPON COMPLETION OF CONSTRUCTION ACTIVITIES.




- Insert 12 inches of fabric a minimum of 6 inches deep (fabric may be folded below the ground line).
- Reduce post spacing to 5'-0" at water concentration areas, or as required to adequately support fence.

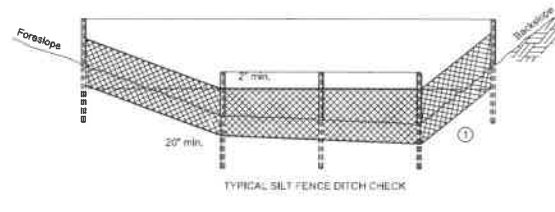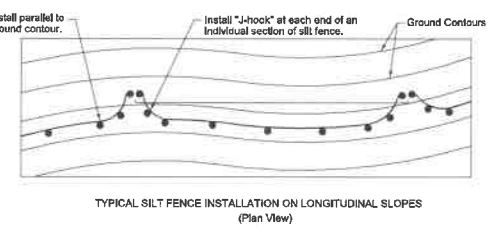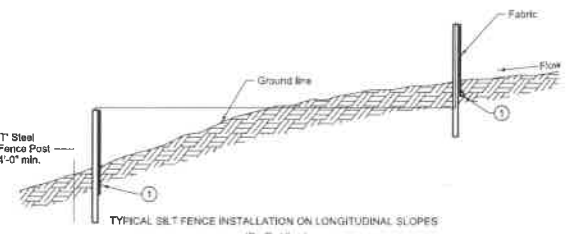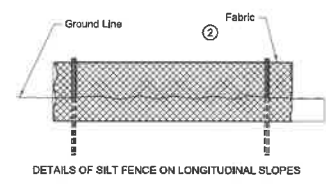

### SILT FENCE

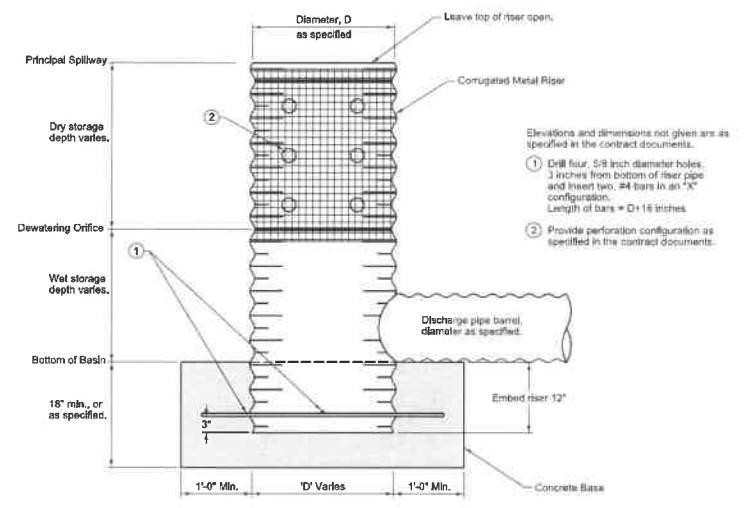

- Elevations and dimensions not given are as specified in the contract documents.
- Drill four 5/8 inch diameter holes, 3 inches from bottom of riser pipe and insert two #4 bars in an "X" configuration. Length of bars = D + 16 inches.
  - Provide perforation configuration as specified in the contract documents.

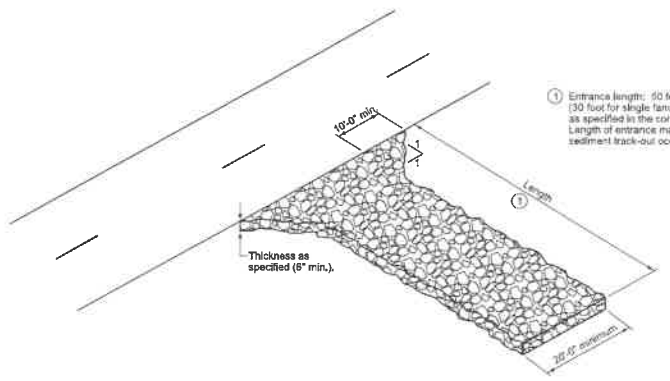

- Entrance length: 50 foot minimum (30 foot for single family residential), or as specified in the contract documents. Length of entrance may be increased if sediment track-out occurs.



9/3/19	RAMM	DATE	1"=40'
8/1/19	KSS	REVISION	FILE NO.
7/19/19	RAMM	DATE	117.0693A
7/10/19	RAMM	DATE	117.0693A
2	AS PER CITY COMMENTS	DATE	117.0693A
3	AS PER CITY COMMENTS	DATE	117.0693A
4	REVISED GRADES AND UTILITIES	DATE	117.0693A
5	AS PER CITY COMMENTS	DATE	117.0693A

**COURTYARDS AT KINGS LANDING**  
**GRADING AND EROSION CONTROL PLAN**  
**SNYDER & ASSOCIATES, INC.**


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Project No: 117.0693A  
 Sheet 16 of 20





PLANTING PLAN GENERAL NOTES  
 A. REFER TO SHEET 17 FOR PLANTING NOTES.

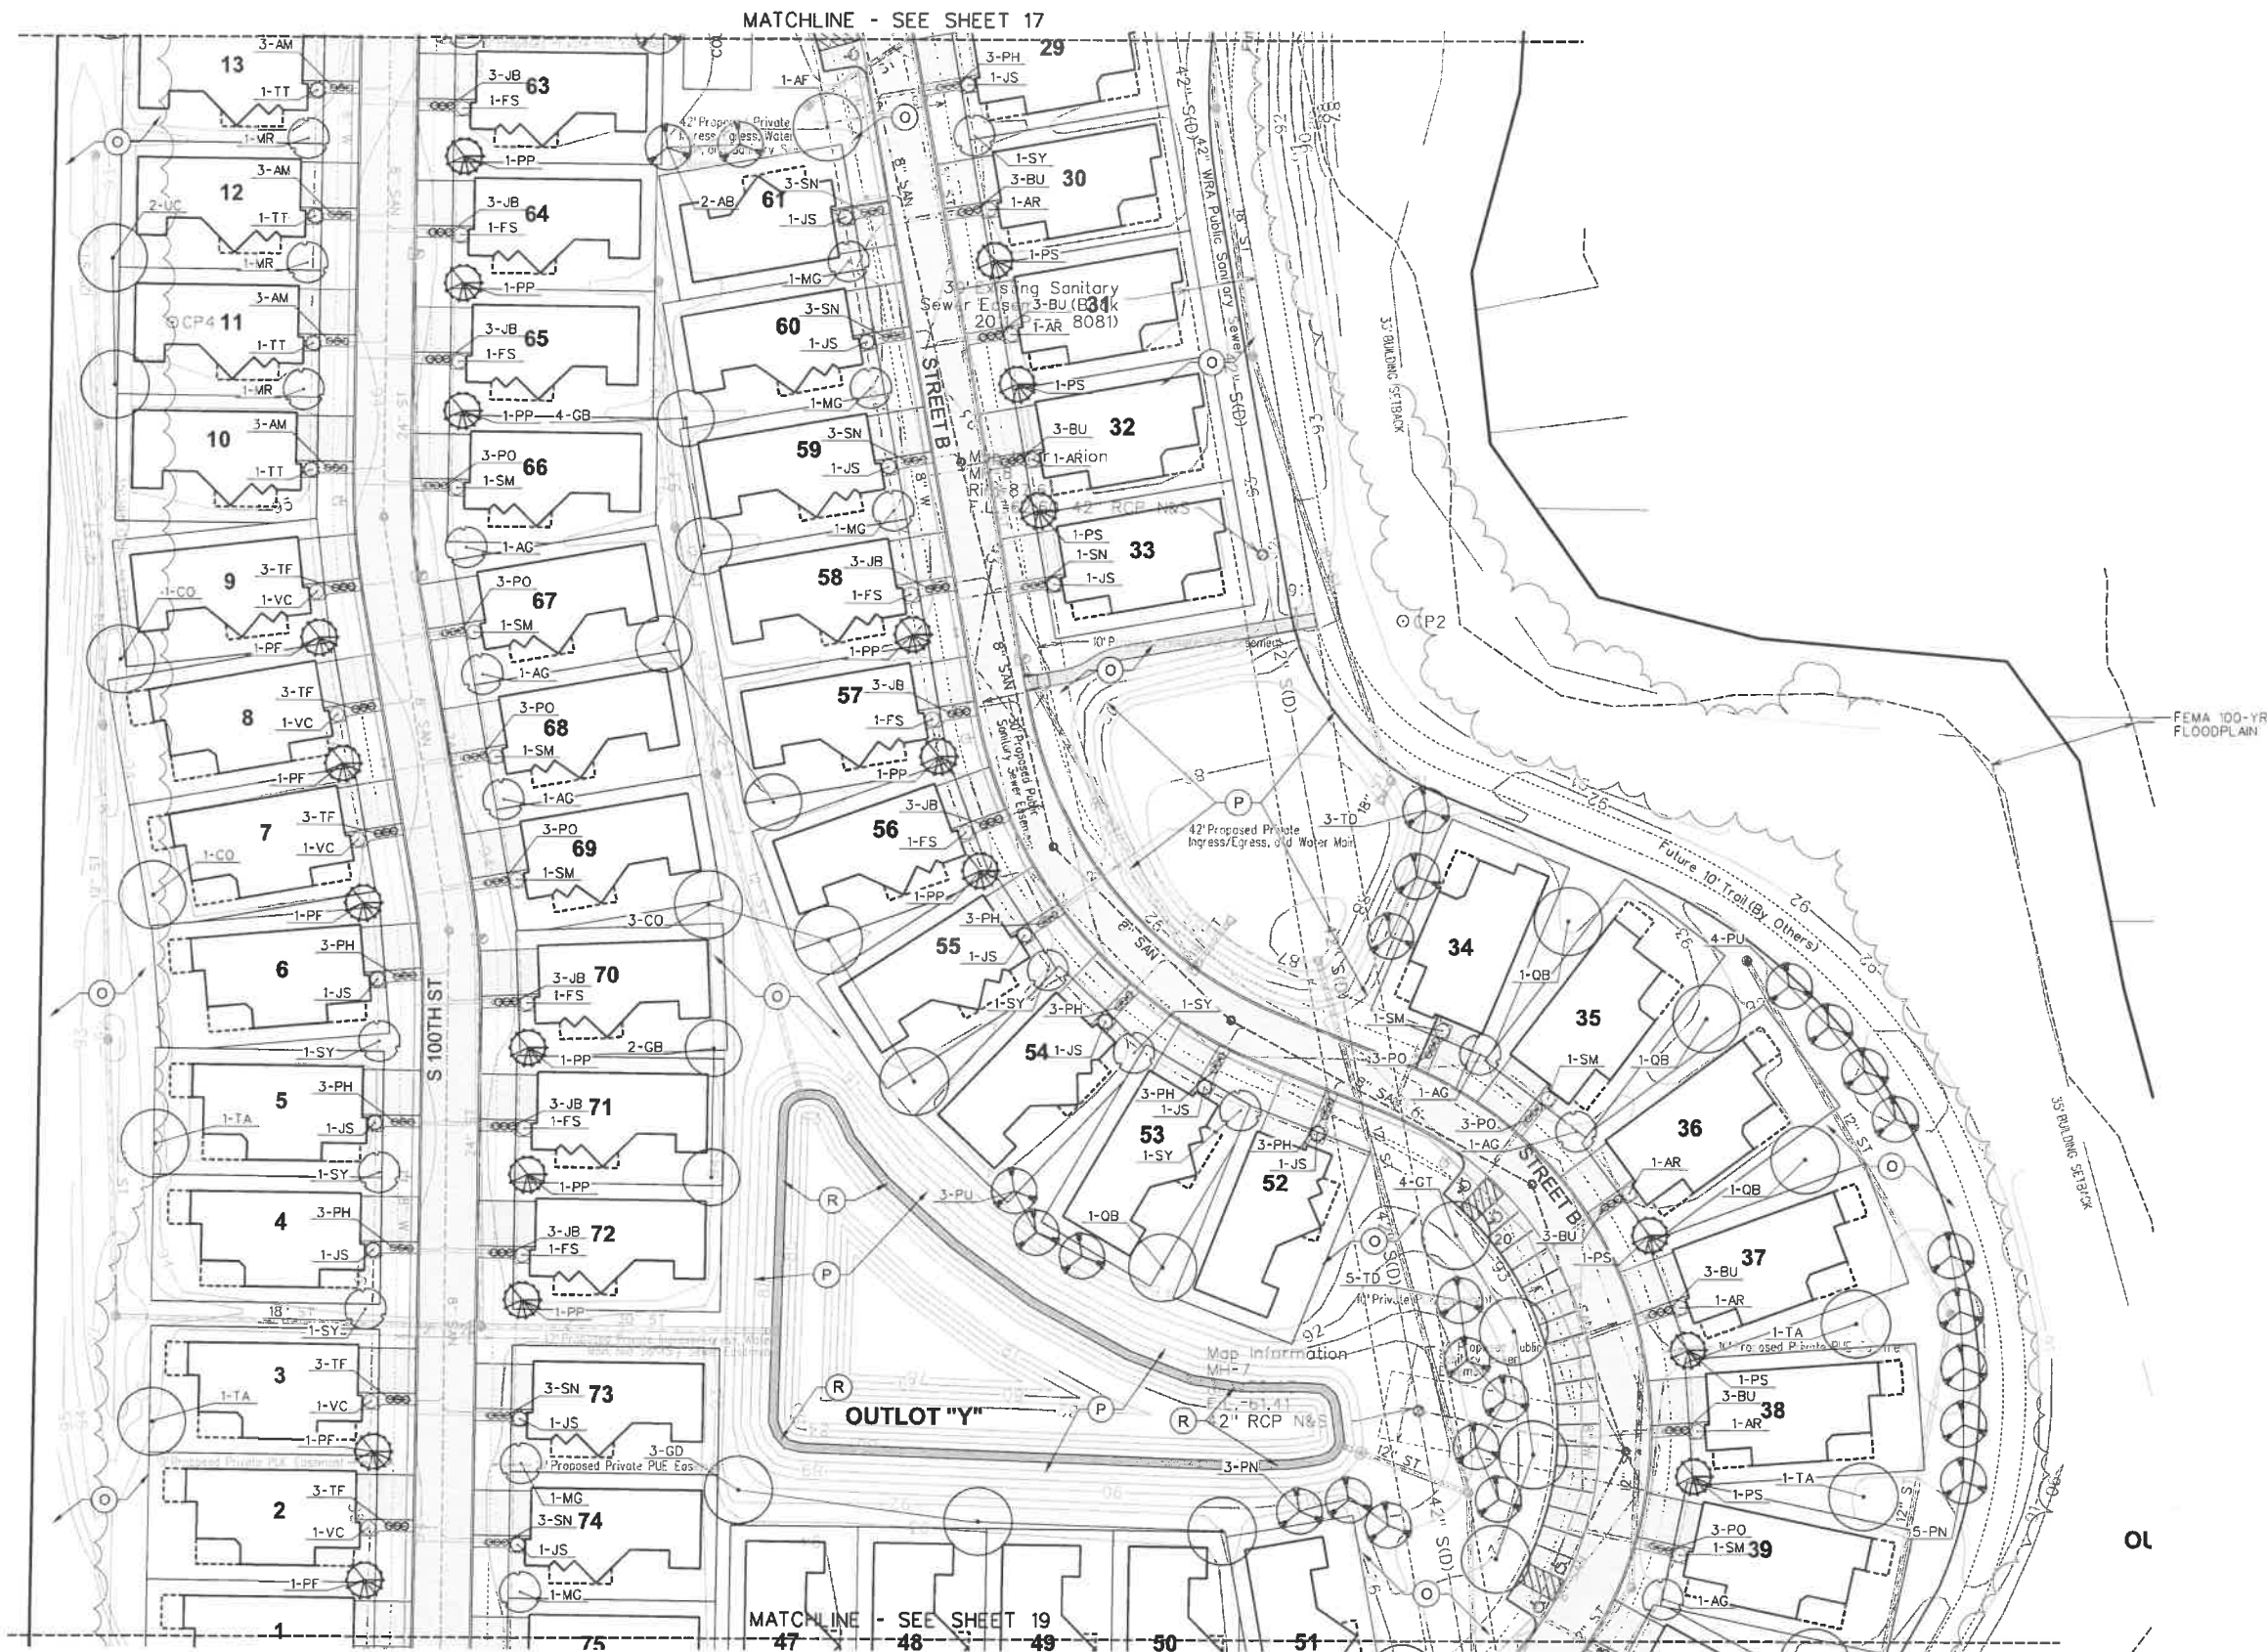

**COURTYARDS AT KINGS LANDING**

**PLANTING PLAN**

**SNYDER & ASSOCIATES, INC.**



Project No: 117.0693A  
 Sheet 18 of 20

5	AS PER CITY COMMENTS	9/3/19	RMM
4	REVISED GRADES AND UTILITIES	8/1/19	KSS
3	AS PER CITY COMMENTS	7/19/19	RMM
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Engineer:	KMM	Checked By:	EDC
Technician:	RMM	Date:	04/29/19
Field Bk:		Scale:	1"=40'
Project No:	117.0693A	Field Bk:	
		Pg:	Sheet 18 of 20

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 3/2/2019 8:40:17 AM













# KINGS LANDING EPCON CLUBHOUSE

## ADDRESS UNKNOWN


## WEST DES MOINES, IA

BUILDING DATA	
LOCATION	AREA (SF)
1ST FLOOR	3684
COVERED/STOOP/DECK	891
TOTAL	4575

WE ASSUME NO RESPONSIBILITY FOR STRUCTURAL OR DIMENSIONAL ERRORS OR OMISSIONS. WE ARE NOT A LICENSED ARCHITECT OR ENGINEER. THESE PLANS ARE PROVIDED ON AN "AS IS" BASIS AND IT IS THE SOLE RESPONSIBILITY OF THE CONTRACTOR AND/OR OWNER TO VERIFY AND CHECK ALL NOTES, DETAILS, ELEVATIONS, SECTIONS, AND FLOOR PLANS PRIOR TO CONSTRUCTION. THE CONTRACTOR AND/OR OWNER SHALL NOTIFY US IMMEDIATELY IF ANY ERRORS OR OMISSIONS FOR POSSIBLE CORRECTION ARE IDENTIFIED PRIOR TO START OF CONSTRUCTION. NO WARRANTIES EXPRESSED OR IMPLIED INCLUDING COMPLIANCE OF THIS PLAN WITH APPLICABLE BUILDING REQUIREMENTS ARE MADE. FULL SIZE SHEET SIZE = 22" X 34".



**FRONT ELEVATION**  
SCALE: 1/8" = 1'-0"

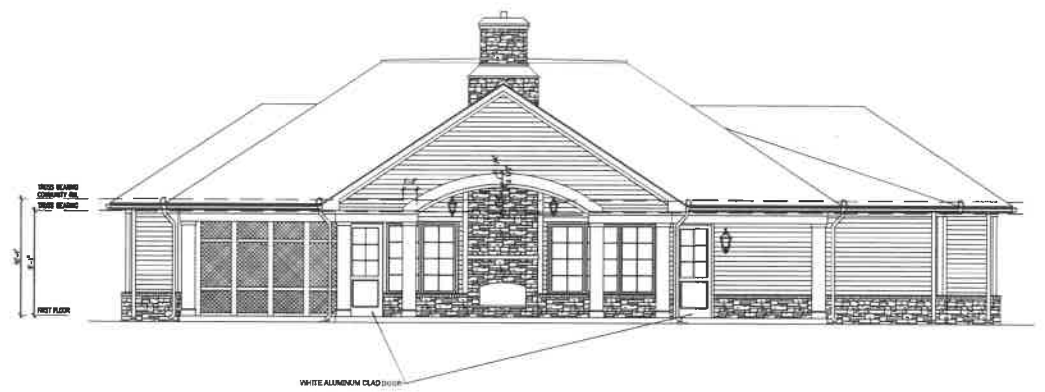

**REAR ELEVATION**  
SCALE: 1/8" = 1'-0"



KINGS LANDING -  
CLUBHOUSE ADDRESS  
UNKNOWN  
CLARITY CONSTRUCTION  
WEST DES MOINES, IA


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DATE: 08-28-2019  
PROJECT NO.: 18009  
FIELD BOOK: \_\_\_\_\_  
CLIENT NO.: \_\_\_\_\_

COVER SHEET

A01

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**LEFT ELEVATION**

SCALE : 1/4" = 1'-0"

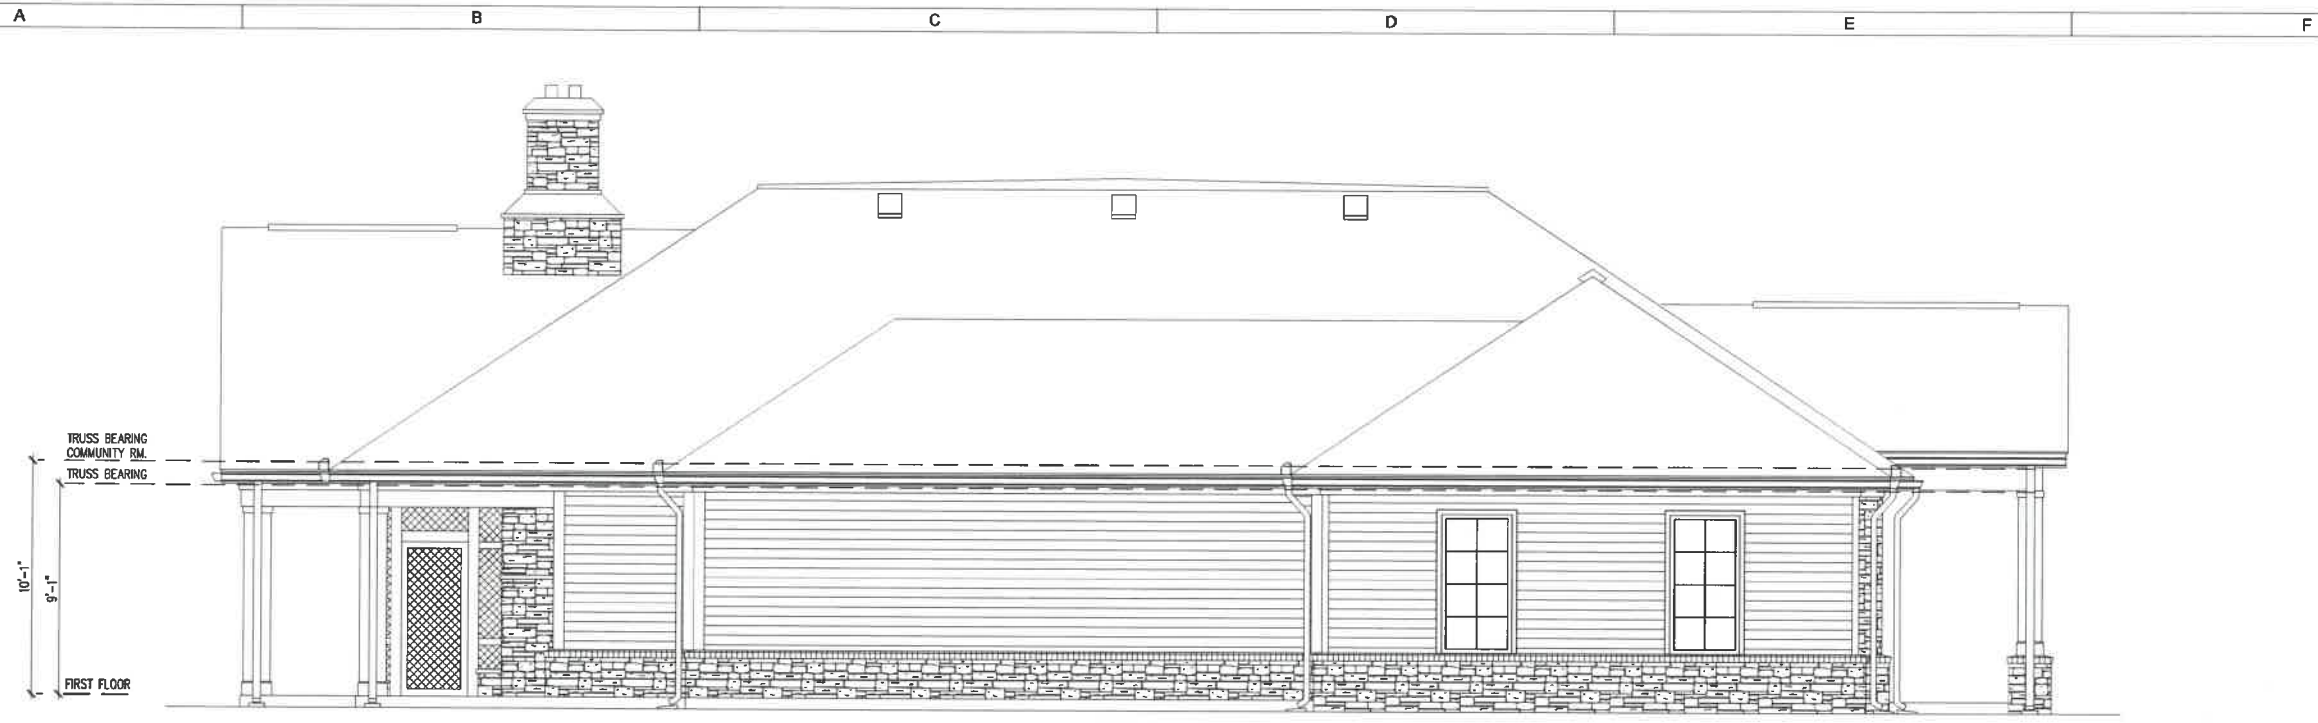

**RIGHT ELEVATION**

SCALE : 1/4" = 1'-0"

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**UNKNOWN**  
 CLARITY CONSTRUCTION  
 WEST DES MOINES, IA



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STANDARD  
 ELEVATIONS

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A B C D E F



RESIDENTIAL STYLE EXTERIOR DOOR  
-PAINT TO MATCH TRIM

**POOL HOUSE**  
SCALE: 1/4" = 1'-0"

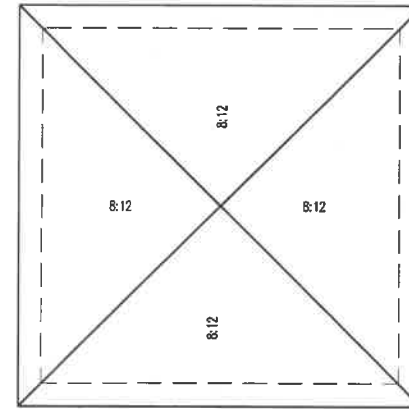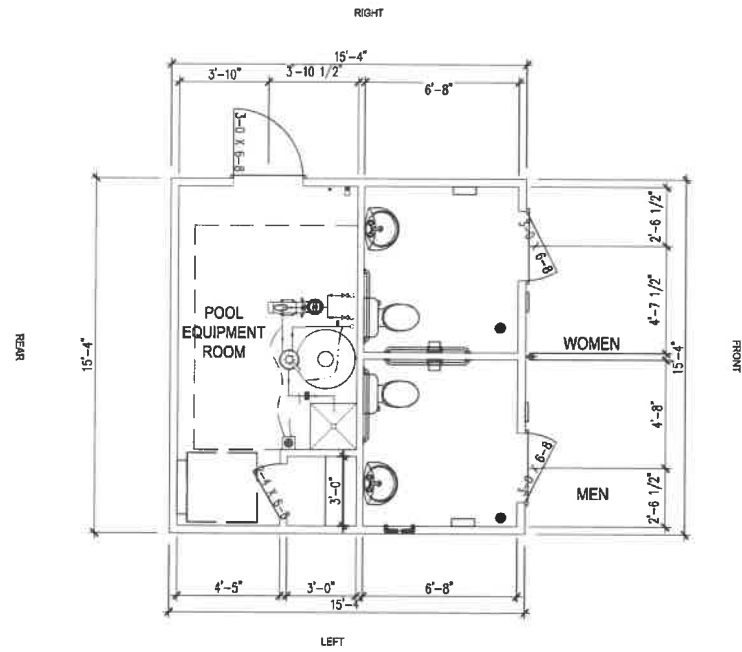A B C D E F



**KINGS LANDING -  
CLUBHOUSE ADDRESS  
UNKNOWN**  
CLARITY CONSTRUCTION  
WEST DES MOINES, IA


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FIELD BOOK: -  
CLIENT NO: -

POOL HOUSE


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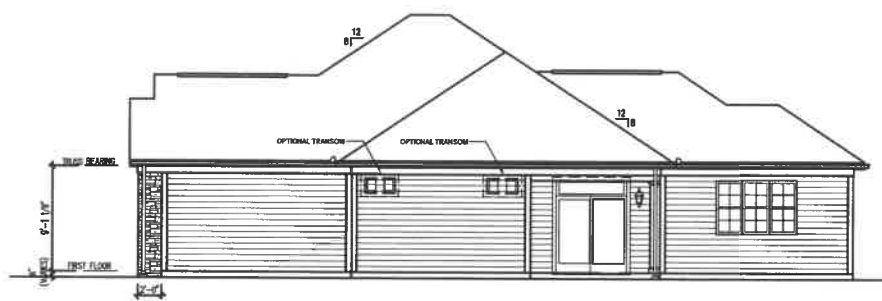
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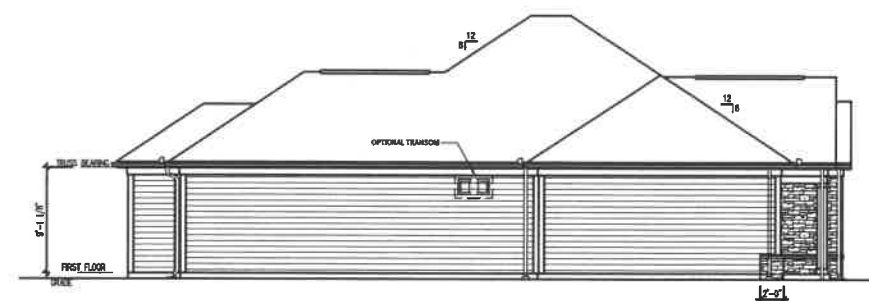
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**BACK ELEVATION**  
 SCALE: 1/4" = 1'-0"



**RIGHT ELEVATION**  
 SCALE: 1/4" = 1'-0"

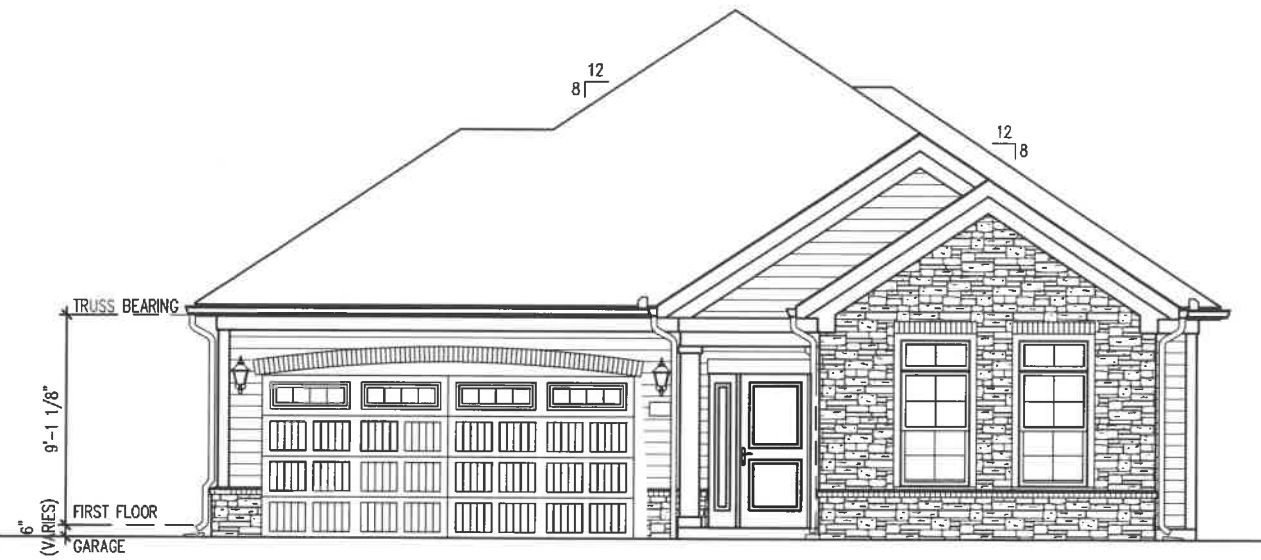

**LEFT ELEVATION**  
 SCALE: 1/4" = 1'-0"
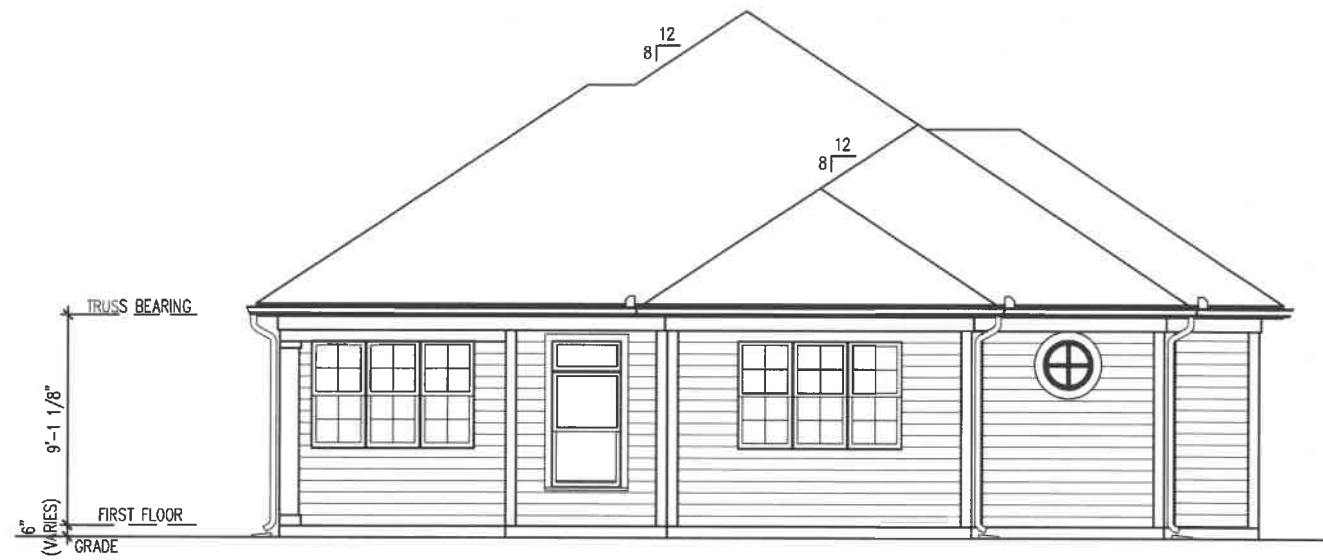
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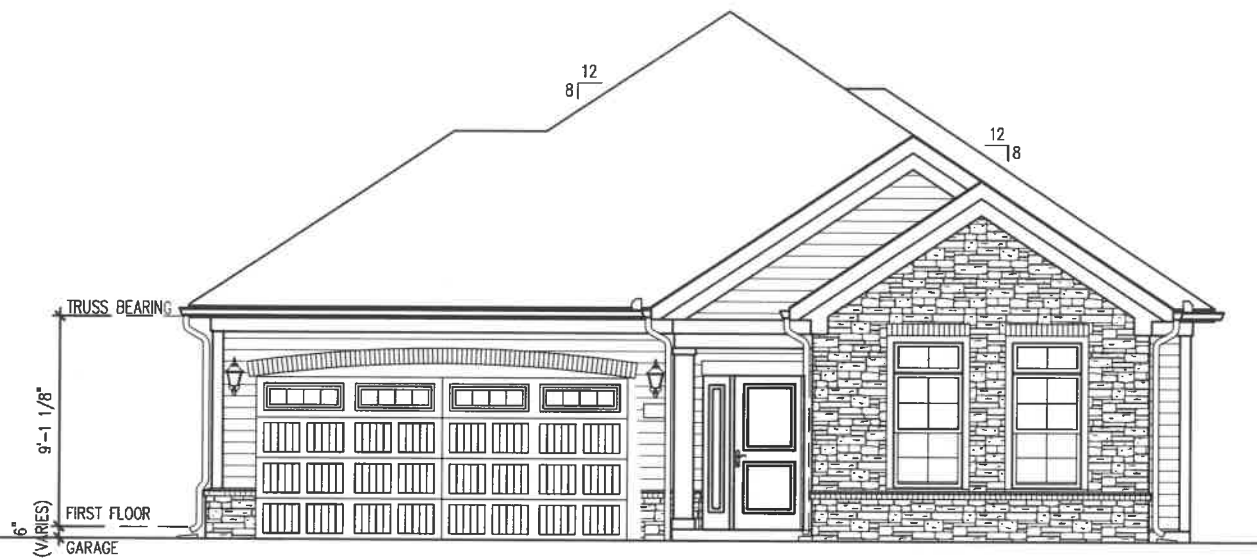
**KINGS LANDING - CAPRI  
 ELEVATIONS**

CLARITY CONSTRUCTION  
 WEST DES MOINES, IA


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**KINGS  
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 BASE**


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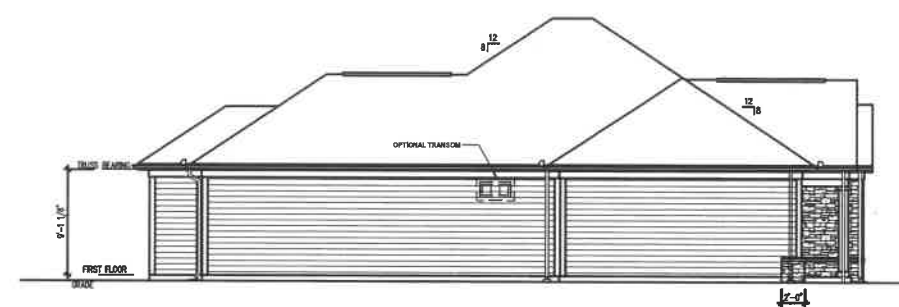
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**BACK ELEVATION**  
 SCALE : 1/4" = 1'-0"



**RIGHT ELEVATION**  
 SCALE : 1/2" = 1'-0"

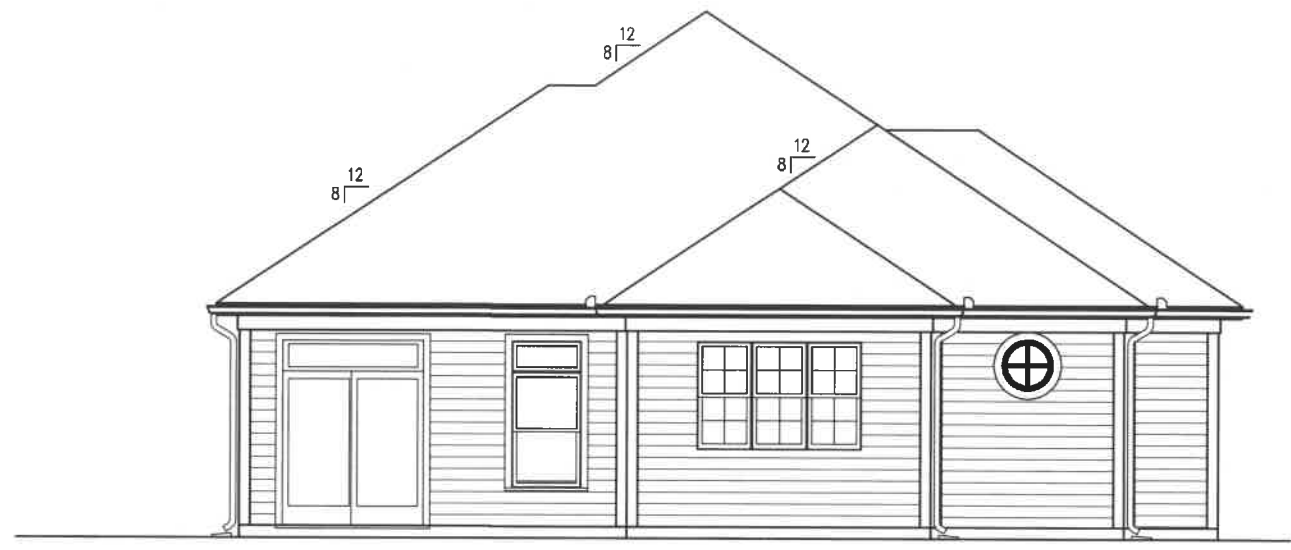

**LEFT ELEVATION**  
 SCALE : 1/2" = 1'-0"

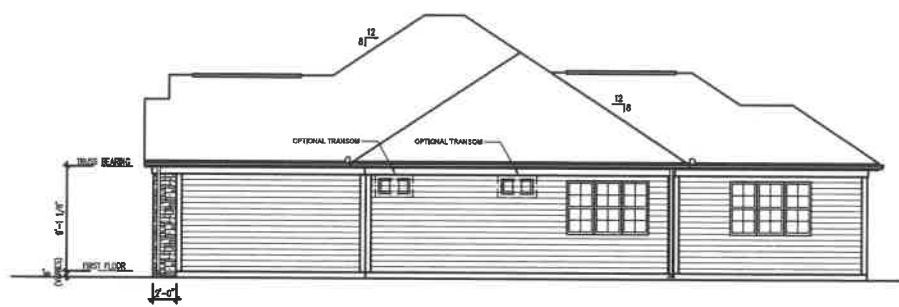KINGS LANDING - CAPRI  
 ELEVATIONS

CLARITY CONSTRUCTION  
 WEST DES MOINES, IA


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 CLIENT NO.: --

KINGS  
 LANDING - CAPRI -  
 VERANDA

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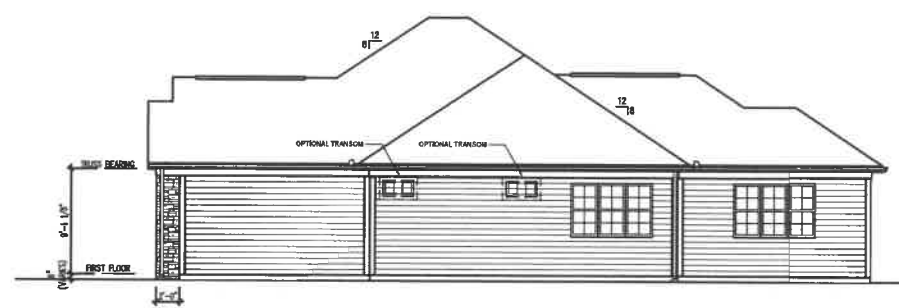
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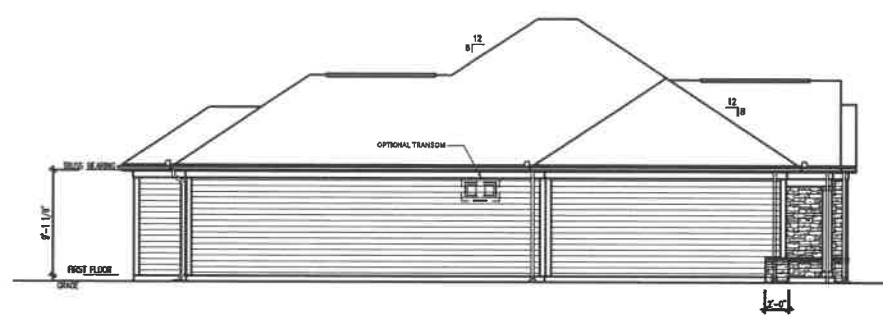
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**BACK ELEVATION**  
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**RIGHT ELEVATION**  
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**LEFT ELEVATION**  
SCALE: 1/4" = 1'-0"

KINGS LANDING - CAPRI  
ELEVATIONS

CLARITY CONSTRUCTION  
WEST DES MOINES, IA
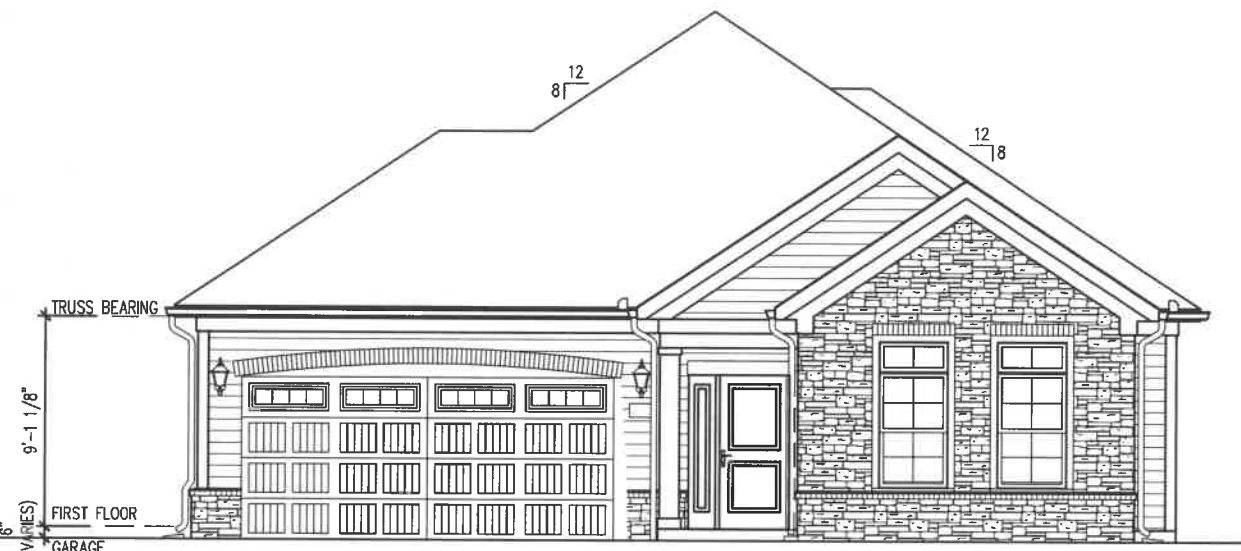
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DATE: 08-20-2019
PROJECT NO: 19069
FIELD BOOK: -
CLIENT NO: -

KINGS  
LANDING CAPRI -  
SCREEN PORCH

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# KINGS LANDING - TORINO - BASE ELEVATION



KINGS LANDING - TORINO  
ELEVATIONS

CLARITY CONSTRUCTION  
WEST DES MOINES, IA

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APPROVED FOR: JB  
ISSUED FOR: REVIEW 2  
DATE: 08-20-2019  
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KINGS LANDING -  
TORINO - BASE


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**FRONT ELEVATION**  
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**BACK ELEVATION**  
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**LEFT ELEVATION**  
SCALE : 1/4" = 1'-0"



**RIGHT ELEVATION**  
SCALE : 1/4" = 1'-0"

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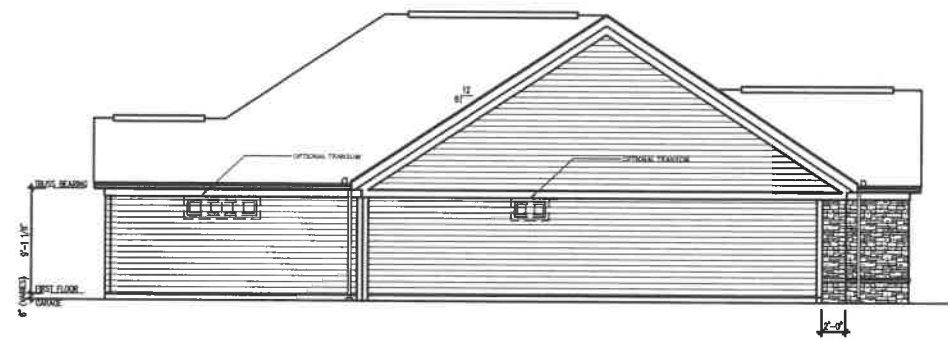
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**FRONT ELEVATION**  
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**BACK ELEVATION**  
SCALE: 1/4" = 1'-0"

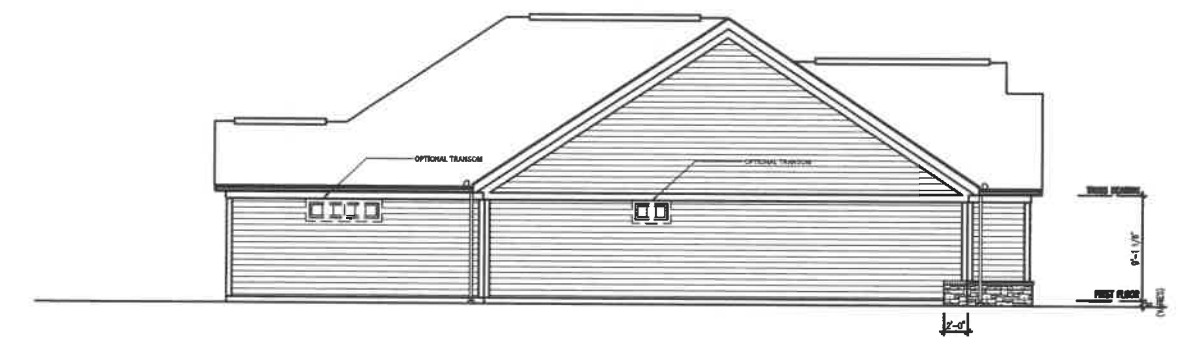

**LEFT ELEVATION**  
SCALE: 1/4" = 1'-0"



**RIGHT ELEVATION**  
SCALE: 1/4" = 1'-0"

KINGS LANDING - TORINO  
ELEVATIONS

CLARITY CONSTRUCTION  
WEST DES MOINES, IA

DRAWN: PQR	APPROVED: JB	ISSUED FOR: REVIEW 2	DATE: 08-20-2019	PROJECT NO: 19009	FIELD BOOK: -	CLIENT NO: -
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KINGS LANDING -  
TORINO - BONUS

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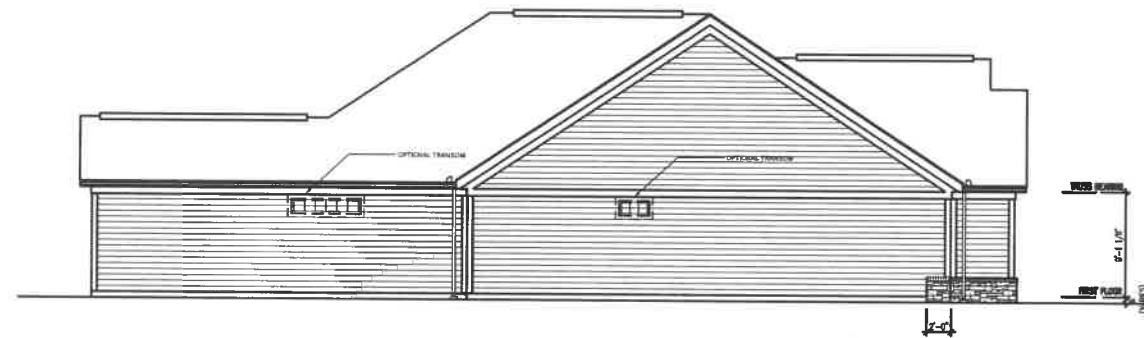
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**FRONT ELEVATION**  
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**BACK ELEVATION**  
 SCALE: 1/4" = 1'-0"



**LEFT ELEVATION**  
 SCALE: 1/2" = 1'-0"



**RIGHT ELEVATION**  
 SCALE: 1/2" = 1'-0"

KINGS LANDING - TORINO  
 ELEVATIONS

CLARITY CONSTRUCTION  
 WEST DES MOINES, IA

DRAWN FOR:	FOR
APPROVED:	JB
ISSUED FOR:	REVIEW 2
DATE:	08-20-2019
PROJECT NO.:	16009
FIELD BOOK:	-
CLIENT NO.:	-

KINGS LANDING -  
 TORINO - SITTING  
 ROOM

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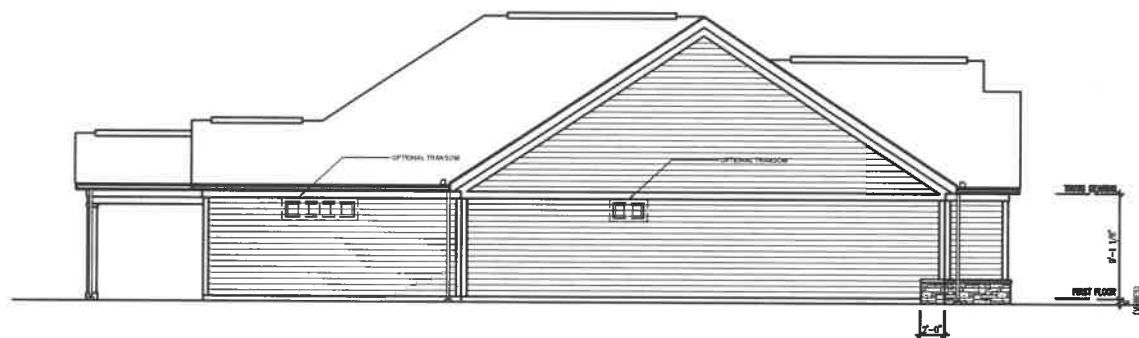
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**FRONT ELEVATION**  
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**BACK ELEVATION**  
 SCALE : 1/4" = 1'-0"



**LEFT ELEVATION**  
 SCALE : 1/4" = 1'-0"



**RIGHT ELEVATION**  
 SCALE : 1/4" = 1'-0"

KINGS LANDING - TORINO  
 ELEVATIONS

CLARITY CONSTRUCTION  
 WEST DES MOINES, IA

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KINGS LANDING -  
 TORINO - COVD  
 PORCH

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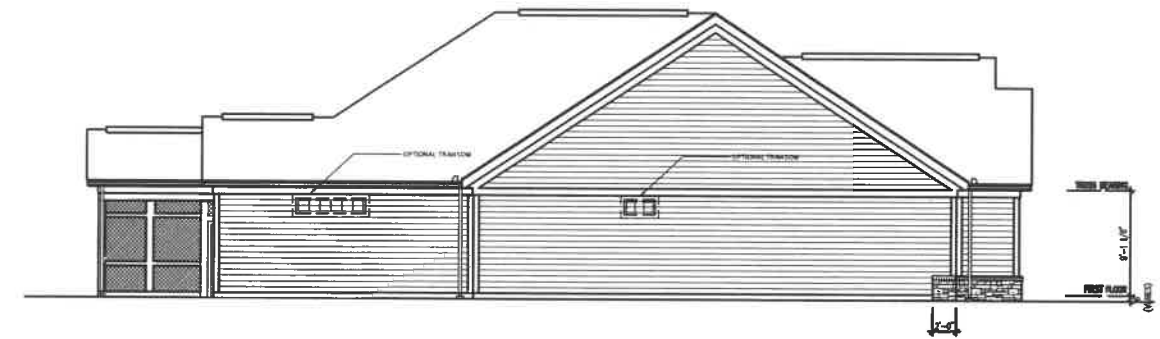
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**FRONT ELEVATION**  
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**BACK ELEVATION**  
SCALE: 1/8" = 1'-0"



**LEFT ELEVATION**  
SCALE: 1/8" = 1'-0"



**RIGHT ELEVATION**  
SCALE: 1/8" = 1'-0"

KINGS LANDING - TORINO  
ELEVATIONS

CLARITY CONSTRUCTION  
WEST DES MOINES, IA

DRAWN: PCR  
APPROVED: JB  
ISSUED FOR: REVIEW 2  
DATE: 08-20-2019  
PROJECT NO. 18169  
FIELD BOOK: —  
CLIENT NO. —


KINGS LANDING -  
TORINO - SCREEN  
PORCH

A05

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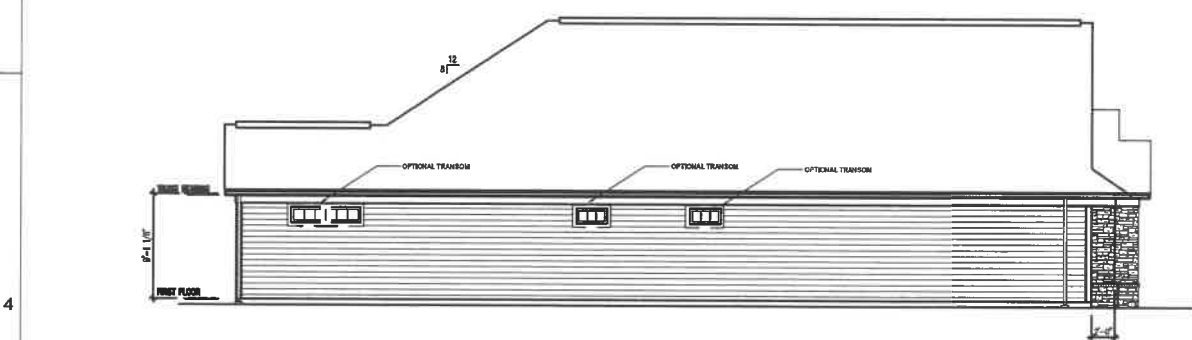
# KINGS LANDING - VERONA - BASE ELEVATION




**FRONT ELEVATION**  
SCALE: 1/4" = 1'-0"

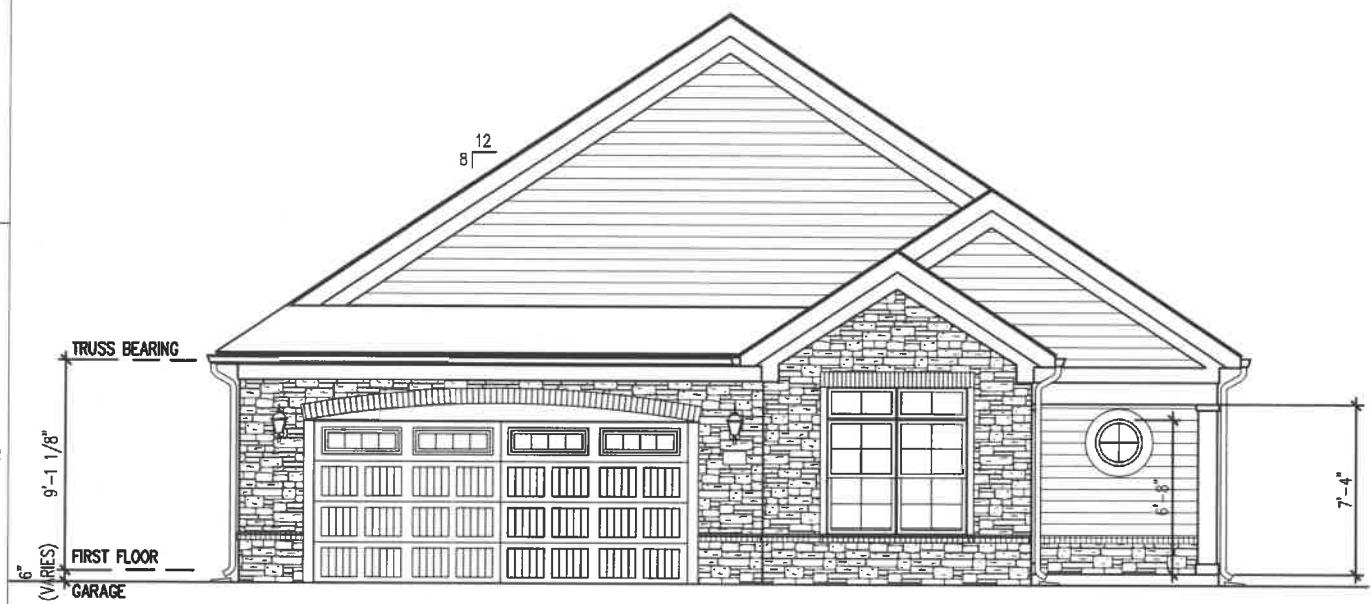

**BACK ELEVATION**  
SCALE: 1/4" = 1'-0"



**LEFT ELEVATION**  
SCALE: 1/4" = 1'-0"

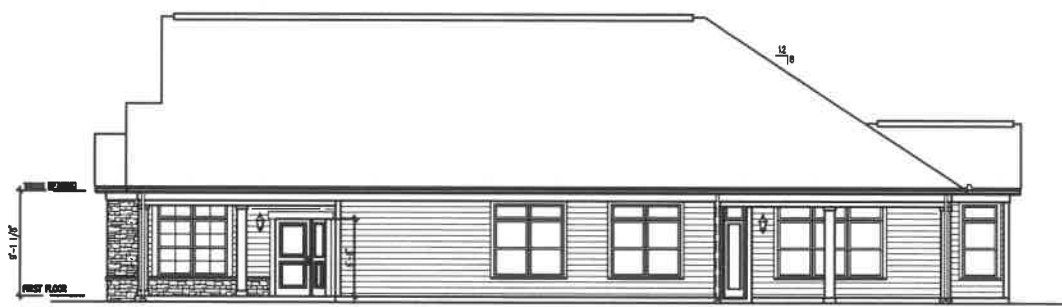

**RIGHT ELEVATION**  
SCALE: 1/4" = 1'-0"

Z:\SBC Design\1800 - Kings Landing\Sheet 1 - Front\2019\08 - Elevation\Kings Landing Verona Base.dwg  
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KINGS LANDING - VERONA  
 ELEVATIONS

CLARITY CONSTRUCTION  
 WEST DES MOINES, IA


DRAWN: PCR
APPROVED: JB
ISSUED FOR: REVIEW 2
DATE: 08-20-2019
PROJECT NO.: 18009
FIELD BOOK: -
CLIENT NO: -

KINGS LANDING -  
 VERONA - BASE


# KINGS LANDING - VERONA - BONUS ELEVATION



**FRONT ELEVATION**  
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**BACK ELEVATION**  
 SCALE: 1/4" = 1'-0"

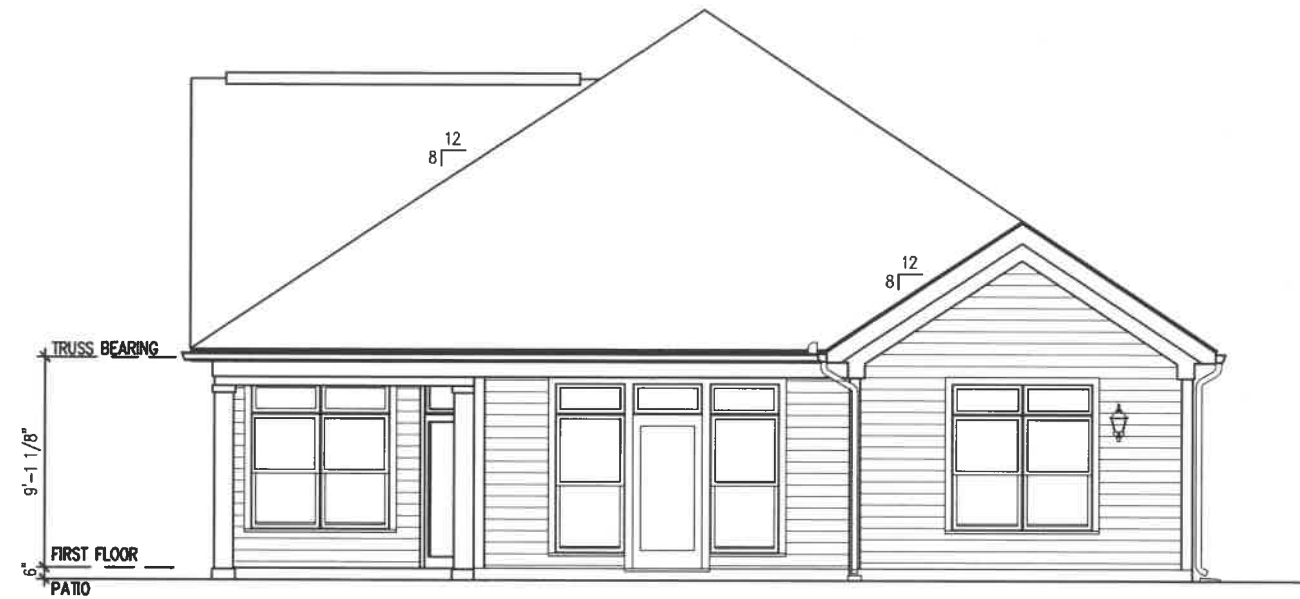

**LEFT ELEVATION**  
 SCALE: 1/4" = 1'-0"

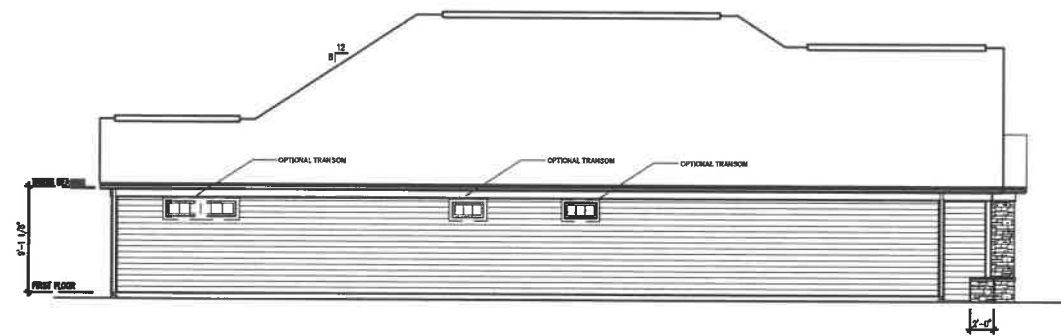

**RIGHT ELEVATION**  
 SCALE: 1/4" = 1'-0"

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KINGS LANDING - VERONA  
 ELEVATIONS


CLARITY CONSTRUCTION  
 WEST DES MOINES, IA

DRAWN: PCR
APPROVED: JB
ISSUED FOR: REVIEW 2
DATE: 06-20-2018
PROJECT NO.: 18009
FIELD BOOK: -
CLIENT NO.: -

KINGS LANDING -  
 VERONA - BONUS




# KINGS LANDING - VERONA - COV'D PORCH ELEV.

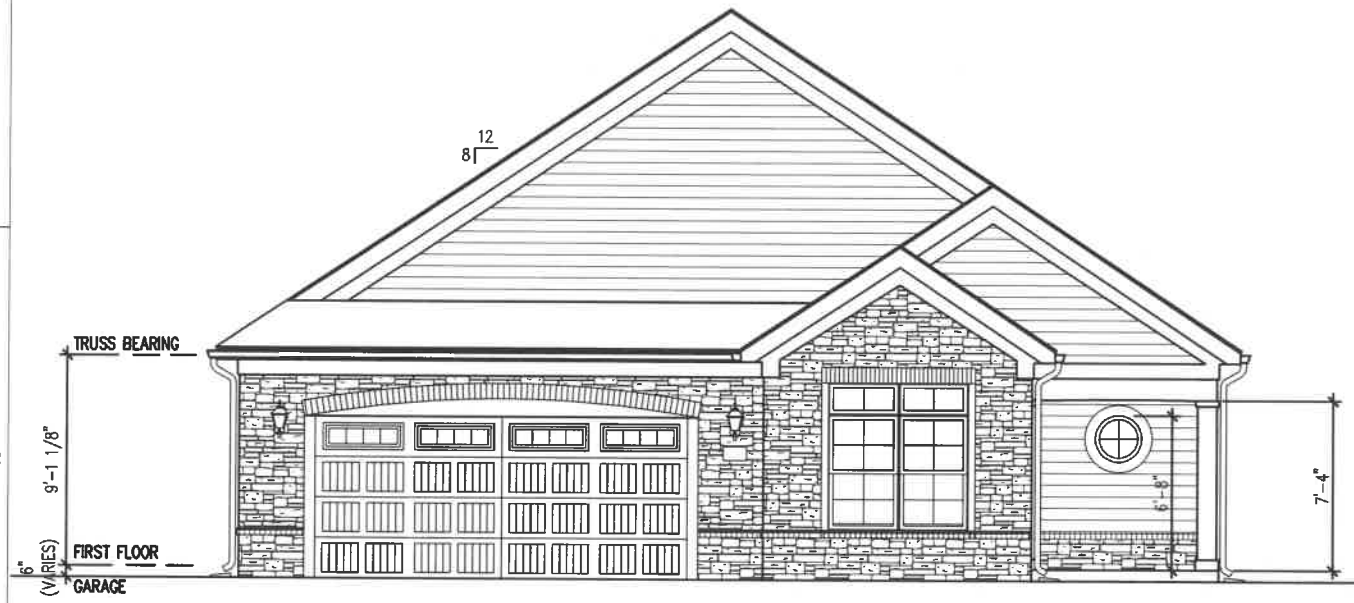

**FRONT ELEVATION**  
SCALE: 1/8" = 1'-0"



**BACK ELEVATION**  
SCALE: 1/8" = 1'-0"

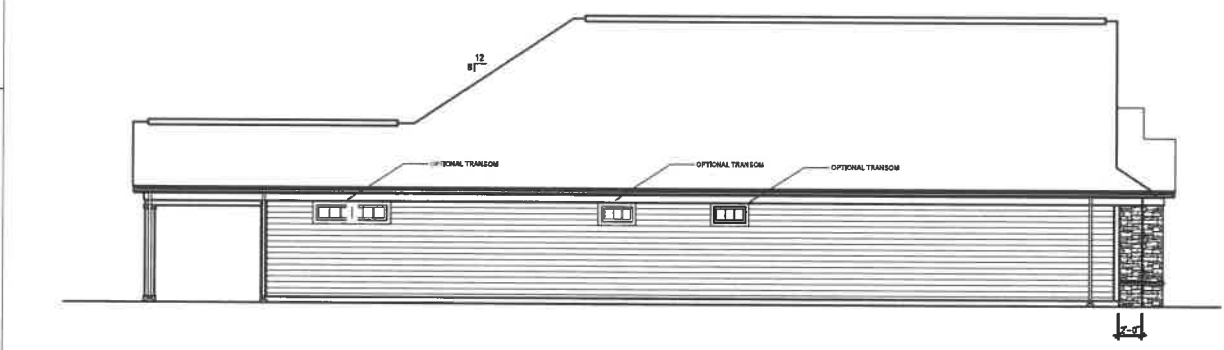

**LEFT ELEVATION**  
SCALE: 1/8" = 1'-0"



**RIGHT ELEVATION**  
SCALE: 1/8" = 1'-0"

KINGS LANDING - VERONA  
ELEVATIONS


CLARITY CONSTRUCTION  
WEST DES MOINES, IA

DRAWN:	PCR
APPROVED:	JB
ISSUED FOR:	REVIEW 2
DATE:	08-20-2019
PROJECT NO.:	19009
FIELD BOOK:	-
CLIENT NO.:	-


KINGS LANDING -  
VERONA - COV'D  
PORCH

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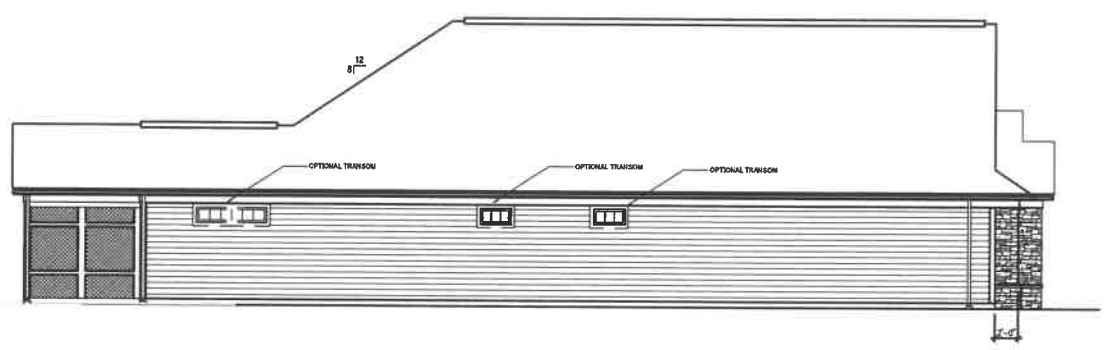
# KINGS LANDING - VERONA - SCREEN PORCH ELEV.

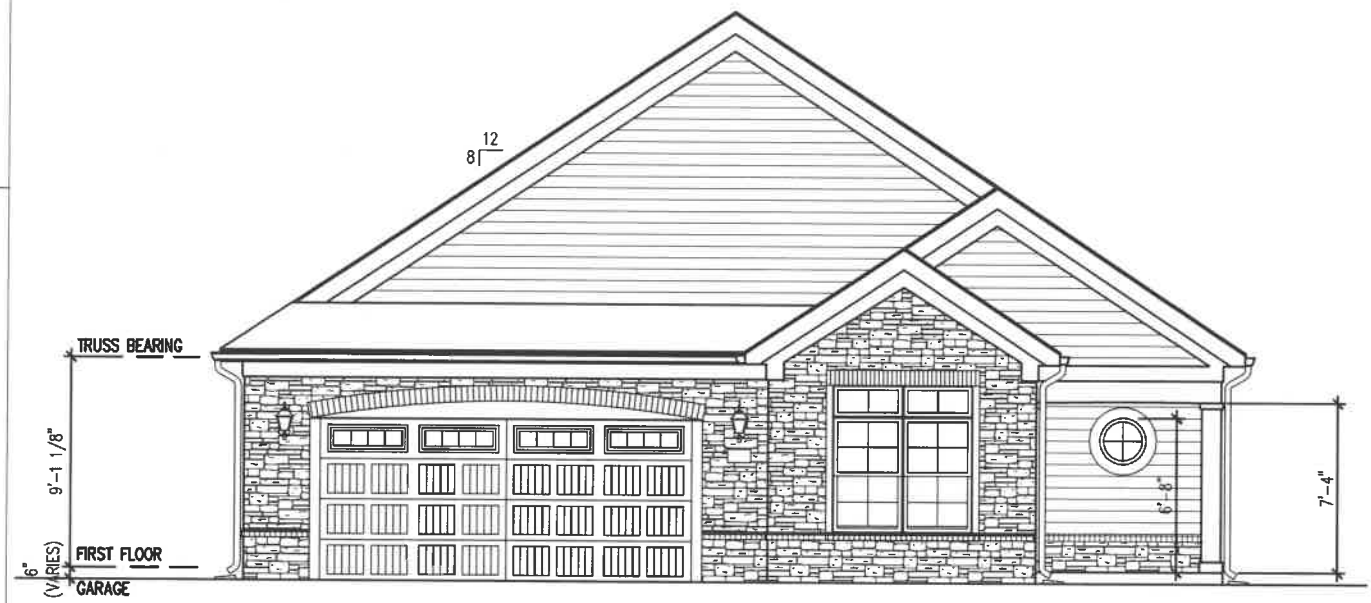

**FRONT ELEVATION**  
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**BACK ELEVATION**  
 SCALE: 1/8" = 1'-0"

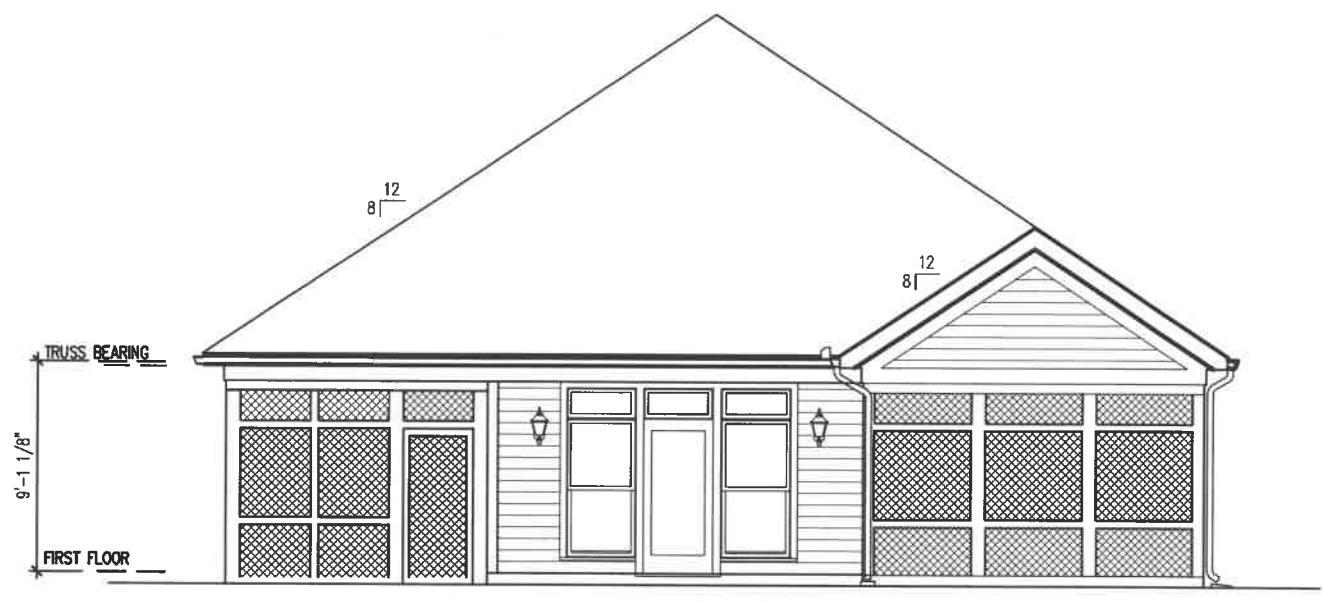

**LEFT ELEVATION**  
 SCALE: 1/8" = 1'-0"



**RIGHT ELEVATION**  
 SCALE: 1/8" = 1'-0"

KINGS LANDING - VERONA  
 ELEVATIONS

CLARITY CONSTRUCTION  
 WEST DES MOINES, IA

DRAWN: PBR  
 APPROVED: JB  
 ISSUED FOR: REVIEW 2  
 DATE: 08-20-2019  
 PROJECT NO: 16069  
 FIELD BOOK: -  
 CLIENT NO: -

KINGS LANDING -  
 VERONA - SCREEN  
 PORCH

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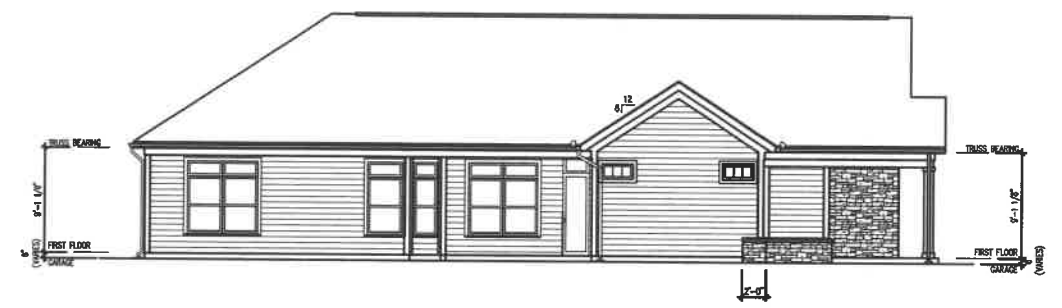
# KINGS LANDING - PALAZZO - BASE ELEVATION




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**BACK ELEVATION**  
SCALE: 1/4" = 1'-0"



**LEFT ELEVATION**  
SCALE: 1/4" = 1'-0"



**RIGHT ELEVATION**  
SCALE: 1/4" = 1'-0"

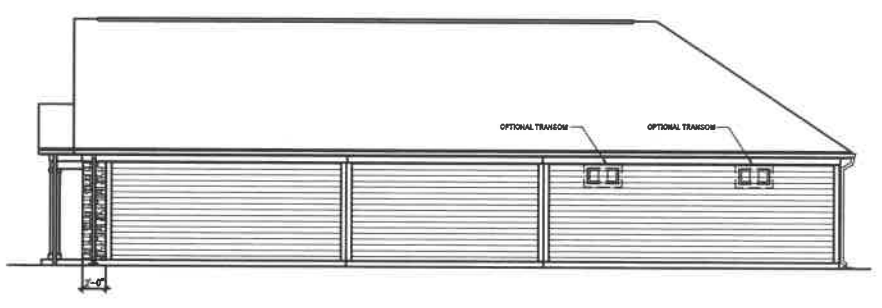**KINGS LANDING - PALAZZO ELEVATIONS**  
WEST DES MOINES, IA  
CLARITY CONSTRUCTION

DRAWN FOR: \_\_\_\_\_  
APPROVED FOR: REVIEW 3  
ISSUED FOR: REVIEW 3  
DATE: 08-27-2019  
PROJECT NO.: 19059  
FIELD BOOK: \_\_\_\_\_  
CLIENT NO.: \_\_\_\_\_

**KINGS LANDING - PALAZZO - BASE**

**A01**


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Project: 19059 08/27/19



# KINGS LANDING - PALAZZO - BONUS ELEVATION




**FRONT ELEVATION**  
SCALE: 1/8" = 1'-0"

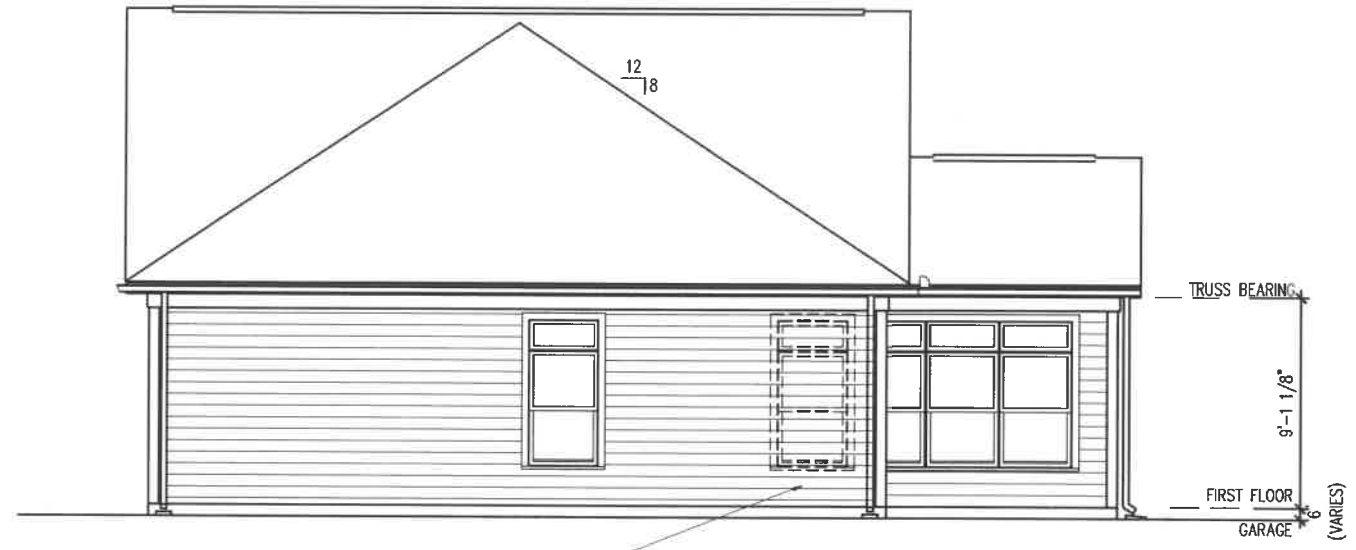


**BACK ELEVATION**  
SCALE: 1/8" = 1'-0"

OPTIONAL WINDOWS  
-REQ'D ON LOTS 42-46, 77-79

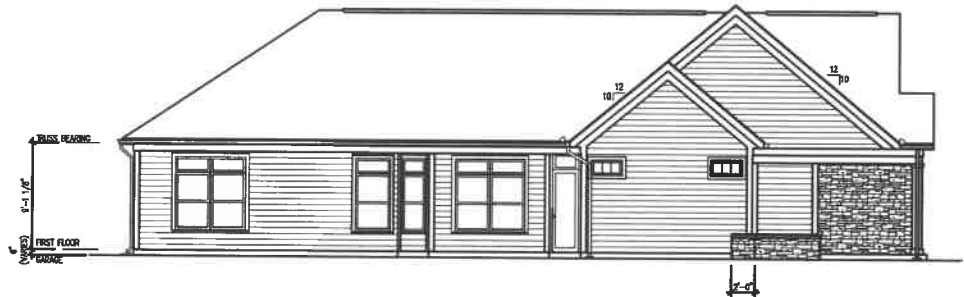

**LEFT ELEVATION**  
SCALE: 1/8" = 1'-0"

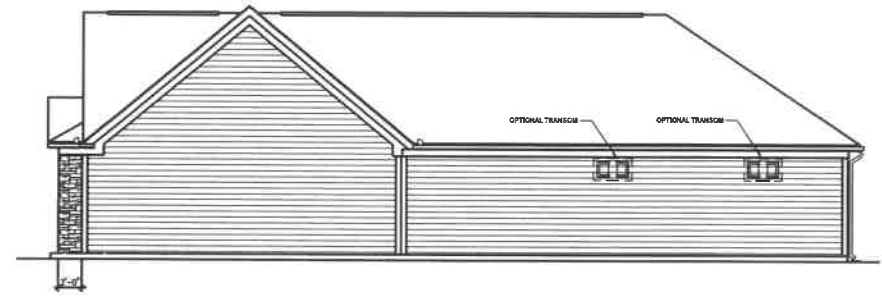

**RIGHT ELEVATION**  
SCALE: 1/8" = 1'-0"

KINGS LANDING - PALAZZO  
ELEVATIONS

WEST DES MOINES, IA  
CLARITY CONSTRUCTION

DRAWN: FOR  
APPROVED: JB  
ISSUED FOR: REVIEW 3  
DATE: 08-27-2019  
PROJECT NO: 19069  
FIELD BOOK: --  
CLIENT NO: --

KINGS  
LANDING\_PALAZZO  
- BONUS

A02

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# KINGS LANDING - PALAZZO - 4 SEASONS ELEVATION




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SCALE : 1/2" = 1'-0"



**BACK ELEVATION**  
SCALE : 1/2" = 1'-0"



**LEFT ELEVATION**  
SCALE : 1/2" = 1'-0"

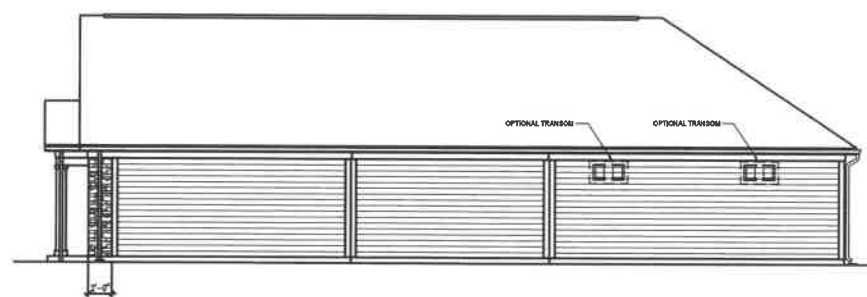

**RIGHT ELEVATION**  
SCALE : 1/2" = 1'-0"

KINGS LANDING - PALAZZO  
ELEVATIONS

WEST DES MOINES, IA  
CLARITY CONSTRUCTION

DRAWN: PCR  
APPROVED: JZ  
ISSUED FOR: REVIEW 3  
DATE: 08-27-2019  
PROJECT NO: 19509  
FIELD BOOK: -  
CLIENT NO: -

KINGS  
LANDING PALAZZO  
- 4 SEASONS

A03

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# KINGS LANDING - PALAZZO - COV'D PORCH ELEVATION




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**BACK ELEVATION**  
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**LEFT ELEVATION**  
 SCALE: 1/8" = 1'-0"




**RIGHT ELEVATION**  
 SCALE: 1/8" = 1'-0"


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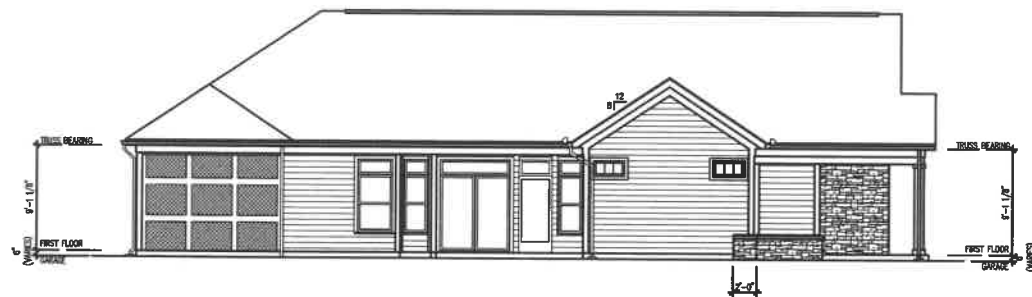
# KINGS LANDING - PALAZZO - SCREEN PORCH ELEVATION

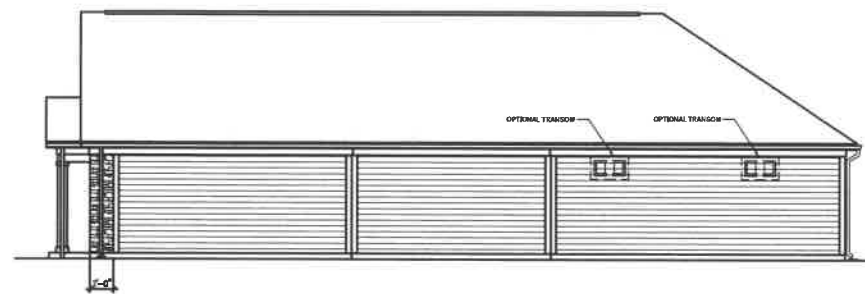


**FRONT ELEVATION**  
SCALE: 1/8" = 1'-0"

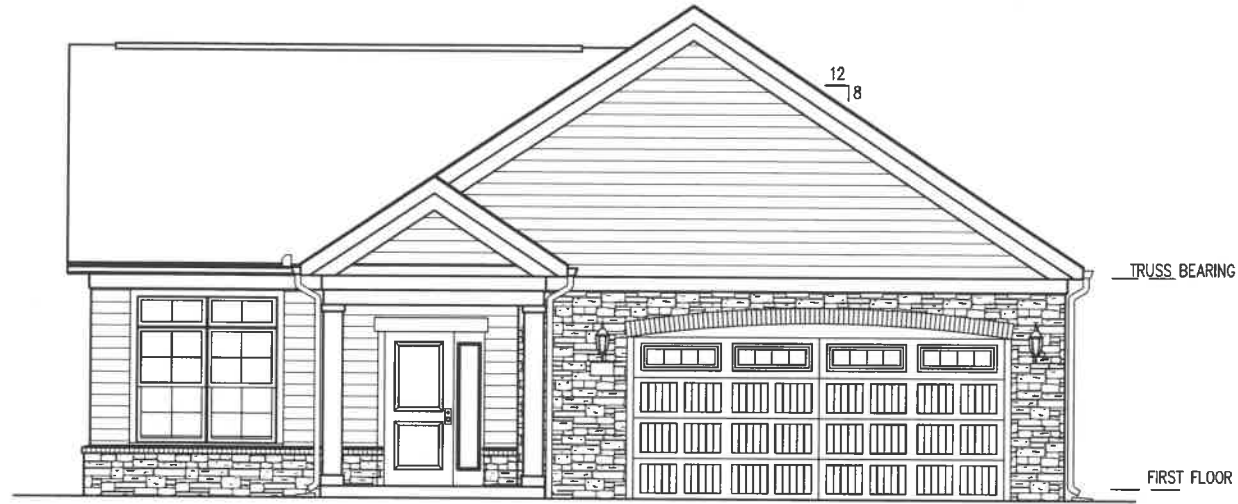

**BACK ELEVATION**  
SCALE: 1/8" = 1'-0"

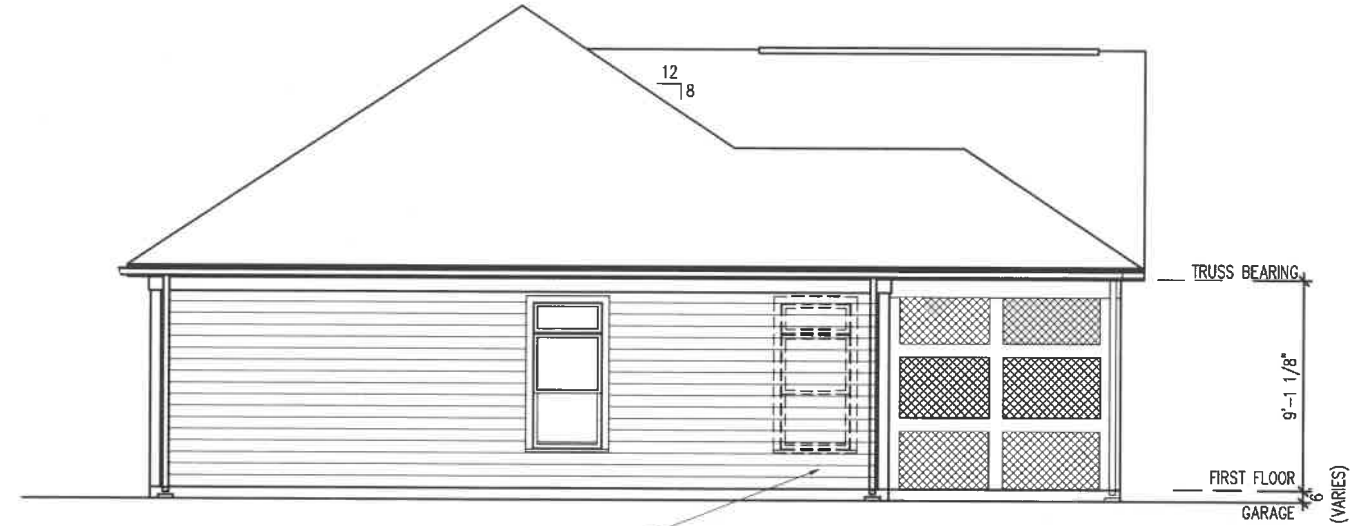

**LEFT ELEVATION**  
SCALE: 1/8" = 1'-0"

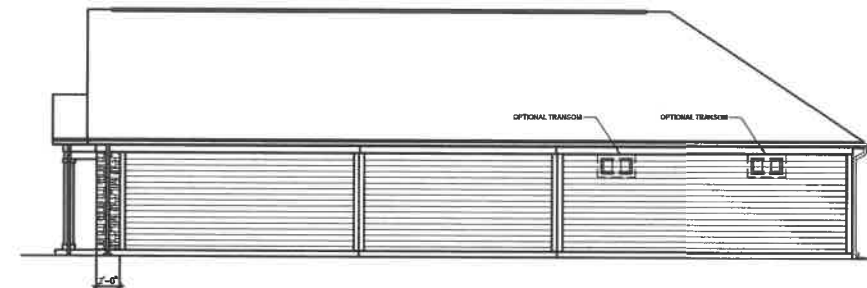

**RIGHT ELEVATION**  
SCALE: 1/8" = 1'-0"

KINGS LANDING - PALAZZO  
ELEVATIONS


WEST DES MOINES, IA  
CLARITY CONSTRUCTION

DRAWN: PCR  
APPROVED: JB  
ISSUED FOR: REVIEW 3  
DATE: 08-27-2019  
PROJECT NO: 19009  
FIELD BOOK: --  
CLIENT NO: --

KINGS  
LANDING PALAZZO  
- SCREEN PORCH

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# KINGS LANDING - PORTICO - BASE ELEVATION

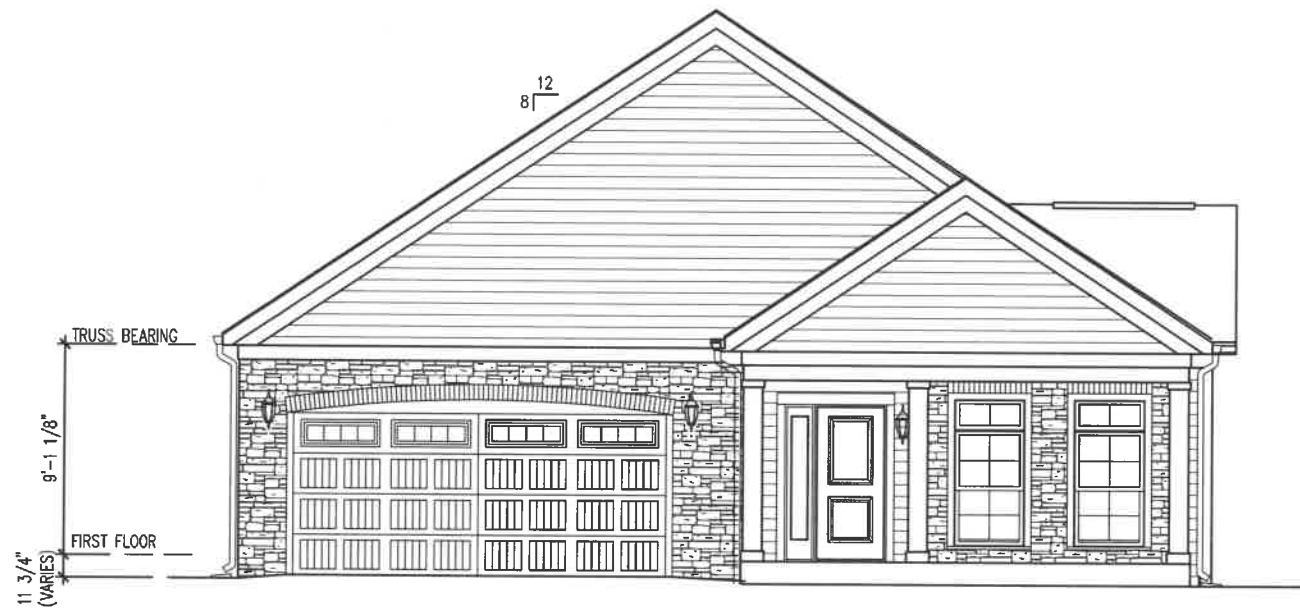


**FRONT ELEVATION**  
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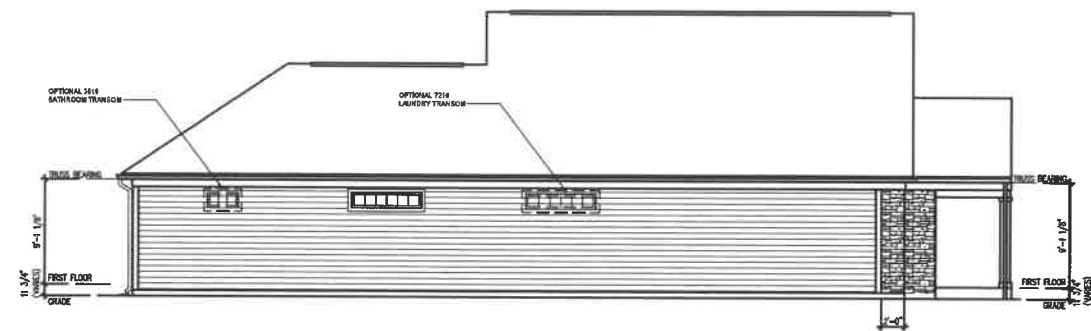


**BACK ELEVATION**  
SCALE : 1/8" = 1'-0"

OPTIONAL WINDOWS  
-REQ'D ON LOTS 42-46, 77-79

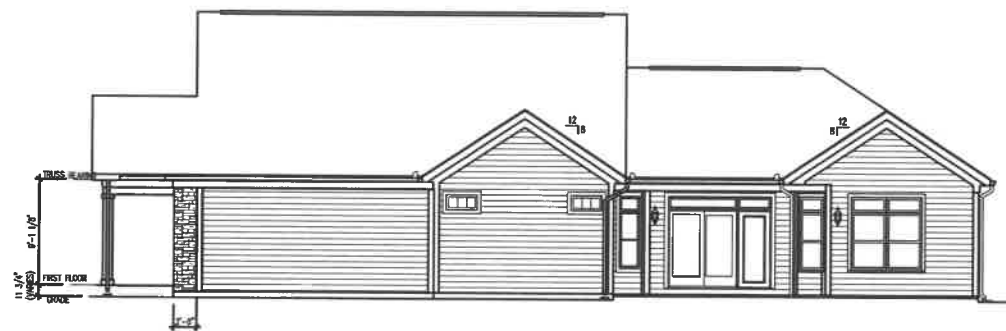

**RIGHT ELEVATION**  
SCALE : 1/8" = 1'-0"



**LEFT ELEVATION**  
SCALE : 1/8" = 1'-0"

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**KINGS LANDING - PORTICO  
ELEVATIONS**

CLARITY CONSTRUCTION  
WEST DES MOINES, IA

DRAWN: JRM
APPROVED: JB
ISSUED FOR: REVIEW 3
DATE: 09/27/2019
PROJECT NO: 18009
FIELD BOOK: -
CLIENT NO: -

**KINGS  
LANDING\_PORTICO  
- BASE**

**A01**


# KINGS LANDING - PORTICO - BONUS ELEVATION



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**BACK ELEVATION**  
SCALE: 1/4" = 1'-0"



**RIGHT ELEVATION**  
SCALE: 1/4" = 1'-0"

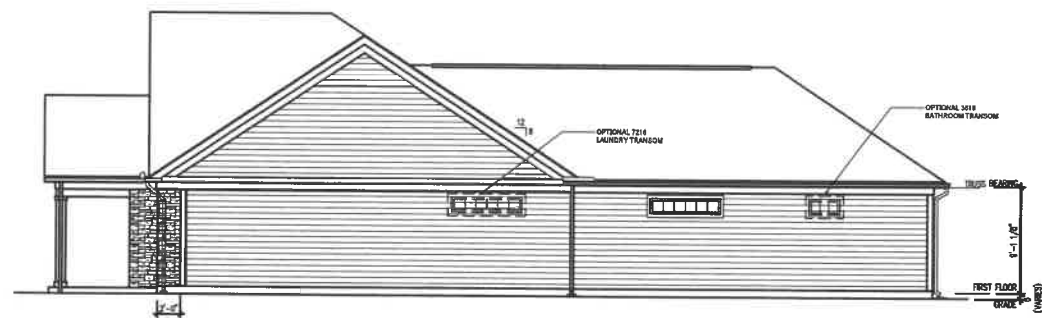

**LEFT ELEVATION**  
SCALE: 1/4" = 1'-0"

KINGS LANDING - PORTICO  
ELEVATIONS

CLARITY CONSTRUCTION  
WEST DES MOINES, IA


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PROJECT NO.:	19029
FIELD BOOK:	
CLIENT NO.:	

KINGS LANDING PALAZZO  
- BONUS


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# KINGS LANDING - PORTICO - 4 SEASONS ELEVATION




**FRONT ELEVATION**  
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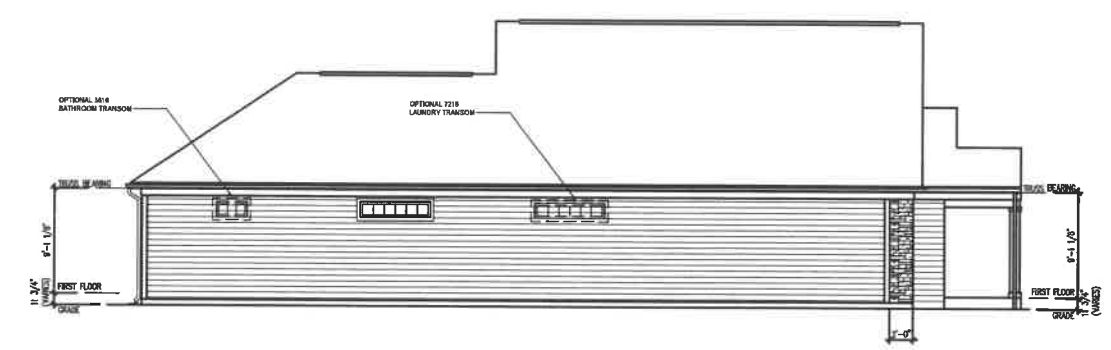


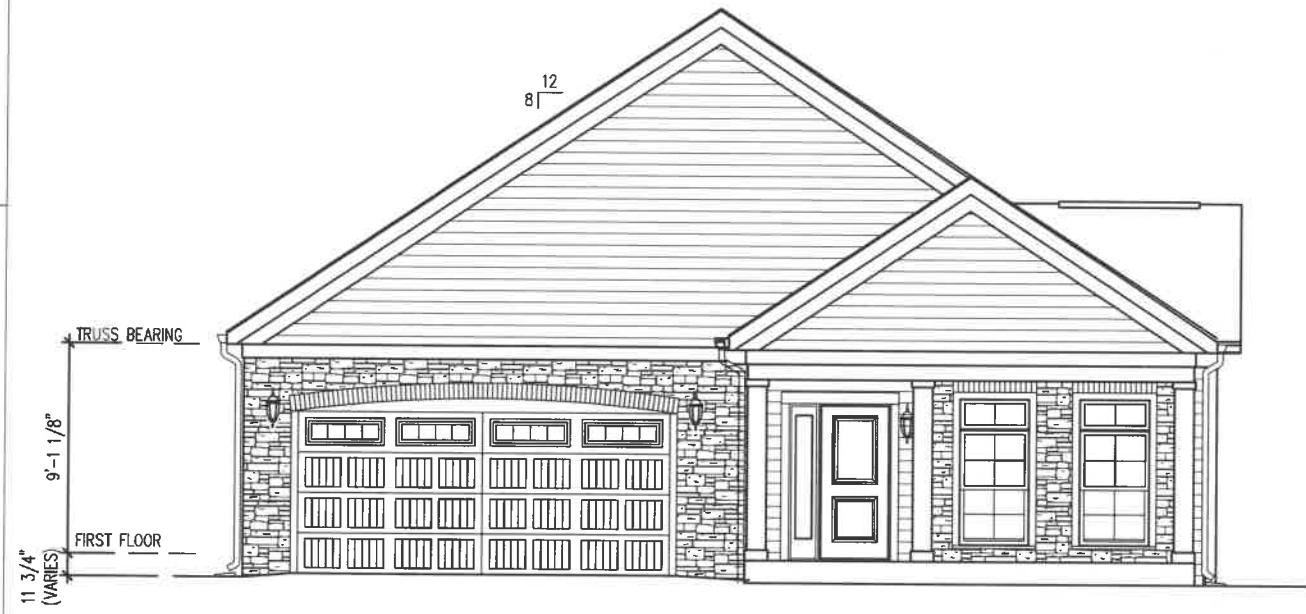**BACK ELEVATION**  
 SCALE : 1/8" = 1'-0"

OPTIONAL WINDOWS  
 -REQ'D ON LOTS 42-46, 77-79

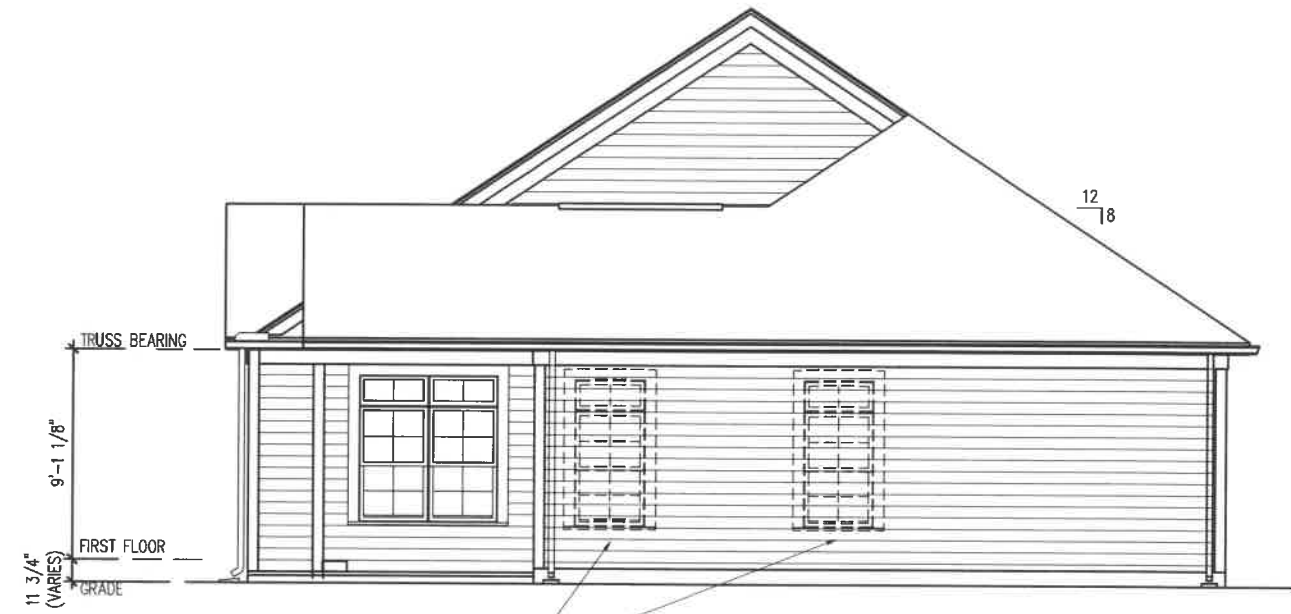

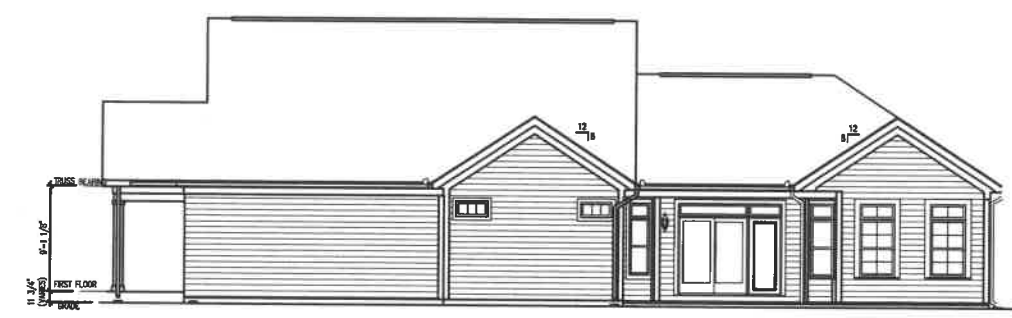**RIGHT ELEVATION**  
 SCALE : 1/8" = 1'-0"



**LEFT ELEVATION**  
 SCALE : 1/8" = 1'-0"

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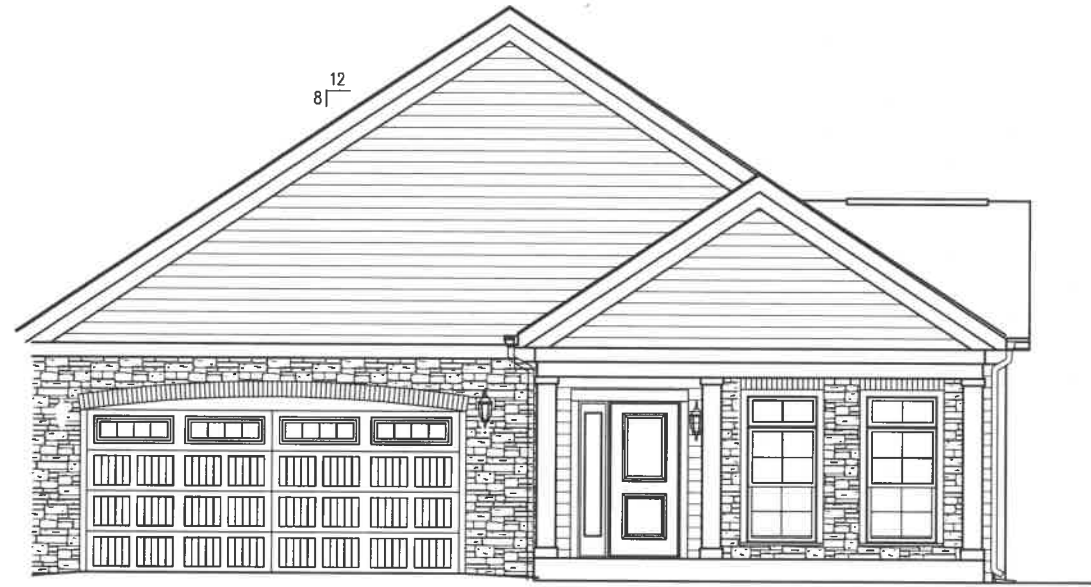
**KINGS LANDING - PORTICO  
 ELEVATIONS**

CLARITY CONSTRUCTION  
 WEST DES MOINES, IA


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DATE:	08/27/2019
PROJECT NO.:	18009
FIELD BOOK:	-
CLIENT NO.:	-

**KINGS  
 LANDING - PORTICO  
 - 4 SEASONS**

# KINGS LANDING - PORTICO - COV'D PORCH ELEVATION




**FRONT ELEVATION**  
SCALE: 1/4" = 1'-0"

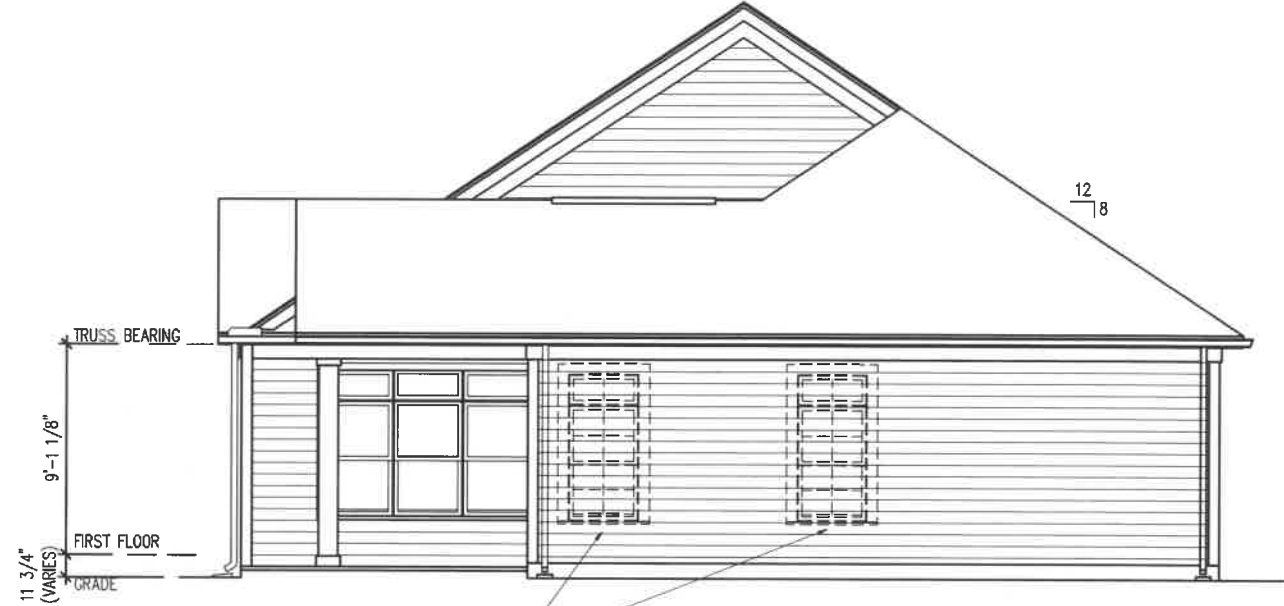

**BACK ELEVATION**  
SCALE: 1/4" = 1'-0"



**RIGHT ELEVATION**  
SCALE: 1/4" = 1'-0"

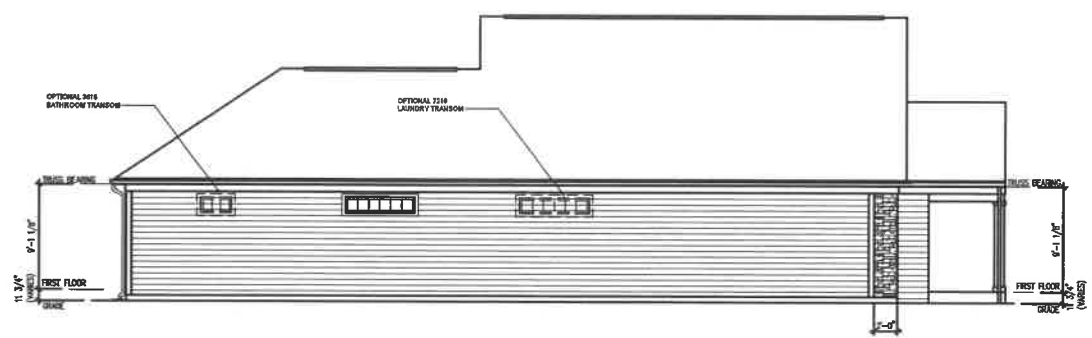

**LEFT ELEVATION**  
SCALE: 1/4" = 1'-0"

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**KINGS LANDING - PORTICO  
ELEVATIONS**

CLARITY CONSTRUCTION  
WEST DES MOINES, IA

DRAWN: JRM  
 APPROVED: JB  
 ISSUED FOR: REVIEW 3  
 DATE: 08/27/2019  
 PROJECT NO: 19009  
 FIELD BOOK: --  
 CLIENT NO: --


**KINGS  
LANDING PORTICO  
- COVD PORCH**

**A04**

# KINGS LANDING - PORTICO - SCREEN PORCH ELEVATION




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**BACK ELEVATION**  
SCALE: 1/4" = 1'-0"

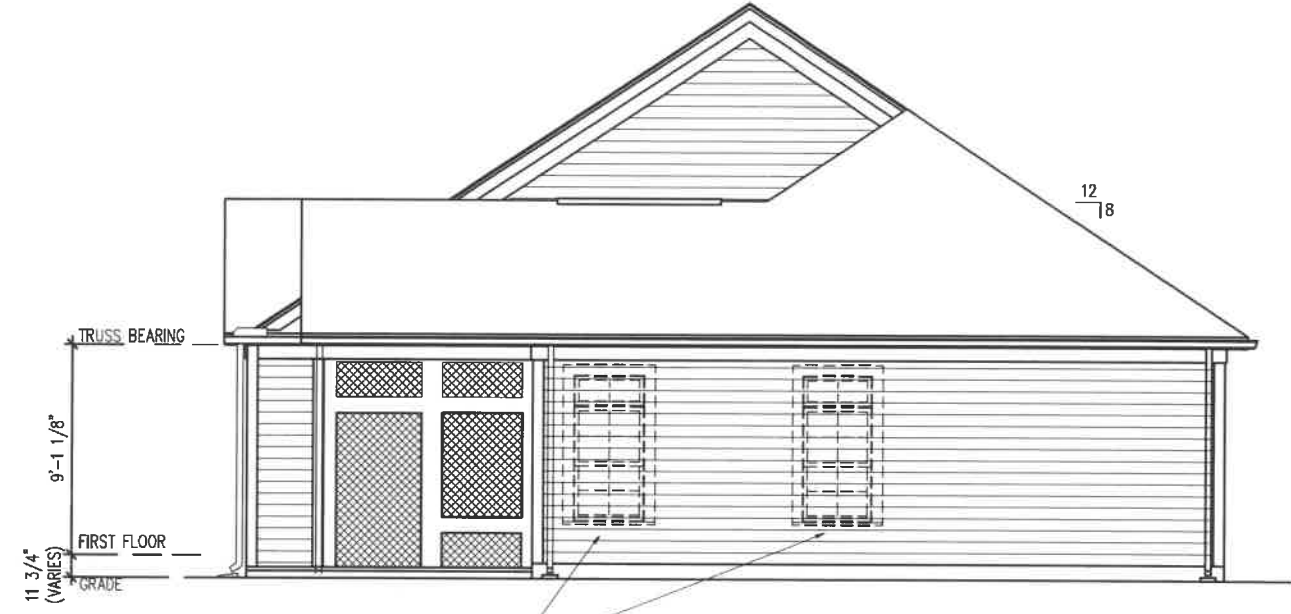

**RIGHT ELEVATION**  
SCALE: 1/2" = 1'-0"



**LEFT ELEVATION**  
SCALE: 1/4" = 1'-0"

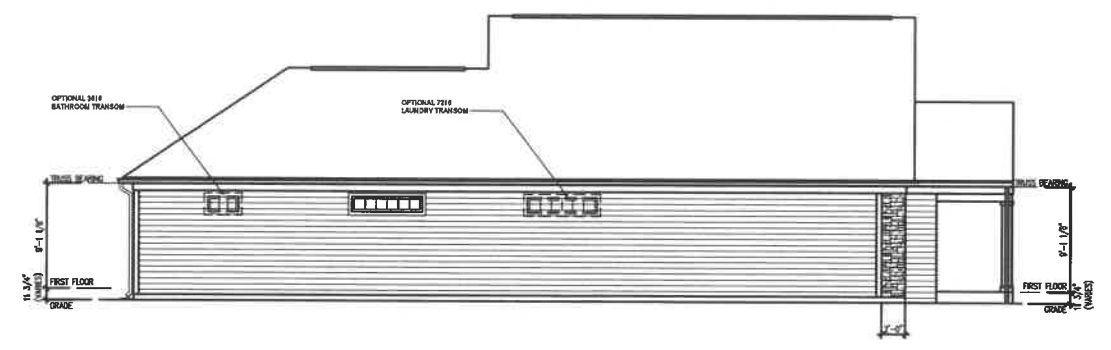KINGS LANDING - PORTICO  
ELEVATIONS

CLARITY CONSTRUCTION  
WEST DES MOINES, IA

DRAWN: JRM
APPROVED: JB
ISSUED FOR: REVIEW 3
DATE: 08/27/2019
PROJECT NO: 19039
FIELD BOOK: 1
CLIENT NO: 1

KINGS LANDING PORTICO  
- SCREEN PORCH

A05


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# KINGS LANDING - PROMENADE - BASE ELEVATION



**FRONT ELEVATION**  
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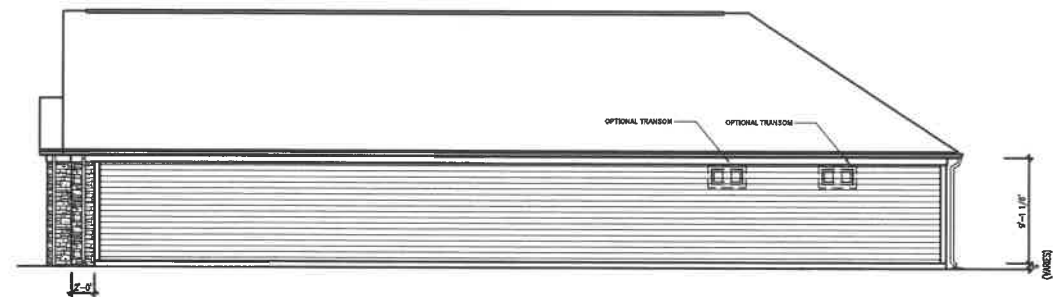


**BACK ELEVATION**  
 SCALE : 1/4" = 1'-0"

OPTIONAL WINDOWS  
 -REQ'D ON LOTS 42-46, 77-78

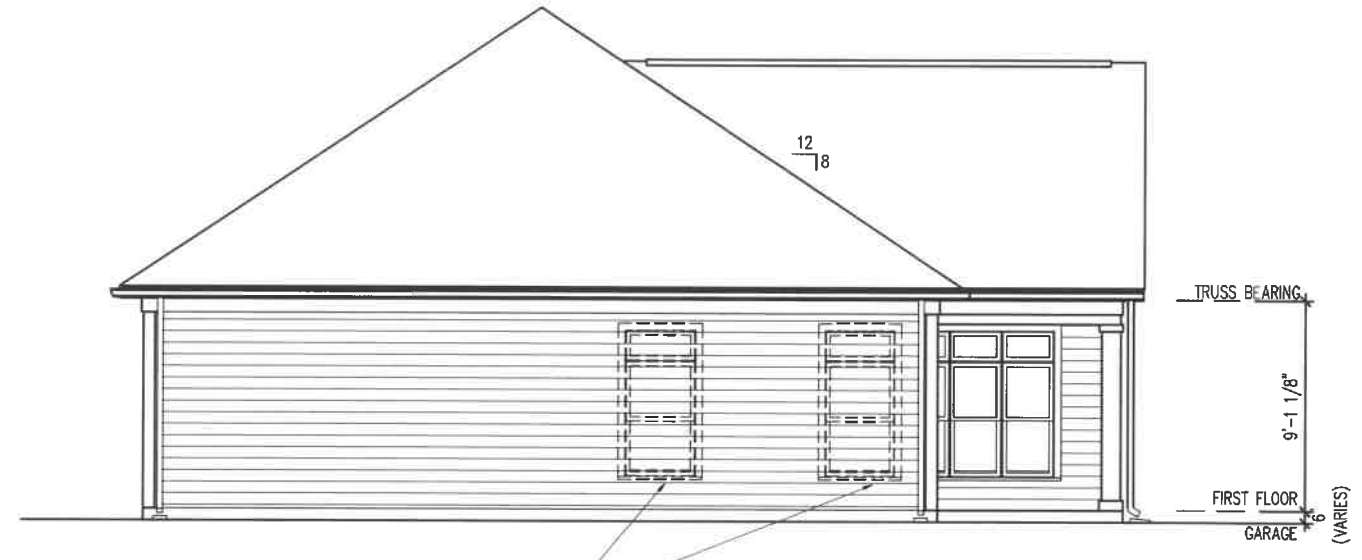

**LEFT ELEVATION**  
 SCALE : 1/4" = 1'-0"



**RIGHT ELEVATION**  
 SCALE : 1/4" = 1'-0"


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 PROMENADE ELEVATIONS**  
 CLARITY CONSTRUCTION  
 WEST DES MOINES

DRAWN: PCR  
 APPROVED: JB  
 ISSUED FOR: REVIEW 3  
 DATE: 08-27-2019  
 PROJECT NO: 19009  
 FIELD BOOK: --  
 CLIENT NO: --


**KINGS LANDING -  
 PROMENADE - BASE**

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# KINGS LANDING - PROMENADE - BONUS ELEVATION

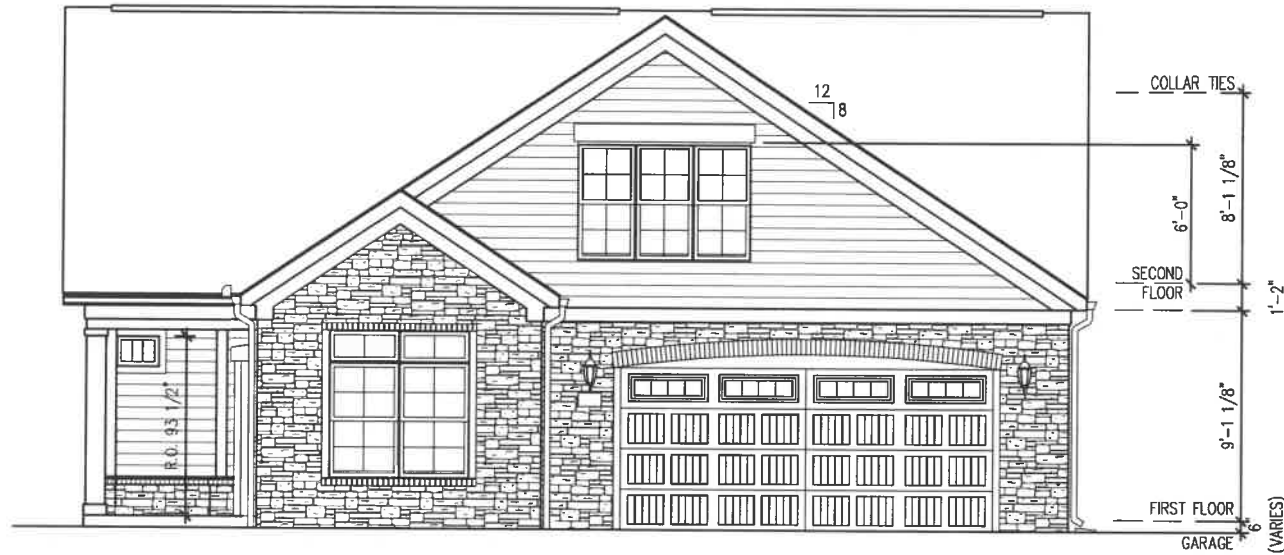

**FRONT ELEVATION**  
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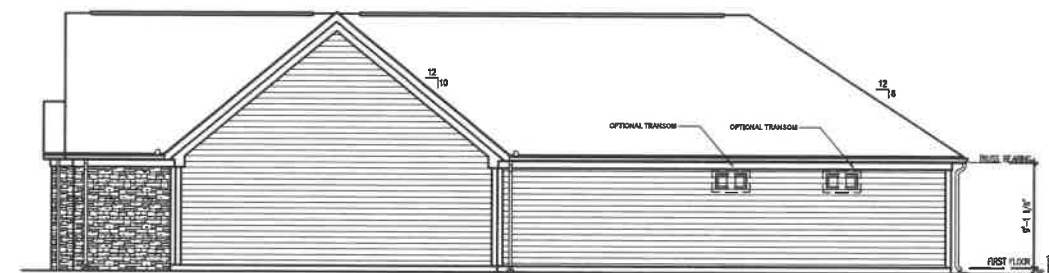


OPTIONAL WINDOWS  
-REQ'D ON LOTS 42-46, 77-79

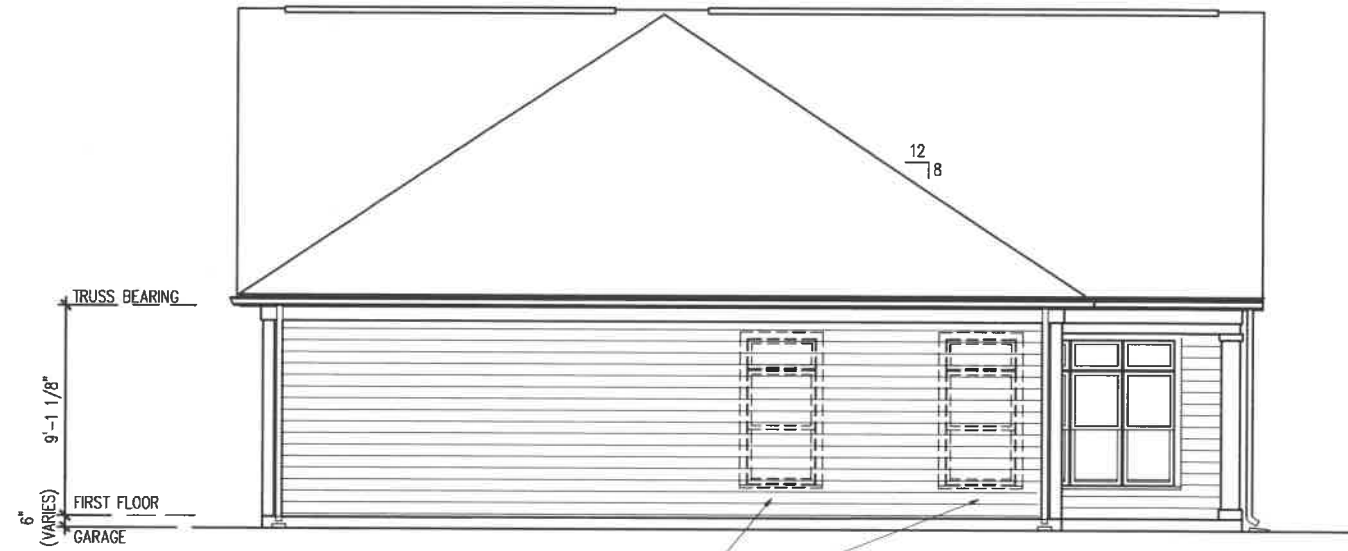**BACK ELEVATION**  
SCALE: 1/8" = 1'-0"



**LEFT ELEVATION**  
SCALE: 1/8" = 1'-0"



**RIGHT ELEVATION**  
SCALE: 1/8" = 1'-0"

KINGS LANDING -  
PROMENADE ELEVATIONS

CLARITY CONSTRUCTION  
WEST DES MOINES


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DATE: 08-27-2010  
PROJECT NO: 19009  
FIELD BOOK: 1  
CLIENT NO: 1

KINGS LANDING -  
PROMENADE -  
BONUS

# KINGS LANDING - PROMENADE - 4 SEASONS ELEVATION



**FRONT ELEVATION**  
 SCALE: 1/8" = 1'-0"

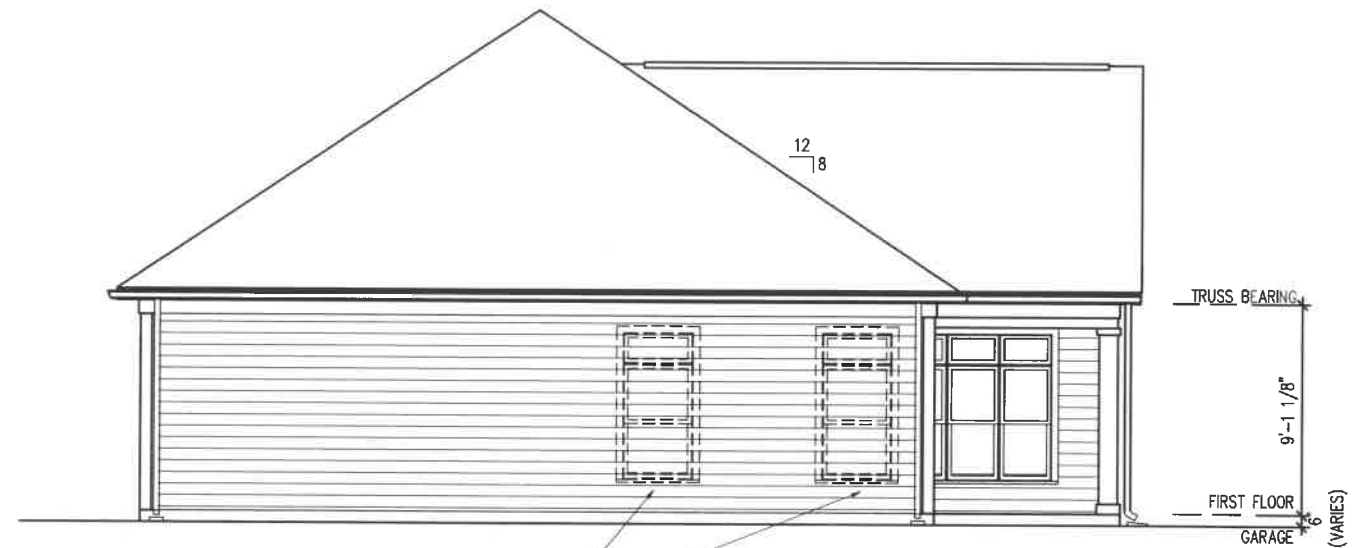


OPTIONAL WINDOWS  
 -REQ'D ON LOTS 42-46, 77-79

**BACK ELEVATION**  
 SCALE: 1/8" = 1'-0"



**LEFT ELEVATION**  
 SCALE: 1/8" = 1'-0"

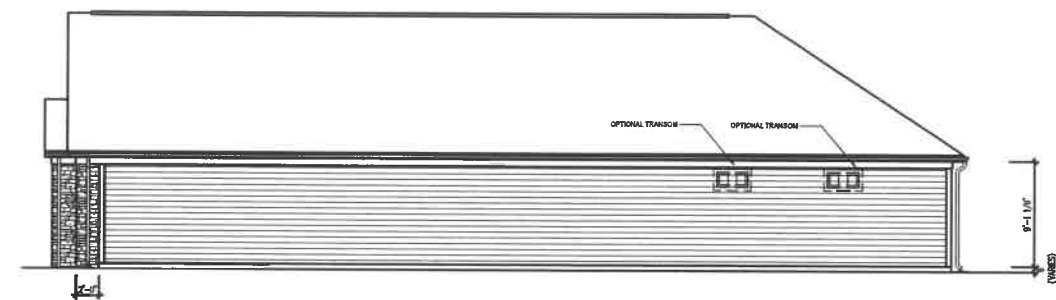

**RIGHT ELEVATION**  
 SCALE: 1/8" = 1'-0"

KINGS LANDING -  
 PROMENADE ELEVATIONS

CLARITY CONSTRUCTION  
 WEST DES MOINES

DRAWN: FOR  
 APPROVED: JB  
 ISSUED FOR: REVIEW 3  
 DATE: 08-27-2019  
 PROJECT NO: 19029  
 FIELD BOOK: -  
 CLIENT NO: -

KINGS LANDING -  
 PROMENADE - 4  
 SEASONS


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# KINGS LANDING - PROMENADE - COV'D PORCH ELEV.



**FRONT ELEVATION**  
SCALE : 1/4" = 1'-0"




**BACK ELEVATION**  
SCALE : 1/4" = 1'-0"

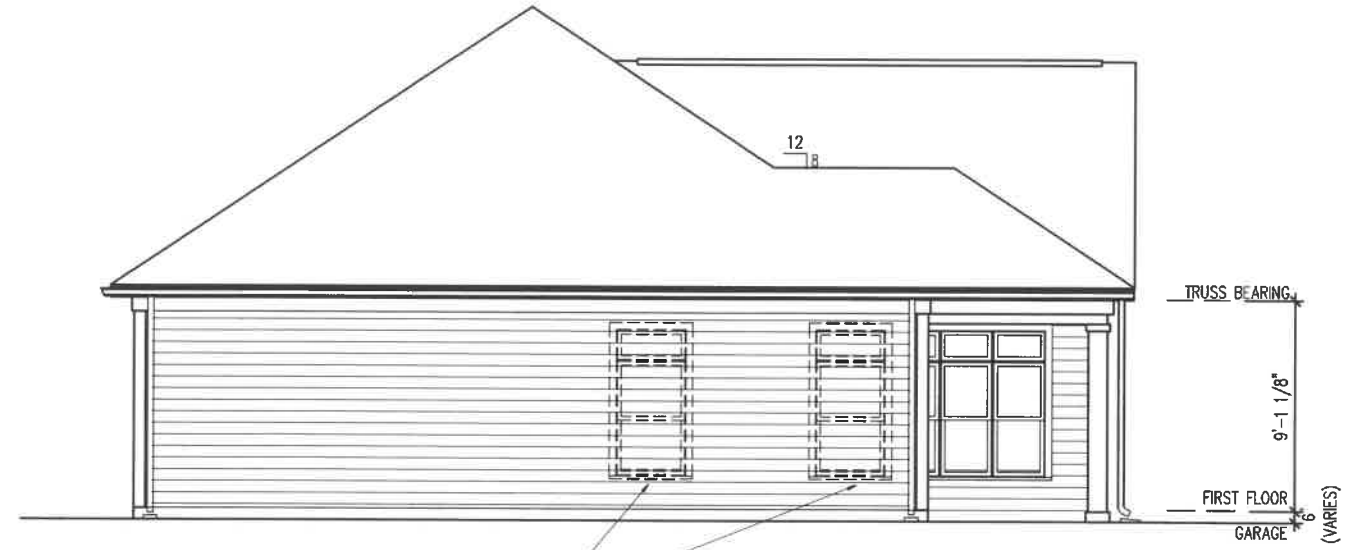OPTIONAL WINDOWS  
-REQ'D ON LOTS 42-46, 77-79



**LEFT ELEVATION**  
SCALE : 1/4" = 1'-0"

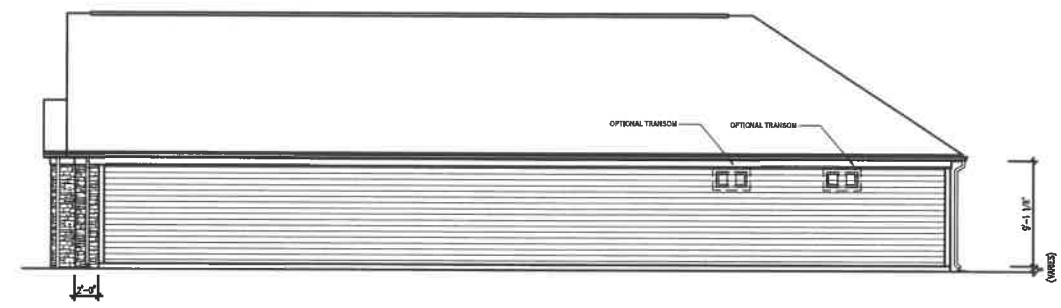

**RIGHT ELEVATION**  
SCALE : 1/4" = 1'-0"

**KINGS LANDING -  
PROMENADE ELEVATIONS**  
CLARITY CONSTRUCTION  
WEST DES MOINES

DRAWN: PCR  
APPROVED: JB  
ISSUED FOR: REVIEW 3  
DATE: 08-27-2019  
PROJECT NO: 19509  
FIELD BOOK: --  
CLIENT NO: --


**KINGS LANDING -  
PROMENADE -  
COV'D PORCH**

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# KINGS LANDING - PROMENADE - SCREEN PORCH ELEV.



**FRONT ELEVATION**  
SCALE: 1/2" = 1'-0"

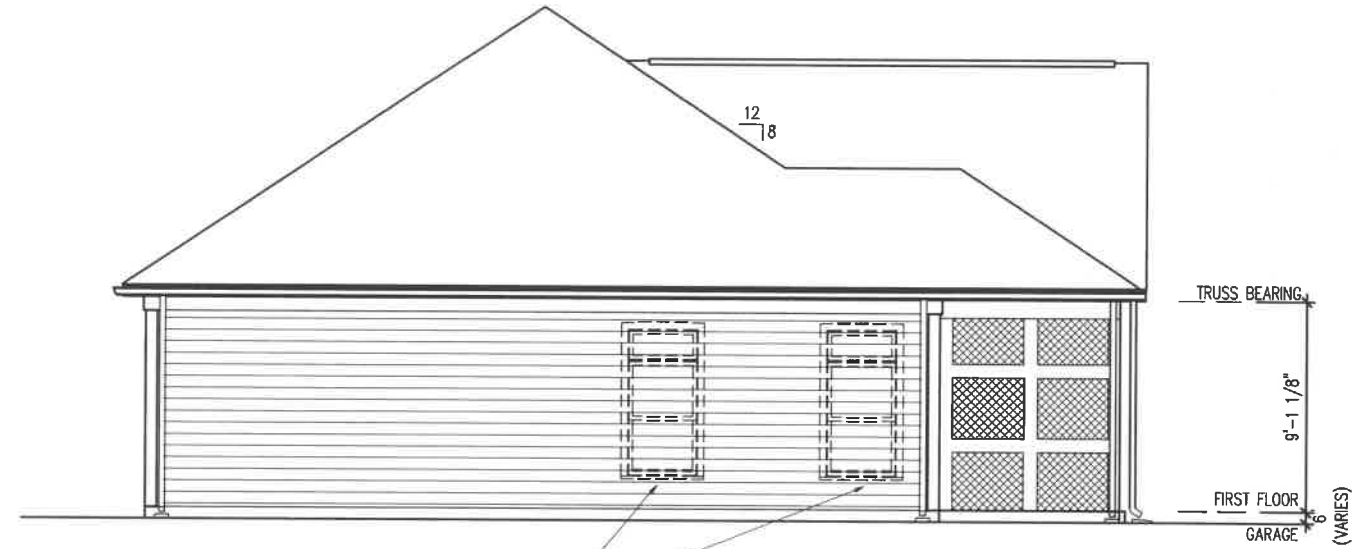


OPTIONAL WINDOWS  
-REQ'D ON LOTS 42-48, 77-79

**BACK ELEVATION**  
SCALE: 1/2" = 1'-0"



**LEFT ELEVATION**  
SCALE: 1/2" = 1'-0"

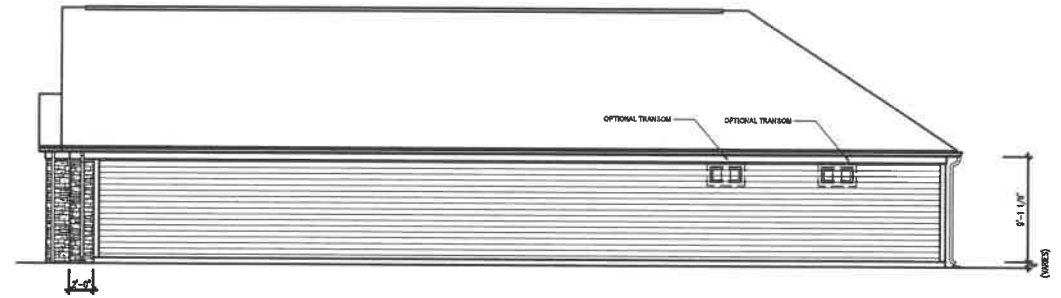

**RIGHT ELEVATION**  
SCALE: 1/2" = 1'-0"

**KINGS LANDING -  
PROMENADE ELEVATIONS**

CLARITY CONSTRUCTION  
WEST DES MOINES

DRAWN: PFC
APPROVED: JB
ISSUED FOR: REVIEW 3
DATE: 08-27-2019
PROJECT NO: 18059
FIELD BOOK: -
CLIENT NO: -

**KINGS LANDING -  
PROMENADE -  
SCREEN PORCH**

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# MONTAGE PLUS<sup>®</sup>



## ORNAMENTAL STEEL FENCE

Montage Plus ornamental steel fence has the versatility to fit many different project applications. With its ability to traverse varying grades, variety of distinct product styles and unmatched coating performance, Montage Plus is the preferred choice for ornamental fence.



### PRIMARY APPLICATIONS

- ▶ **Commercial Developments**
- ▶ **Self Storage**
- ▶ **Apartments (Multi-Family)**
- ▶ **Parks & Recreation**
- ▶ **Schools & Universities**



**FENCE PRODUCTS**

**AMERISTARFENCE.COM | 888-333-3422**

ASSA ABLOY, the global leader in door opening solutions

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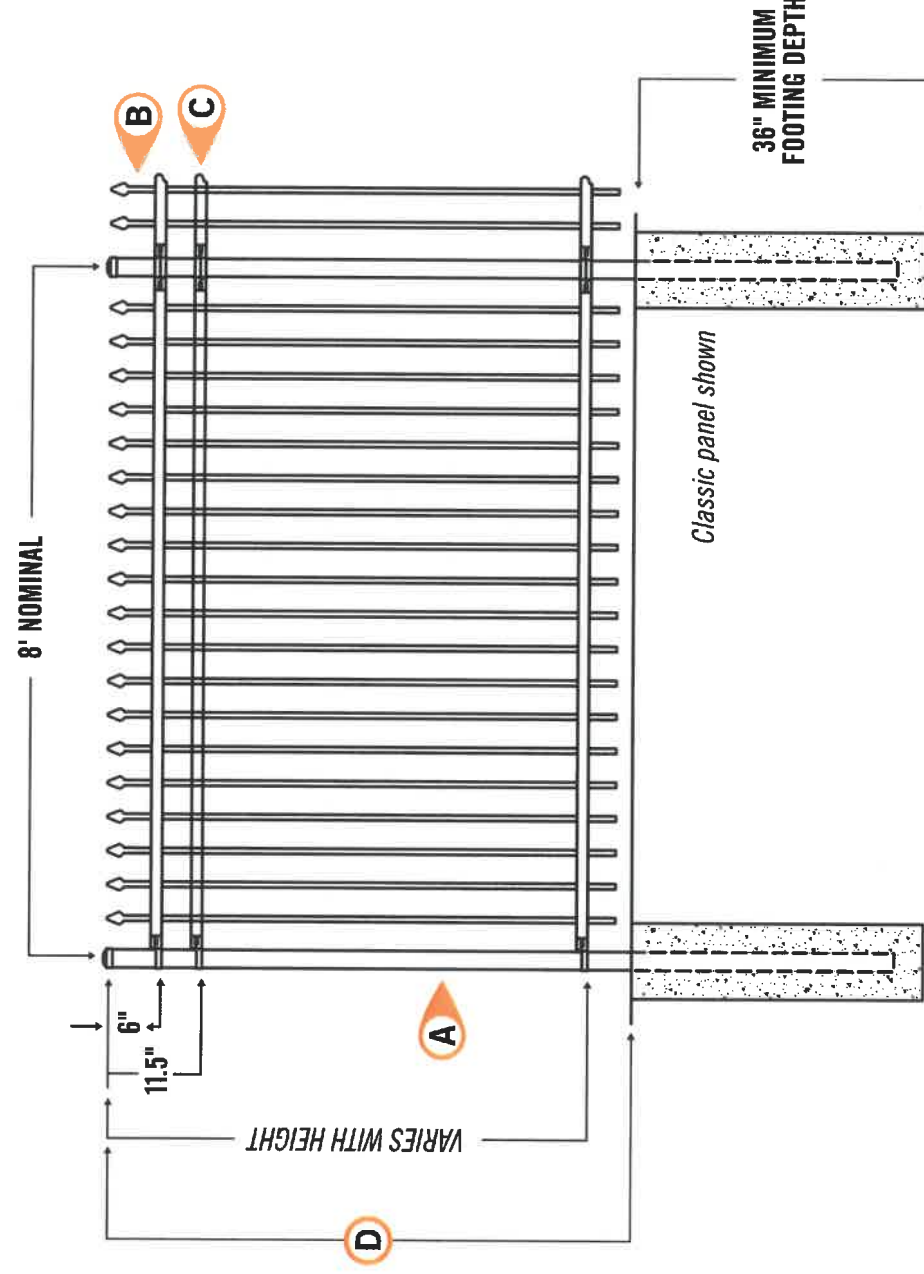
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**MONTAGE PLUS® | 2 & 3-RAIL OPTIONS | 3" & 4" AIR-SPACE OPTIONS**

STANDARD BOTTOM &amp; FLUSH BOTTOM OPTIONS AVAILABLE

PATENT NUMBERS: 7071439, 7621510, 7980534, 8523150, 9840854



- (A)** 2.5"sq x 16ga POSTS
- (B)** 0.75"sq x 18ga PICKETS
- (C)** 1.4375"W x 1.5"h x 14ga RAILS
- (D)** 3', 3.5', 4', 4.5', 5' & 6' PANEL HEIGHTS

*Refer to construction specification & tables within this section for recommended post space by bracket type*

Effective: 01/17/19

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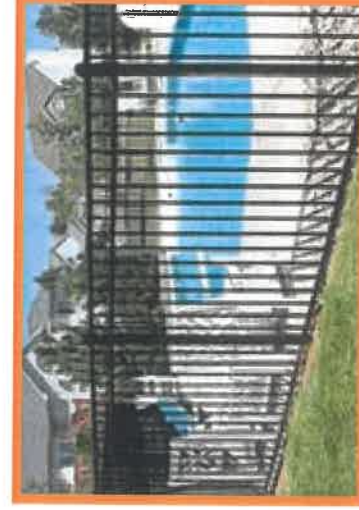


# MONTAGÉ<sup>®</sup>



## RESIDENTIAL ORNAMENTAL STEEL FENCE

Montage ornamental steel fence is unparalleled in strength and quality, adapts to virtually any terrain, withstands vast shifts in climate yet remains untouched by time in stately elegance. This fence offers an array of customizable options to fit your unique sense of style and application.



### PRIMARY APPLICATIONS

- ▶ Single Family Residence
- ▶ Apartments (Multi-Family)
- ▶ Airports
- ▶ Golf Courses



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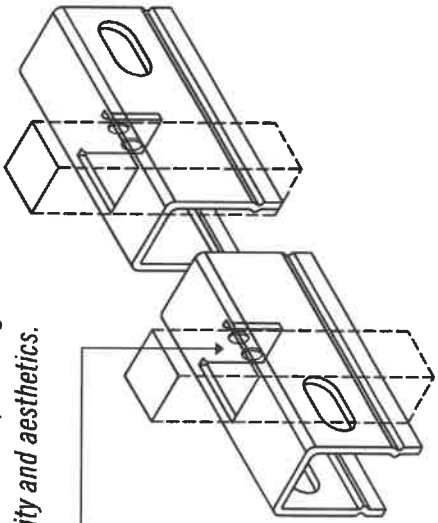


# MONTAGE®


## RESIDENTIAL ORNAMENTAL STEEL FENCE

.625" sq x 18ga PICKETS | .9375" x 1.25" x 14ga RAILS | 2" sq x 16ga POSTS

Each picket is precisely welded at each rail intersection providing all-terrain flexibility and aesthetics.



### STYLE OPTIONS

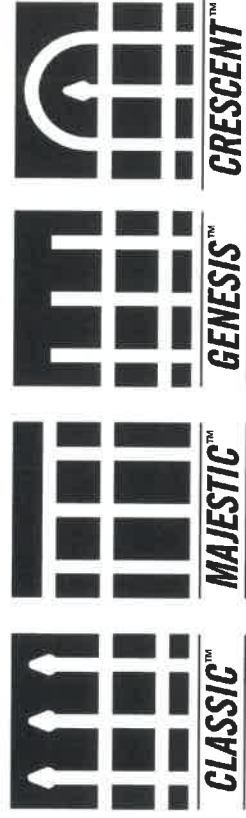

Also available in Pool, Pet & Play (3" air spacing) – styles vary

### PROFUSION WELDED STEEL



All Montage fence panels are fabricated using Ameristar's ProFusion welding process. This technique combines laser and fusion technology to create a virtually invisible structural connection at every picket to rail intersection. Unlike typical aluminum fence systems that are held together with unsightly screws, the ProFusion weld used with Montage promotes a "good neighbor" profile with sleek lines and no exposed picket to rail fasteners. When compared to aluminum fencing, Montage's welded steel construction is unmatched in strength and durability.



### E-COAT™ PROTECTIVE FINISH

Montage galvanized steel framework is subjected to a multi-stage pre-treatment/wash (with zinc phosphate), followed by a duplex cathodic electrocoat system consisting of an epoxy primer, which significantly increases corrosion protection, and an acrylic topcoat, which provides the protection necessary to withstand adverse weathering effects. This process results in years of maintenance-free ownership.



### 20 YEAR LIMITED WARRANTY

The Montage families of fencing products are manufactured from superior quality materials by skilled craftsmen with the highest standards of workmanship in the industry. Ameristar is confident in offering Montage with a 20 year limited warranty.



### DOMESTIC MANUFACTURING

Ameristar is committed to providing products that are manufactured in the USA. We have made significant investments in technology, process improvement, and employee training in an effort to secure American jobs and combat inferior import products.



FENCE PRODUCTS


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**MONTAGE® | 2 & 3-RAIL OPTIONS | 3" & 4" AIR-SPACE OPTIONS**

STANDARD BOTTOM &amp; FLUSH BOTTOM OPTIONS AVAILABLE



- A** 2"sq x 16ga POSTS
- B** 0.590"sq x 18ga PICKETS
- C** 0.9375"w x 1.25"h x 14ga RAILS
- D** 3', 3.5', 4', 4.5', 5' & 6' PANEL HEIGHTS

*Refer to construction specification & tables within this section for recommended post space by bracket type*

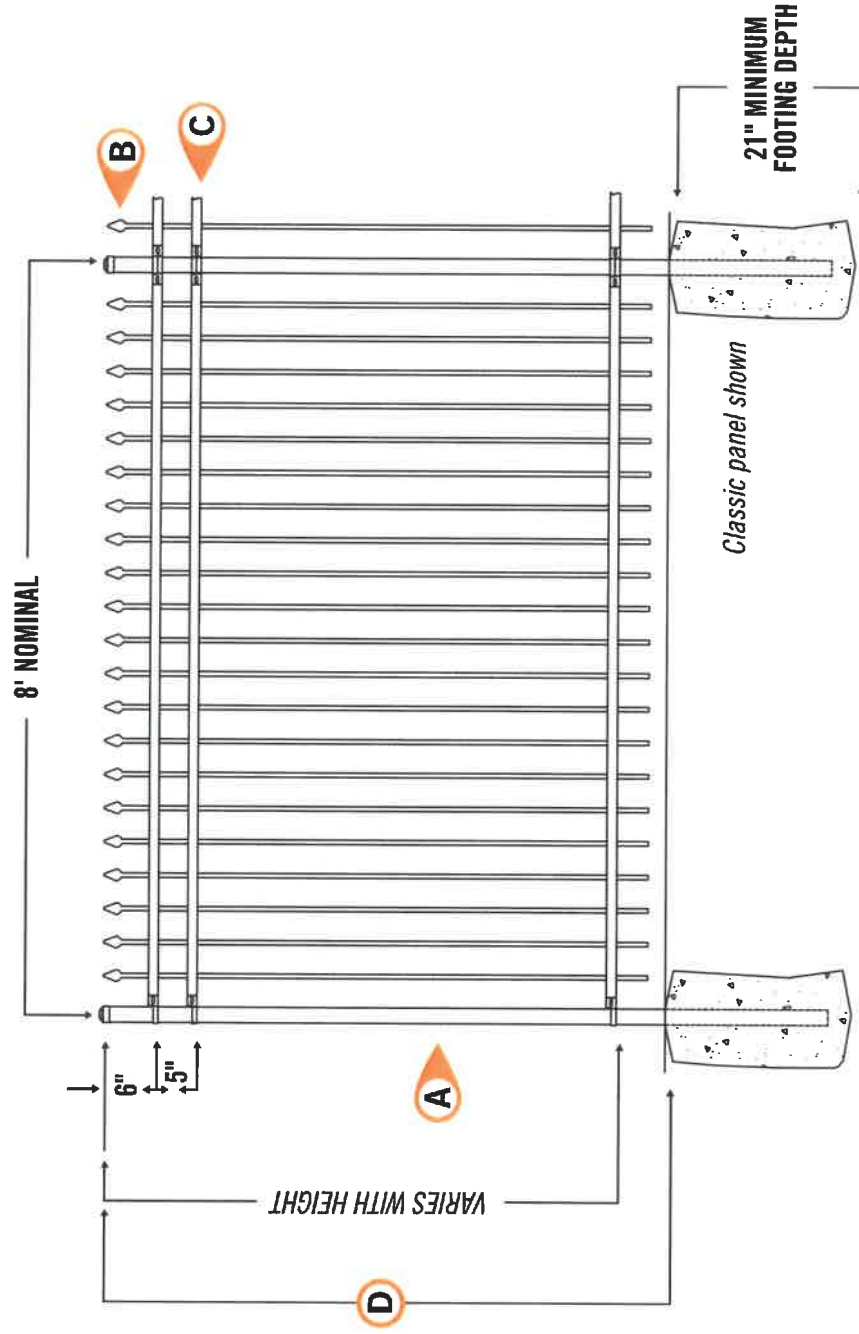Effective: 01/06/15

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