# CITY OF WEST DES MOINES PLAN AND ZONING COMMISSION COMMUNICATION

Meeting Date: April 13, 2020

<u>Item</u>: Water Tower Lighting, 505 S. 50<sup>th</sup> Street – Approve Minor Modification

to Site Plan to allow elevated directional lighting- West Des Moines

Water Works - MML1-004686-2020

Requested Action: Approval of Minor Modification Level 1 application to Site Plan

Case Advisor: Kara Tragesser, AICP

<u>Applicant's Request</u>: The applicant, West Des Moines Water Works, with permission from the property owner, City of West Des Moines, requests approval of a minor modification to a site plan to illuminate the logos and name of the city on the bowl of the water tower. Four 30-foot-tall light poles will be installed with LED lights directed at the logos and name of the city on the bowl of the water tower.

<u>City Council Subcommittee</u>: This item was presented to the Development & Planning City Council Subcommittee at their February 3, 2020 meeting. Water Works General Manager, Christina Murphy explained the project. Deputy City Manager Letzring indicated that the project is proposed to be a joint project between the City and the West Des Moines Water Works. The Subcommittee was supportive of the project but did express concern with the lighting reflecting into the surrounding properties. In response to their concerns, a demonstration of the lighting was arranged.

Staff Review and Comment: There are no outstanding issues. Staff notes the following:

<u>Lighting Test</u>: On March 25, 2020, Water Works arranged a test simulation of the proposed lighting via mobile Musco lighting trailers. Although not required, Water Works mailed notice of the test to all property owners within 370' of the property, including notice to the developers of the senior living project immediately to the west and posted notice to the City's website. This staff person was present on the site to see the lighting. A copy of some of the pictures taken by Water Works staff are attached to the staff report as Attachment D. The notice requested individuals contact Water Works with any concerns after seeing the lighting test: no comments have been received as of the writing of this staff report.

<u>Comprehensive Plan Consistency</u>: The project has been reviewed for consistency with the Comprehensive Plan. Based upon that review, a finding has been made that the proposed project is consistent with the Comprehensive Plan in that the project is consistent with all of the goals and policies of the Comprehensive Plan and the land use map of the Comprehensive Plan.

**Findings**: This proposed project was distributed to various city departments for review and comment. Based upon that review, the following findings have been made on the proposed project:

- The proposed development and use is consistent with the West Des Moines Comprehensive Plan
  in that the project has been reviewed for consistency with the Comprehensive Plan. Based upon
  that review, a finding has been made that the proposed project is consistent with the
  Comprehensive Plan in that the project is consistent with all of the goals and policies of the
  Comprehensive Plan.
- 2. The proposed development and use does assure compatibility of property uses within the zone and general area in that this project was reviewed by various City Departments for compliance with the Zoning Ordinance.
- 3. All applicable standards and conditions have been imposed which protects the public health, safety and welfare in that this project was reviewed by various City Departments and public agencies for compliance with the various state and local regulations. Based upon that review a finding is made

that the project has been adequately conditioned to protect the health, welfare and safety of the community.

- 4. There is adequate on-site and off-site public infrastructure to support the proposed development in that this project was reviewed by various public agencies and City Departments and public utilities to ensure that either the petitioner will construct or the project has been conditioned to construct adequate public infrastructure to serve the development.
- 5. The proposed development and use has met the requirements contained in the City Code in that this project was reviewed by various City Departments and the project has complied with or has been conditioned to comply with all City Code requirements.
- The proposed development and use is in keeping with the scale and nature of the surrounding neighborhood in that the proposed project is consistent with the zoning designation and Comprehensive Plan which designates this site as suitable for development such as that proposed by this project.

<u>Staff Recommendation and Conditions of Approval</u>: Based upon the preceding review and a finding of consistency with the goals and policies of the Comprehensive Plan staff recommends the Plan and Zoning Commission adopt a resolution recommending the City Council approve the Minor Modification Level 1 to install elevated lighting for the S. 50<sup>th</sup> Street water tower, subject to the applicant meeting all City Code requirements.

**Property Owner:** City of West Des Moines

4200 Mills Civic Parkway West Des Moines IA 50265

Applicant(s): William Mabuce

West Des Moines Water Works

1505 Railroad Avenue West Des Moines IA 50265

Applicant's Representatives: same as Applicant

#### **ATTACHMENTS:**

Attachment A - Plan and Zoning Commission Resolution

Exhibit A - Conditions of Approval

Attachment B - Location Map Attachment C - Site Plan

Attachment D - Lighting Information
Attachment E - Demonstration Pictures

#### **RESOLUTION NO. PZC-20-014**

A RESOLUTION OF THE PLAN AND ZONING COMMISSION OF THE CITY OF WEST DES MOINES, IOWA, RECOMMENDING TO THE CITY COUNCIL THAT IT APPROVE THE MINOR MODIFICATION LEVEL 1 TO INSTALL ELEVATED LIGHTING FOR THE WATER TOWER AT 505 S. 50<sup>TH</sup> STREET

WHEREAS, pursuant to the provisions of Title 9, Chapter 1 et seq, of the West Des Moines Municipal Code, the applicant, West Des Moines Water Works, in cooperation with the property owner, City of West Des Moines, has requested approval of a Minor Modification Level 1 to allow the installation of elevated lighting to illuminate the logo and lettering on the bowl of the water tower: and

WHEREAS, studies and investigations were made and staff reports and recommendations were submitted which is made a part of this record and herein incorporated by reference; and

**WHEREAS,** on April 13, 2020, this Commission held a duly-noticed meeting to consider the Minor Modification Level 1 application.

**NOW, THEREFORE,** THE PLAN AND ZONING COMMISSION OF THE CITY OF WEST DES MOINES DOES RESOLVE AS FOLLOWS:


<u>SECTION 1</u>. The findings, for approval, in the staff report, dated April 13, 2020, or as amended orally at the Plan and Zoning Commission meeting of April 13, 2020, are adopted.

SECTION 2. The Minor Modification Level 1 application to allow elevated lighting for the S. 50<sup>th</sup> Street water tower is recommended to the City Council for approval, subject to compliance with all the conditions in the staff report, dated April 13, 2020, including conditions added at the meeting, and attached hereto as Exhibit "A". Violation of any such conditions shall be grounds for revocation of the permit, as well as any other remedy which is available to the City.

PASSED AND ADOPTED on April 13, 2020.	
ATTEST:	Erica Andersen, Chair Plan and Zoning Commission
Recording Secretary	
I HEREBY CERTIFY that the foregoing reso Commission of the City of West Des Moines, Iowa, a following vote:	plution was duly adopted by the Plan and Zoning at a regular meeting held on April 13, 2020, by the
AYES: NAYS: ABSTENTIONS: ABSENT:	
ATTEST:	
Recording Secretary	

**Exhibit A**Conditions of Approval

No conditions of approval.

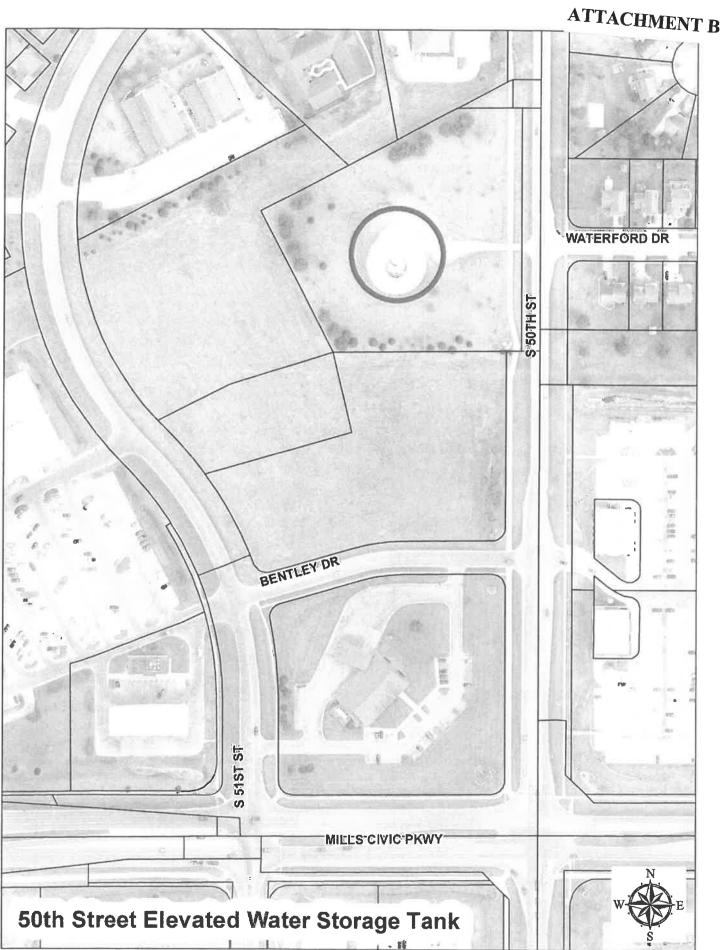

# WEST DES MOINES 50TH STREET WATER TOWER LIGHTING

505 S. 50TH STREET WEST DES MOINES, IOWA, 50265



300 4th Street West Des Moines, IA 50265 515.724.7938 info@kclengineering.com

# Consulting Engineering Mechanical Electrical Plumbing

PROJECT LOCATION







I hereby certify that this engineering document was prepared by me or under my direct personal supervision and that I am a duly licensed Professional Engineer under the laws of the State of Iowa.

(signature)

3/27/2020 (date)

ERIC HEYNEN, P.E.

License Number: P24706

My license renewal date is December 31, 2021

Pages or sheets covered by this seal: F. deets

<u>Design Contact:</u> James Deeds, PE KCL Engineering

Owner Contact:

515-222-3510

William Mabuce, PE

515-371-9970 ideeds@kclengeering.com

william.mabuce@wdmww.com

Property Owner:

West Des Moines Water Works 1505 Railroad Avenue

West Des Moines, Iowa 50265

Applicant:

West Des Moines Water Works 1505 Railroad Avenue

West Des Moines, Iowa 50265

ELECTRICAL SHEET LIST

EO.O GENERAL NOTES AND SYMBOLS

E1.0 ELECTRICAL SITE PLAN

E2.0 ELECTRICAL INTERIOR PLAN

Legal Description of Property:

A tract of land, containing 3.33 acres, in the Northeast Quarter and the Southeast Quarter of Section 19, Township 78 North, Range 25 West of the Fifth Principal Meridian, in the City of West Des Moines, Polk County, lowa, more particularly described as follows:

Commencing at the East \$\frac{1}{4}\$ Corner of said Section 19, with the eat line of the Southeast \$\frac{1}{4}\$ of said Section 18 having an assumed true bearing of \$\text{S}\$ 0'00'00" \$\text{E}\$, with all subsequaent bearings referenced therefrom; thence \$\text{S}\$ 0'00'00" \$\text{E}\$, a distance of four hundred thirty—nine and sixty—nine hundredths (439.69) feet; thence \$\text{N}\$ 90'00'00" \$\text{W}\$, a distance of thirty—three (33.00) feet to a point on the west right—of—way line of 50th Street in the said City of West Des Moines and the point of the beginning; thence \$\text{N}\$ 90'00'00" \$\text{W}\$, a distance of three hundred forty and thirty hundredths (340.30) feet; thence \$\text{N}\$ 27'25'15" \$\text{W}\$, a distance of two hundred eighty—seven and eight hundredths (278.08) feet to the southerly line of a power line easement, one hundred (100) feet in width: thence \$\text{N}\$ 62'34'45" \$\text{E}\$, along said southerly line of said power line easement, a distance of five hundred thirty—two and thirty—nine hundredths (532.39) feet to the west right—of—way line of said 50th Street; thence \$\text{S0'01'51"}\$ \$\text{W}\$, along the said west right—of—way line of 50th Street, a distance of four hundredths (60.31) feet; thence \$\text{S0'00'00"}\$ \$\text{E}\$, along said west right—of—way line of 50th Street, a distance of four hundred thirty—nine and sixty—none hundredths (439.69) feet to the point of beginning.

## **ELECTRICAL SYMBOLS**

MP1	POLE MOUNTED LIGHT FIXTURE
	LIGHTING AND POWER PANEL - SURFACE MOUNTED
	CONDUIT CONCEALED IN FLOOR CONSTRUCTION OR UNDERGROUND
	EXPOSED CONDUIT
	METER
(3)——	NOTE REFERENCE

## **ELECTRICAL ABBREVIATIONS**

Al	FG	ABOVE FINISHED GRADE	PC	PHOTOCELL
A	С	AMPS INTERRUPTING CAPACITY	R	EXISTING ITEM TO BE REMOVED
ε		EXISTING ITEM TO REMAIN	+24"	INDICATES MOUNTING HEIGHT
E	3	ELECTRICAL CONTRACTOR		CENTER LINE OF DEVICE TO FINISHED FLOOR



#### **GENERAL NOTE:**

UNDERGROUND FACILITIES, STRUCTURES, AND UTILITIES HAVE BEEN SHOWN BASED UPON INFORMATION OBTAINED FROM FIELD LOCATIONS BY UTILITY COMPANIES, AVAILABLE SURVEYS AND RECORDS. THEIR LOCATIONS MUST BE CONSIDERED APPROXIMATE ONLY. IT IS ALSO POSSIBLE THAT THERE MAY BE OTHER UNDERGROUND FACILITIES, STRUCTURES, AND UTILITIES IN EXISTENCE THAT ARE NOT SHOWN. IT IS THE RESPONSIBILITY OF EACH INDIVIDUAL PARTY REFERENCING THIS PLAN TO DETERMINE THE EXACT LOCATION AND TYPE OF UNDERGROUND FACILITIES ON THE SITE. HAND EXCAVATE AT CRITICAL POINTS AS NECESSARY TO VERIFY LOCATIONS, SIZES, ELEVATIONS, FLOW LINES, ETC. IF A PROBLEM OR INTERFERENCE EXISTS, NOTIFY ARCHITECT/ENGINEER BEFORE PROCEEDING.

#### **DEMOLITION AND RENOVATION NOTES - ELECTRICAL**

- THE ELECTRICAL DEMOLITION DRAWING SHOWING EXISTING CONDITIONS HAS BEEN PREPARED BASED ON FIELD OBSERVATION. ADDITIONAL COMPONENTS MAY EXIST
  WHICH DO NOT SHOW., AND SUCH ITEMS SHALL BE DEALT WITH IN A MANNER SIMILAR TO THOSE ITEMS WHICH DO SHOW.
- ALL EXISTING SYSTEMS (EXISTING AND/OR NEW) THAT ARE NOT AFFECTED BY THE SCOPE OF THE PROJECT ARE TO BE KEPT OPERATIONAL THROUGH THE DURATION OF THE
  PROJECT. COORDINATE ANY REQUIRED OUTAGES WITH THE OWNER IN ADVANCE OF SHUT DOWN.
- DO NOT CUT EXISTING TELECOMMUNICATION WIRING, CABLES OR CONDUIT AS EXISTING SYSTEMS SHALL REMAIN OPERATIONAL DURING ALL PHASES OF CONSTRUCTION.
  CONTRACTOR WHO CUTS IN-SERVICE CABLES SHALL BE RESPONSIBLE FOR ANY AND ALL DOWNTIME AND COSTS TO REPAIR.
- EQUIPMENT AND DEVICES SHOWN AS EXISTING OR AS REMOVE/RELOCATE SHALL BE PROTECTED AND HANDLED WITH APPROPRIATE CARE SO AS TO MAINTAIN FULL FUNCTIONAL AND AESTHETIC INTEGRITY OF THE DEVICE.

#### **SITE NOTES - ELECTRICAL**


- UTILITIES SHOWN ON ELECTRICAL SITE PLAN ARE SCHEMATIC ONLY. VERIFY ALL SITE CONDITIONS AND DIMENSIONS ON SITE PRIOR TO COMPLETING BID AND ORDERING OF
  EQUIPMENT.
- 2. CONTRACTOR SHALL REPAIR ALL AFFECTED SURFACES AND RESTORE TO EXISTING CONDITIONS AT COMPLETION OF PROJECT.
- WARNING CALL 48 HOURS BEFORE YOU DIG: IOWA LAW REQUIRES ANYONE DOING ANY EXCAVATION, FENCING, PLANTING OR DRILLING TO CALL 48 HOURS IN ADVANCE.
   HAND DIG WITHIN 18 INCHES OF ANY LOCATE MARK OR FLAG, IOWA ONE-CALL 1-800-292-8989.

#### **CODES NOTES - ELECTRICAL**

- THE ELECTRICAL INSTALLATION SHALL BE IN ACCORDANCE WITH ALL LOCAL, STATE, AND NATIONAL CODES.
- THE CURRENT ADOPTED EDITION OF THE ELECTRICAL CODE SHALL BE THE STANDARD FOR THE ELECTRICAL INSTALLATION. VERIFY WITH LOCAL OFFICIALS WHEN PERMITS ARE
  OBTAINED. NOTIFY DESIGN TEAM OF ANY DESCREPANCIES BETWEEN THE PROJECT MANUAL OR DRAWINGS AND THE GOVERNING CODE.

#### **INSTALLATION NOTES - ELECTRICAL**

- CONTRACTORS SHALL FAMILIARIZE THEMSELVES WITH EXISTING CONDITIONS PRIOR TO BID.
- 2. RACEWAYS AND BOXES ARE SHOWN DIAGRAMMATICALLY ONLY AND INDICATE THE GENERAL AND APPROXIMATE LOCATION, THE LAYOUT DOES NOT NECESSARILY SHOW THE TOTAL NUMBER OF RACEWAYS OR BOXES FOR THE CIRCUITS REQUIRED, NOR ARE THE LOCATIONS OF INDICATED RUNS INTENDED TO SHOW THE ACTUAL ROUTING OF THE RACEWAYS.
- PROVIDE A DEDICATED GREEN INSULATED GROUND CONDUCTORS TO ALL DEVICES. THE CONDUIT SYSTEM SHALL NOT BE USED AS THE ONLY EQUIPMENT GROUNDING METHOD.
- BALANCE THE LOAD ON PANELS AS EVENLY AS POSSIBLE DURING INSTALLATION. CIRCUIT NUMBERING SHOWN ON PLANS MAY BE ADJUSTED.
- 5. PROVIDE FINAL TYPED PERMANENT PANEL DIRECTORY AT PROJECT COMPLETION.

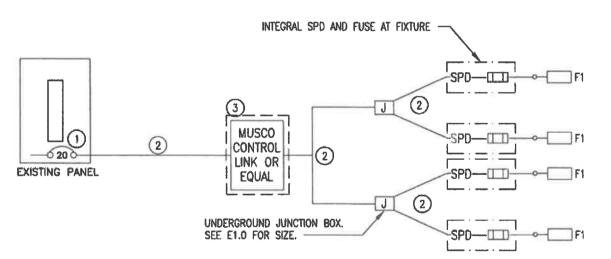

- INSTALL 20A 2P SPARE BREAKER IN SPACES 18,20 FOR CIRCUIT TO LIGHTING. MOVE OVERHEAD DOOR BREAKER AND WIRING TO SPACE 16. EXISTING PANEL IS SQUARE D NO PANEL WITH 10KAIC RATING.
- 2 ALL WIRING TO BE (2) #10 AWG +(1) #10 GND IN 1" CONDUIT UNLESS OTHERWISE NOTED.
- 3 ALTERNATE #1 PROVIDE PRICING TO INCLUDE MUSCO CONTROL LINK OR EQUAL FOR DIMMING CAPABILITIES. BASE BID TO BE ASTRONOMICAL TIME CLOCK. TIME CLOCK TO BE INTERMATIC ET2805C OR APPROVED EQUAL.

1	W	IR	IN	G	DI	A	G	R/	١M
1 1-						_	_	_	

NOT TO SCALE

KCL

KCL ENGINEERING 300 4th Street West Des Moines, Iowa 50265

**公民学皇** NOT FOR CONSTRUCTION

Revisions Date

Project Number: 19083

Date: 03/27/2020

WEST DES MOINES 50TH STREET WATER


TOWER LIGHTING 505 50TH STREET WEST DES MOINES, 10WA

Sheet Name:

GENERAL NOTES & SYMBOLS

Sheet:

E0.0

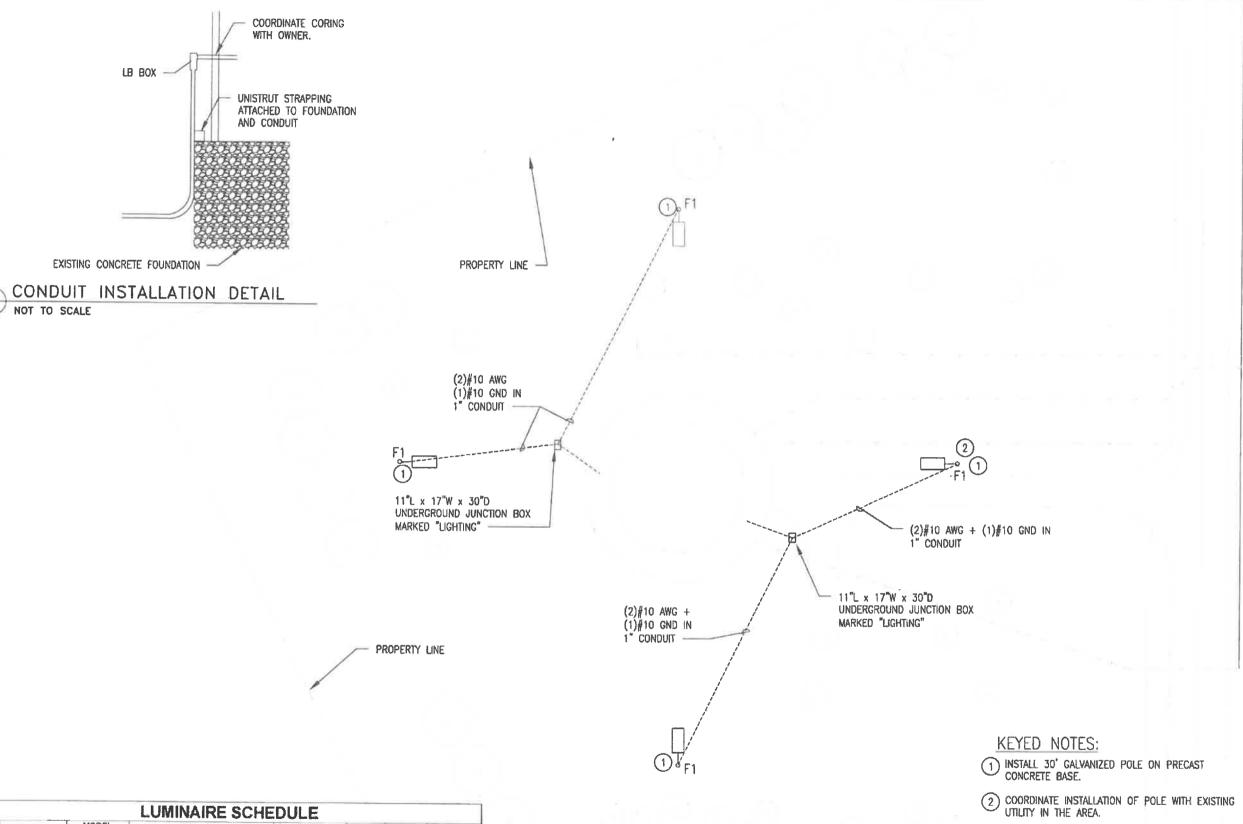

MODEL COLOR VOLTAGE APPROVED TYPE MANUFACTURER DESCRIPTION MOUNTING LED FLOOD LIGHT, DIMMABLE, FUSED. INSTALLED ON 30' GALVANZED POLE 40,000 LUMENS TO CRI, 4500K, 400W MAXIKUM, RATED FOR UPLIGHTING AND WET LOCATON INSTALLATION F1 AS APPROVED MUSCO SOLEDIUMNARE PROVIDED BY BY ENGINEER

GENERAL NOTES:

ALL FORTURES SHALL BE UIL OR SIMILARLY LISTED

ALL FORTURES SHALL BE UIL OR SIMILARLY LISTED

CONTRACTOR IS RESPONSIBLE FOR ALL MISCELLANEOUS HARDWARE NECESSARY TO INSTALL AND SUPPORT THE LUMINAIRES

ALL FORTURES SHALL HAVE A "TEN (NO) YEAR MANUFACTURERS WARRANTY UNLESS OTHERWISE NOTED

SITE LIGHTING ELECTRICAL PLAN SCALE: 1" = 50'-0"

PROPERTY LINE

West Des Moines, Iowa 50265 KCL ENGINEERING 300 4th Street

NOT FOR CONSTRUCTION

Revisions

Project Number:

19083 Date: 03/27/2020

WEST DES MOINES 50TH STREET WATER TOWER LIGHTING 505 50TH STREET WEST DES MOINES, 10WA

Sheet Name:

**ELECTRICAL** SITE PLAN

Sheet:

E1.0

West Des Moines, lowa 50265 KCL ENGINEERING 300 4th Street

NOT FOR CONSTRUCTION

Revisions

Project Number: 19083

Date: 03/27/2020

WEST DES MOINES 50TH STREET WATER TOWER LIGHTING 505 50TH STREET WEST DES MOINES, IOWA


Sheet Name:

**ELECTRICAL** INTERIOR PLAN

Sheet:

E2.0

**EXISTING** PANELS **EXISTING** PANELBOARD 2 **NEW CONTROL LINK** 

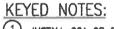



- INSTALL 20A 2P BREAKER IN PANELBOARD. INSTALL #10 CONDUCTORS AND #10 GROUND IN 1" CONDUIT TO TIMECLOCK.
- COORDINATE CORING OF WATERTOWER WITH OWNER. CORING TO BE COMPLETED BY OWNER. STRAP CONDUIT TO TOWER AND FOUNDATION OUTSIDE TO RUN CONDUIT UNDERGROUND.
- INSTALL CONDUIT ON WALL ON EXISTING STRAPPING ON INTERIOR OF TOWER.
- ALTERNATE #1 INSTALL MUSCO CONTROL-LINK SYSTEM TO PROVIDE TIME OF DAY SCHEDULING, DIMMING, AND FIXTURE MONITORING. ALL OTHER EQUAL SYSTEMS WILL NEED TO MEET THESE REQUIREMENTS AND APPROVED BY THE ENGINEER.
  BASE BID TO BE ASTRONOMICAL TIME CLOCK. TIME CLOCK TO BE INTERNATIC ET2805C OR APPROVED


NORTH

ENLARGED TOWER ELECTRICAL FLOOR PLAN SCALE: 1" = 10'-0"

#### Datasheet: 80 LED Luminaire

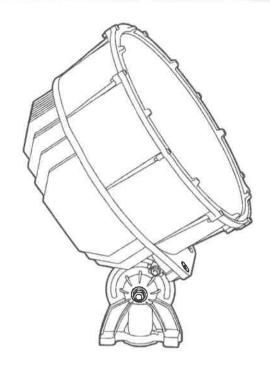

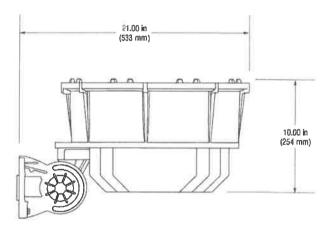

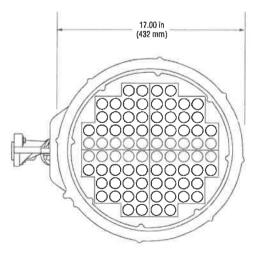

#### **Luminaire Data**

#### **Photometric Characteristics**

Projected lumen maintenance per IES TM-21-11

L90 (13.5k)	>81,000 h
L80 (13.5k)	>81,000 h
L70 (13.5k)	>81,000 h
CIE correlated color temperature	4500 K
Color rendering index (CRI)	75 typ, 70 min
Lumens <sup>1</sup>	42,920

#### **Material and Finish**

Aluminum, anodized, Castguard  $^{\text{\tiny{TM}}}$  coated, and powder coated.

Footnotes:

1) Incorporates appropriate dirt depreciation factor for life of luminaire.



#### Datasheet: 80 LED Luminaire

**Driver Data** Typical Wiring

#### **Electrical Data**

Rated wattage <sup>1</sup>		Surge <sup>†</sup>
Per driver	400 W	protection Luminaire
Per luminaire	400 W	
Number of luminaires per driver	1	Disconnect Fuse Privar +
Starting (inrush) current	4.70 A <sup>2</sup> s	Driver
Fuse rating	15 A	12*
Ingress protection,	IP54	Fuse Fuse
electrical components enclosure		* If L2 (com) is neutral then not switched or fused.
Efficiency	94%	† Not present if indoor installation

† Not present if indoor installation.

120 Vac 208 Vac 220 Vac 230 Vac 240 Vac 50/60 Hz 60 Hz 50/60 Hz 50/60 Hz 60 Hz Max operating current 4.13 A 2.38 A 2.25 A 2.16A 2.07 A 1.79 A per luminaire

#### Footnotes:

- 1) Rated wattage is the power consumption, including driver efficiency losses, at stabilized operation in 25°C ambient temperature environment.
- 2) Operating current includes allowance for 0.90 minimum power factor, operating temperature, and LED light source manufacturing tolerances.

#### Notes

1. Use thermal magnetic HID-rated or D-curve circuit breakers.





# ATTACHMENT E

