# CITY OF WEST DES MOINES STAFF REPORT COMMUNICATION

Meeting Date: August 22, 2022

ITEM: Polo Club, 6201 EP True Parkway – Approve Major Modification to Site Plan to allow construction of new apartment building – Polo Club, LLC – MaM-005555-2022

Resolution: Approval of Major Modification to Site Plan

<u>Background</u>: Doug Mandernach with Civil Design Advantage, on behalf of the applicant, and property owner, Polo Club, LLC, requests approval of the Major Modification to Site Plan for the approximately 16.43-acre property located at 6201 EP True Parkway. The applicant proposes to remove existing garages and build a new 39,658 square foot, 3-story apartment building with 26 dwelling units and associated site improvements.

# **Staff Review & Comment:**

- <u>Financial Impact</u>: No City funding of the project. Staff time for processing of development application and inspections during construction.
- <u>History</u>: The Polo Club Apartments Site Plan was approved in 1997. The original site plan included 9 buildings containing a total of 276 dwelling units with 16 detached garage buildings and a clubhouse.
- Key Development Aspects:
  - 1. Building Design: The design on the new apartment building will be the same as the adjacent buildings.
  - Parking Requirements: A total of 615 parking spaces are required for the entire site with the new building addition. The existing parking provided on site is 642 spaces. With the removal of the garage buildings and the addition of the apartment building, the site will provide a total of 631 spaces.
- Conditions of Approval:
  - 1. Parkland Dedication: The applicant has been in discussions with Parks & Recreation regarding the improvements that will be constructed to fulfill their obligations. The applicant and the city are in agreement with the improvements to be implemented and the Parkland Dedication Agreement is being drafted. Staff is recommending a condition of approval requiring execution of the agreement prior to issuance of a building permit and completion of construction prior to issuance of occupancy permits.
  - 2. Addressing: The Polo Club complex utilizes a site address of 6201 EP True Parkway. Individual buildings within the complex are numbered. The building number, in combination with the floor and apartment number is used to make up the unit address for each dwelling (e.g, apartment 12 on the 3<sup>rd</sup> floor of building 9 would use a mail address of 6201 EP True Pkwy, #9312). The existing buildings are numbered sequentially as one circles the development. This building will be located east of building 1000 and between buildings 2000 and 3000. For wayfinding of tenants, visitors and more importantly, emergency response agencies, additional signage will need to be installed within the development. Staff is recommending a condition of approval requiring the applicant work with the Fire Marshal

in determining the design, number and location of necessary signage, with the signage installed prior to above ground construction.

- Traffic Impact Study Findings: The proposed building addition is expected to generate a slight increase to the amount of traffic generated by the site, but less traffic than what was estimated in earlier studies. The existing geometry of the surrounding roadways and more intersections are expected to have adequate capacity for the additional traffic. The existing driveway approaches on EP True Parkway and 60<sup>th</sup> Street are both wide enough to allow for 2 lanes of exiting vehicles. To improve operations for traffic exiting the driveways and to minimize potential confusion/conflicts, striping the outbound lanes as 2 lanes should be considered.
- <u>Vesting of Entitlement</u>: Per City Code, entitlement (approval to construct or implement) shall remain
  in effect so long as substantial site work has progressed beyond grading and completion of
  structural foundations and twenty-five percent (25%) of the total building area has occurred above
  grade within twenty-four (24) months of the effective date of the approval, unless a greater time
  period is authorized at time of the original entitlement, or by approval of an extension of the original
  entitlement. It is the responsibility of the developer to be aware of this deadline and request an
  extension of the approval prior to the expiration date.

Outstanding Issues: There are no outstanding issues.

Planning and Zoning Commission Action:
Date: August 22, 2022

Vote:

Recommendation:

**Recommendation:** Approve the Major Modification to Site Plan request, subject to the applicant meeting all City Code requirements, and the following conditions of approval:

- Prior to allowance of above ground construction, the applicant installing site directory boards and internal signage in a design, number and locations as determined necessary by the City's Fire Marshal to aid in wayfinding.
- Applicant acknowledging and agreeing to execute the associated Parkland Dedication Agreement
  prior to issuance of the associated building permit. Furthermore, the applicant agrees that
  installation of identified improvements shall be completed and approved by the city's Parks and
  Recreation Department prior to issuance of a Final Occupancy Permit for any unit within this new
  building.

# Lead Staff Member: Kate DeVine

**Approval Meeting Dates:** 

Planning and Zoning Commission	August 22, 2022
City Council	

# **Staff Report Reviews:**

Planning & Zoning	□ Development Coordinator (or)	□ Legal Department
Commission	□ Director	Z Legal Department
City Council	□ Director	□ Legal Department
	□ Appropriations/Finance	☐ Agenda Acceptance


Publications (if applicable)

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Published	Des Moines Register
In:	Community Section
Date(s) Published	n/a
Date(s) of Mailed Notices	n/a

Council Subcommittee Review (if applicable)

Subcommittee	Development & Planning		
Date Reviewed	5/16/22		
Recommendation	⊠ Yes	□ No	□ Split

# **Location Map**

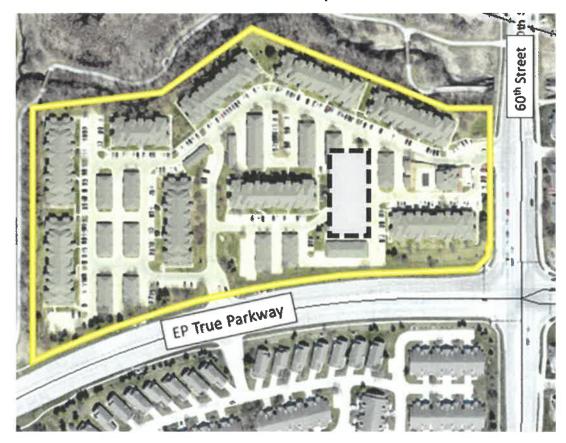

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# SITE PLAN FOR:

# **POLO CLUB APARTMENTS**

# WEST DES MOINES, IOWA

TOPOGRAPHIC MAP AND DEMOLITION PLAN

EROSION AND SEDIMENT CONTROL PLAN

INDEX OF SHEETS

NO.

C0.1

C6.1

E1.1

C1.1-C1.2 DETAILS

C3.1-C3.2 DIMENSION PLAN

C4.1-C4.2 GRADING PLAN

DESCRIPTION

COVER SHEET

TRAIL ACCESS PLAN

UTILITY PLAN

LANDSCAPE PLAN

1-800-292-8989

PROPOSED BUILDING DATA

CONSTRUCTION SCHEDULE


ANY UTILITIES SHOWN HAVE BEEN LOCATED FROM FIELD

ANY UTILITIES SHOWN HAVE BEEN LOCATED FROM FIELD SURVEY AND RECORDS OBTAINED BY THIS SURVEYOR. THE SURVEYOR MAKES NO GUARANTEE THAT THE UTILITIES SHOWN COMPRISE ALL THE UTILITIES IN THE AREA, EITHER IN SERVICE OR ABANDONED. THE SURVEYOR FURTHER DOES NOT WARRANT THAT THE UTILITIES SHOWN ARE IN THE EXACT LOCATION SHOWN.

ANTICIPATED START DATE = 08/01/2022 ANTICIPATED FINISH DATE = 03/01/2022

**UTILITY WARNING** 

### VICINITY MAP

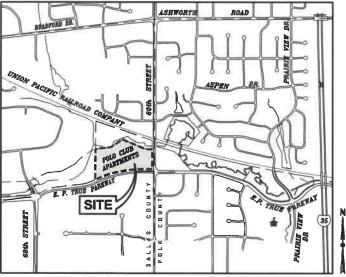

# WEST DES MOINES, IOWA

#### OWNER/APPLICANT

POLO CLUB LLC 6201 E.P. TRUE PARKWAY WEST DES MOINES, IA 50266 PHONE: (515) 493-3164

#### **ENGINEER**

CIVIL DESIGN ADVANTAGE, LLC 4121 NW URBANDALE DRIVE URBANDALE, IOWA 50322 CONTACT: DOUG MANDERNACH EMAIL: DOUGMOCDA-ENG COM

### SURVEYOR

CIVIL DESIGN ADVANTAGE, ILC 4121 NW URBANDALE DRIVE URBANDALE, IOWA 50322 CONTACT: CHARLIE MCGLOTHI EN EMAIL: CHARLIEM@CDA-ENG.COM PH. (515) 369-4400

### **ARCHITECT**

SIMONSON & ASSOCIATES ARCHITECTS LLC 1717 INGERSOLL AVENUE DES MOINES IA 50309 CONTACT: TODD WSKUS PH: (515) 440-5626

# DATE OF SURVEY

02/16/2022

### PROJECT SITE ADDRESS

6201 EP TRUE PARKWAY WEST DES MOINES, IA 50266

# **BENCHMARKS**

WDM BENCHMARK #122: NE CORNER OF ASHWORTH ROAD AND 63RD STREET, NW CORNER OF SIDEWALK JUNCTION, 1 FOOT WEST OF NORTH-SOUTH SIDEWALK, 1 FOOT NORTH OF EAST-WEST SIDEWALK/BIKE PATH, 11 FEET EAST OF BACK OF CURB.

WDM BENCHMARK #128:

NW CORNER OF E.P. TRUE PARKWAY AND PRAIRIE VIEW DRIVE.

61.5 FEET WEST OF THE TRAFFIC SIGNAL MANHOLE AND 8.5
FEET NORTH OF BACK OF WALK.

• ELEV = 136.22

# SUBMITTAL DATES

03/14/2022 SECOND SUBMITTAL: 05/05/2022

# LEGAL DESCRIPTION

LOTS 2 & 3, WRENWOOD PLACE, AN OFFICIAL PLAT IN THE CITY OF WEST DES MOINES, DALLAS COUNTY, IOWA.

WRENWOOD PUD AND RESIDENTIAL HIGH-DENSITY (RH-18)

HIGH DENSITY RESIDENTIAL (HD)

EXISTING USE: APARTMENTS PROPOSED USE: APARTMENTS

JIRED:
STUDIO OR EFFICIENCY=1.5 SPACES PER UNIT
1 OR 2- BEDROOM = 1.75 SPACES PER UNIT
+ 1 PER 10 UNITS

306 (2 BEDROOM X 1.75)=535.5 26 (3 BEDROOM X 1.75)= 45.5		536 46	SPACES
332/10=33.2	=	33	SPACES
TOTAL REQUIRED	-	615	SPACES

# PROVIDED:

GARAGES PROPOSED: = 210 SPACES SURFACE = 421 SPACES
TOTAL PROPOSED = 631 SPACES

# **OPEN SPACE CALCULATION**

REQUIRED: 25% = 715,939\*.25=178,984.75 SF

EXISTING: 261.614 SF (36.5%)

# ZONING

# COMPREHENSIVE LAND DESIGNATION

## **EXISTING/ PROPOSED USE**

### **DEVELOPMENT SUMMARY**

AREA: 16.434 ACRES (715,939 SF)

PARKING = 25' BUILDING = 25' (35' FOR 3+ STORIES) BUILDING = 25' (35' FOR 3+ STORIES)

06 (2 BEDROOM X 1.75)=535.5 26 (3 BEDROOM X 1.75)= 45.5	=		SPACES
32/10=33.2	=	33	SPACES
TOTAL REQUIRED	-	615	SPACES

# GARAGES = 272 SPACES

# CIVIL DESIGN ADVANTAGE

4121 NW URBANDALE DRIVE, URBANDALE, IOWA 50322 PH: (515) 369-4400 Fax: (515) 369-4410 PROJECT NO. 2201.018

# GENERAL LEGEND

#### PROPOSED PROPERTY BOUNDARY SECTION LINE CENTER LINE RIGHT OF WAY BUILDING SETBACK PERMANENT EASEMENT TEMPORARY EASEMENT TYPE SW-501 STORM INTAKE TYPE SW-502 STORM INTAKE TYPE SW-503 STORM INTAKE σST TYPE SW-512 STORM INTAKE TYPE SW-513 STORM INTAKE Sī 1 TYPE SW-401 STORM MANHOLE ST TYPE SW-402 STORM MANHOLE FLARED END SECTION Д (3) TYPE SW-301 SANITARY MANHOLE STORM/SANITARY CLEANOUT WATER VALVE FIRE HYDRANT ASSEMBLY DETECTABLE WARNING PANEL WATER CURB STOP SANITARY SEWER SANITARY SERVICE \_s\_\_s\_\_s\_ STORM SEWER STORM SERVICE WATERMAIN WITH SIZE WATER SERVICE SAWCUT (FULL DEPTH) SILT FENCE USE AS CONSTRUCTED (U.A.C.) MINIMUM PROTECTION ELEVATION MPE FINISHED GRADE AT HYDRANT

WATER CURB STOP	CS M
WELL	Owe
STORM SEWER MANHOLE	<b>(57)</b>
STORM SEWER SINGLE INTAKE	E.13
STORM SEWER DOUBLE INTAKE	
FLARED END SECTION	
DECIDUOUS TREE	0
CONIFEROUS TREE	交
DECIDUOUS SHRUB	6
CONIFEROUS SHRUB	0
ELECTRIC POWER POLE	⇒
GUY ANCHOR	→
STREET LIGHT	O
POWER POLE W/ TRANSFORMER	♣
UTILITY POLE W/ LIGHT	<b>∳</b> —
ELECTRIC BOX	
ELECTRIC TRANSFORMER	E
ELECTRIC MANHOLE OR VAULT	Œ
TRAFFIC SIGN	
TELEPHONE JUNCTION BOX	Ť
TELEPHONE MANHOLE/VAULT	T
TELEPHONE POLE	\$ co X
GAS VALVE BOX	₩
CABLE TV JUNCTION BOX	TV
CABLE TV MANHOLE/VAULT	₽
MAIL BOX	M
BENCHMARK	O <sub>BM</sub>
SOIL BORING	<b>.</b> ♦58
UNDERGROUND TV CABLE	TV
GAS MAIN	
FIBER OPTIC	———F0———
UNDERGROUND TELEPHONE	
OVERHEAD ELECTRIC	OE
UNDERGROUND ELECTRIC	
FIELD TILE	— — — TILE — —
SANITARY SEWER W/ SIZE	———— 8"'S — — —
STORM SEWER W/ SIZE	— — 15"ST — —
WATER MAIN W/ SIZE	

**EXISTING** 

SANITARY MANHOLE

WATER VALVE BOX

FIRE HYDRANT


### WEST DES MOINES NOTES


- ALL WATER WORK, PUBLIC OR PRIVATE, SHALL BE DONE IN ACCORDANCE WITH WEST DES MOINES WATER WORKS STANDARD SPECIFICATIONS."
- 2. CONTRACTOR SHALL NOTIFY WEST DES MOINES WATER WORKS AT LEAST THE GENERAL CONTRACTOR SHALL BE RESPONSIBLE FOR THE COORDINATION OF WORK OF ALL SUBCONTRACTORS INVOLVED IN THE PROJECT.
- CONTACT BUILDING INSPECTION (515-222-3630) A MINIMUM OF 24 HOURS IN ADVANCE FOR PRIVATE UTILITY INSTALLATION INSPECTIONS.
- 4. THE GENERAL CONTRACTOR SHALL BE RESPONSIBLE FOR COMPLIANCE WITH THE WEST DES MOINES WATER WORKS AND THE CITY'S CROSS CONNECTION CONTROL/CONTAINMENT PROVISION
- 5. THE GENERAL CONTRACTOR SHALL BE RESPONSIBLE FOR THE PROPER INSTALLATION OF AN APPROVED FOR THE PROPER INSTALLATION OF AN APPROVED BACKFLOW PREVENTION ASSEMBLY(16S) FOR CONTAINMENT IN ALL NEW CONSTRUCTION. BACKFLO PREVENTION TO BE INSTALLED PER CITY ORDINANCE 1297, 54–1998. CONTRACTOR SHALL NOTIFY WEST DES MOINES WATER WORKS, RALPH RENTERIA, DESCRIPTION OF ALL BACKFLOW DEVICES TO SCHEDULE FINAL

  BACKFLOW DEVICES TO SCHEDULE FINAL

ALL CONSTRUCTION MATERIALS, DUMPSTERS, DETACHED TRAILERS OR SIMILAR ITEMS ARE PROHIBITED ON PUBLIC STREETS OR WITHIN THE PUBLIC R.O.W.

THE MOST RECENT EDITION OF THE <u>WEST DES MOINES STANDARD SPECIFICATIONS.</u>
THE <u>PUBLIC RIGHTS-OF-WAY ACCESSIBILITY GUIDELINES</u> (PROWAG) AND ALL CITY SUPPLEMENTALS, IF APPLICABLE, SHALL APPLY TO ALL WORK ON THIS PROJECT UNLESS OTHERWISE NOTED.

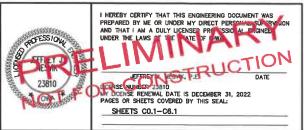

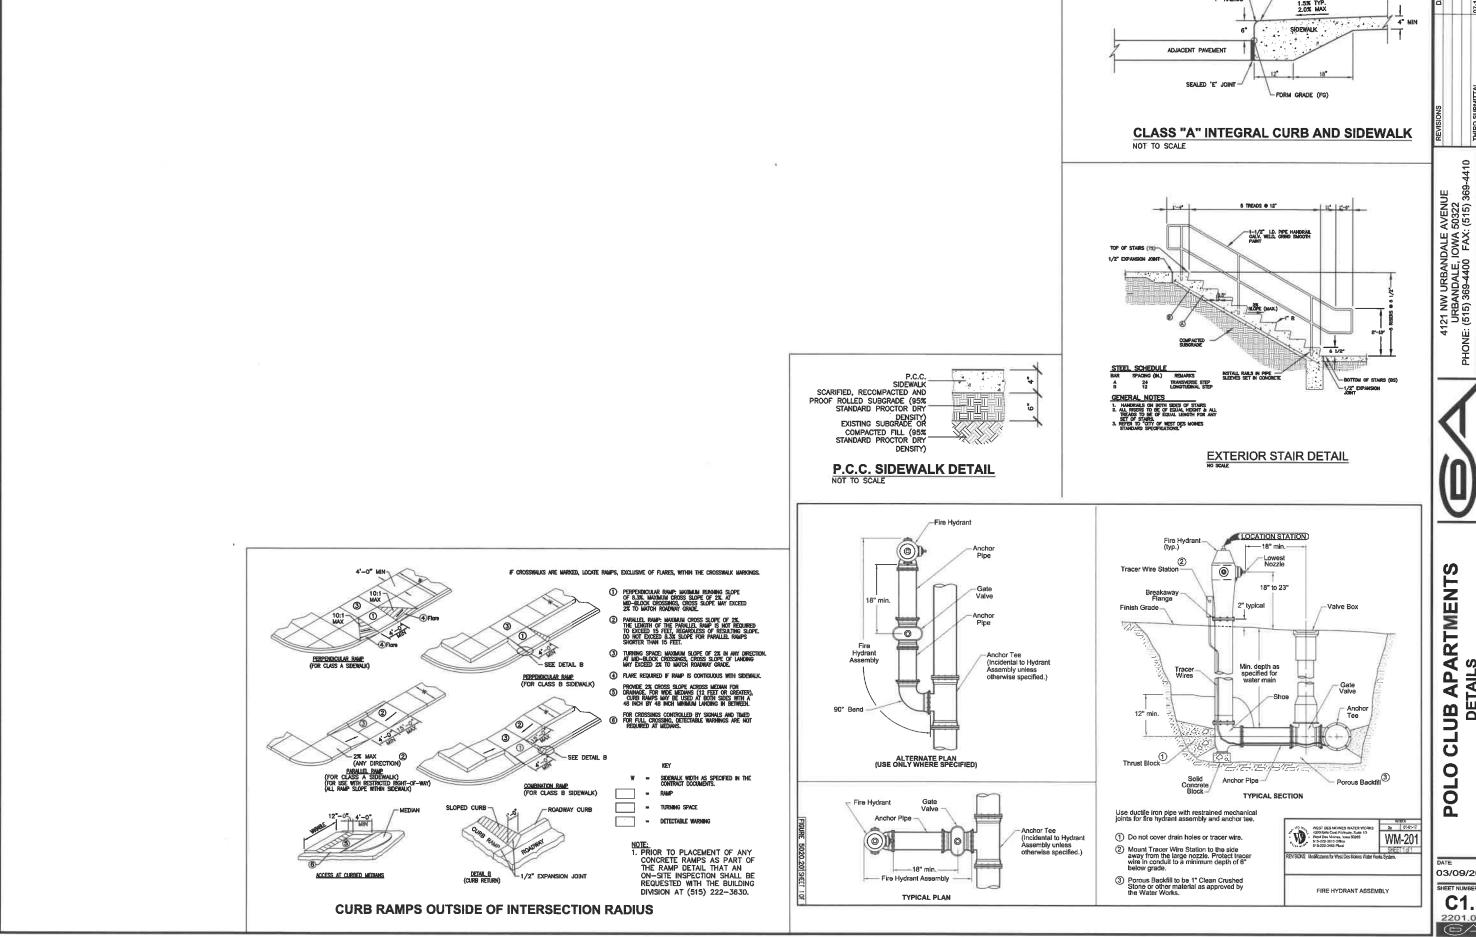

TOP OF CURB (TC)

CIVIL DESIGN ADVANTAGE

CLUB APARTMENT DETAILS


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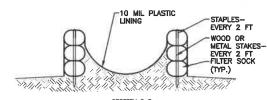
C1.1 2201.018 NOTES

1. USE FOR SERVICE COMMECTION WHEN SANITARY SEMER DEPTH IS 12.0' OR IMALESS ADDITIONAL DEPTH IS NECESSARY TO SERVE ADMICIANT PROPERTY.

# **SANITARY SEWER SERVICE RISER**

NOT TO SCALE CITY OF WEST DES MOINES DETAIL 4.6



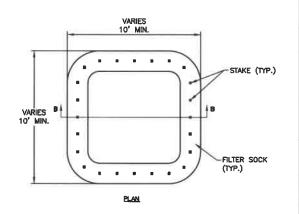

# SECTION B-B


- 1. ACTUAL LAYOUT AND LOCATION TO BE DETERMINED IN FIELD BY THE CONTRACTOR.
  2. THE CONCRETE WASHOUT SIGN SHALL BE INSTALLED WITHIN
- 2. THE CONCRETE WASHOUT SIGN STRUL BE INSTRUCTED

  30' OF THE TEMPORARY CONCRETE WASHOUT FACILITY.

  3. TEMPORARY WASHOUT AREA MUST BE AT LEAST 50' FROM
  A STORM DRAIN, CREEK BANK OR PERIMETER CONTROL.

  4. CLEAN OUT CONCRETE WASHOUT AREA WHEN 75% FULL.


# **CONCRETE WASHOUT CONTAINER**

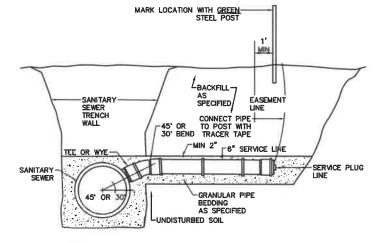


NOTE
1. USE FOR SERVICE CONNECTION WHEN SANITARY SEWER DEPTH IS
12.0° OR LESS OR WHEN REQUIRED TO SERVE ADJACENT PROPERTY.

# **SANITARY SEWER SERVICE**

NOT TO SCALE CITY OF WEST DES MOINES DETAIL 4.5

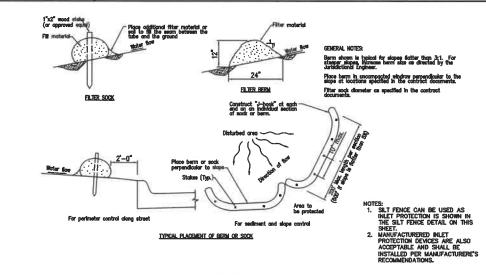


**FILTER SOCK** 

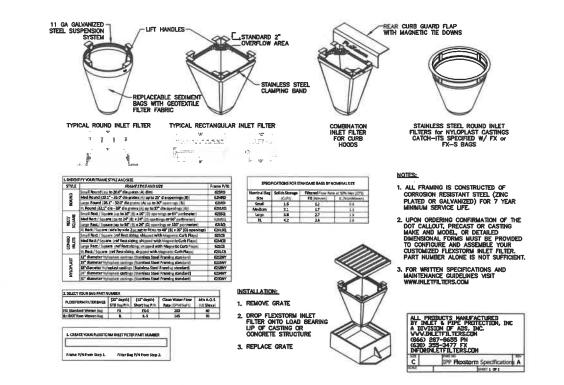

# FLEXSTORM CATCH-IT FILTERS FOR TEMPORARY INLET PROTECTION PRODUCT SELECTION AND SPECIFICATION DRAWING

NOT TO SCALE

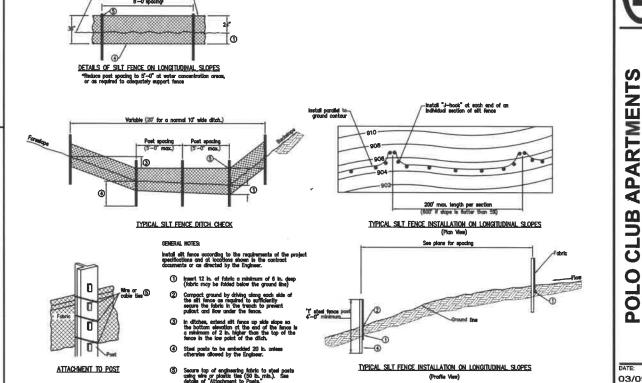

SILT FENCE NOT TO SCALE

4121 NW URBANDALE AVENUE URBANDALE, IOWA 50322 PHONE: (515) 369-4400 FAX: (515) 369-4410 ENGINEER: JJN


CIVIL DESIGN ADVANTAGE


B APARTMENTS

CLUB,

03/09/2022 SHEET NUMBER:

C1.2 2201,018 6/4

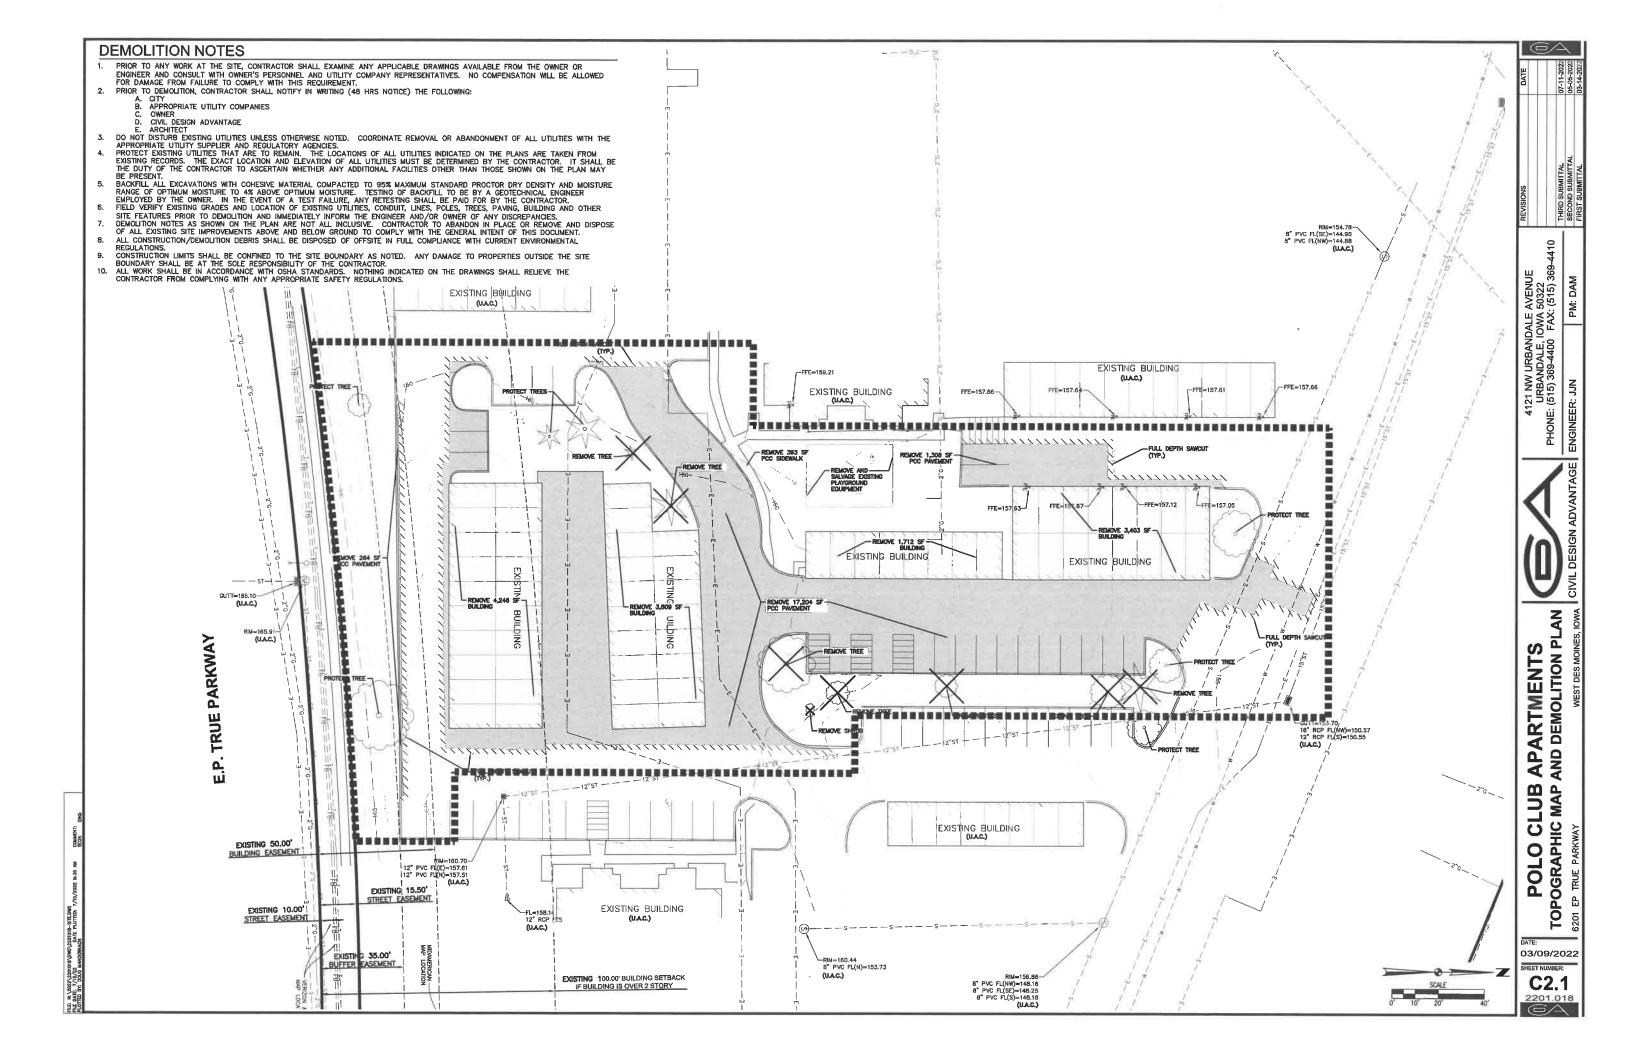


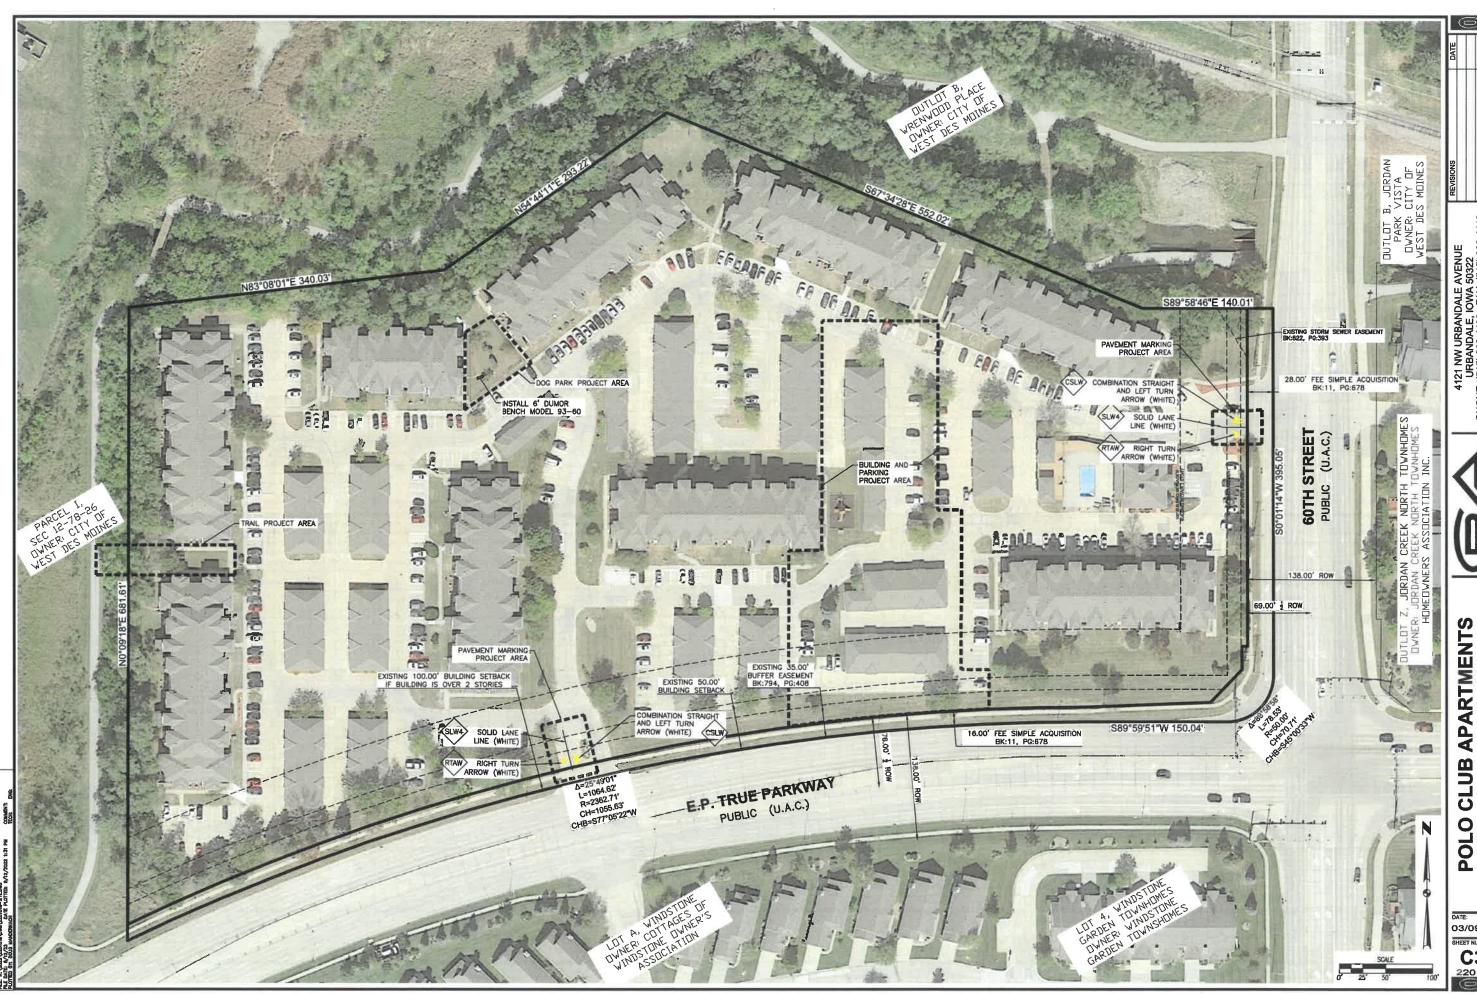



ENGINEER:

LO CLUB APARTMENTS OVERALL DIMENSION PLAN

03/09/2022 C3.1 2201.018

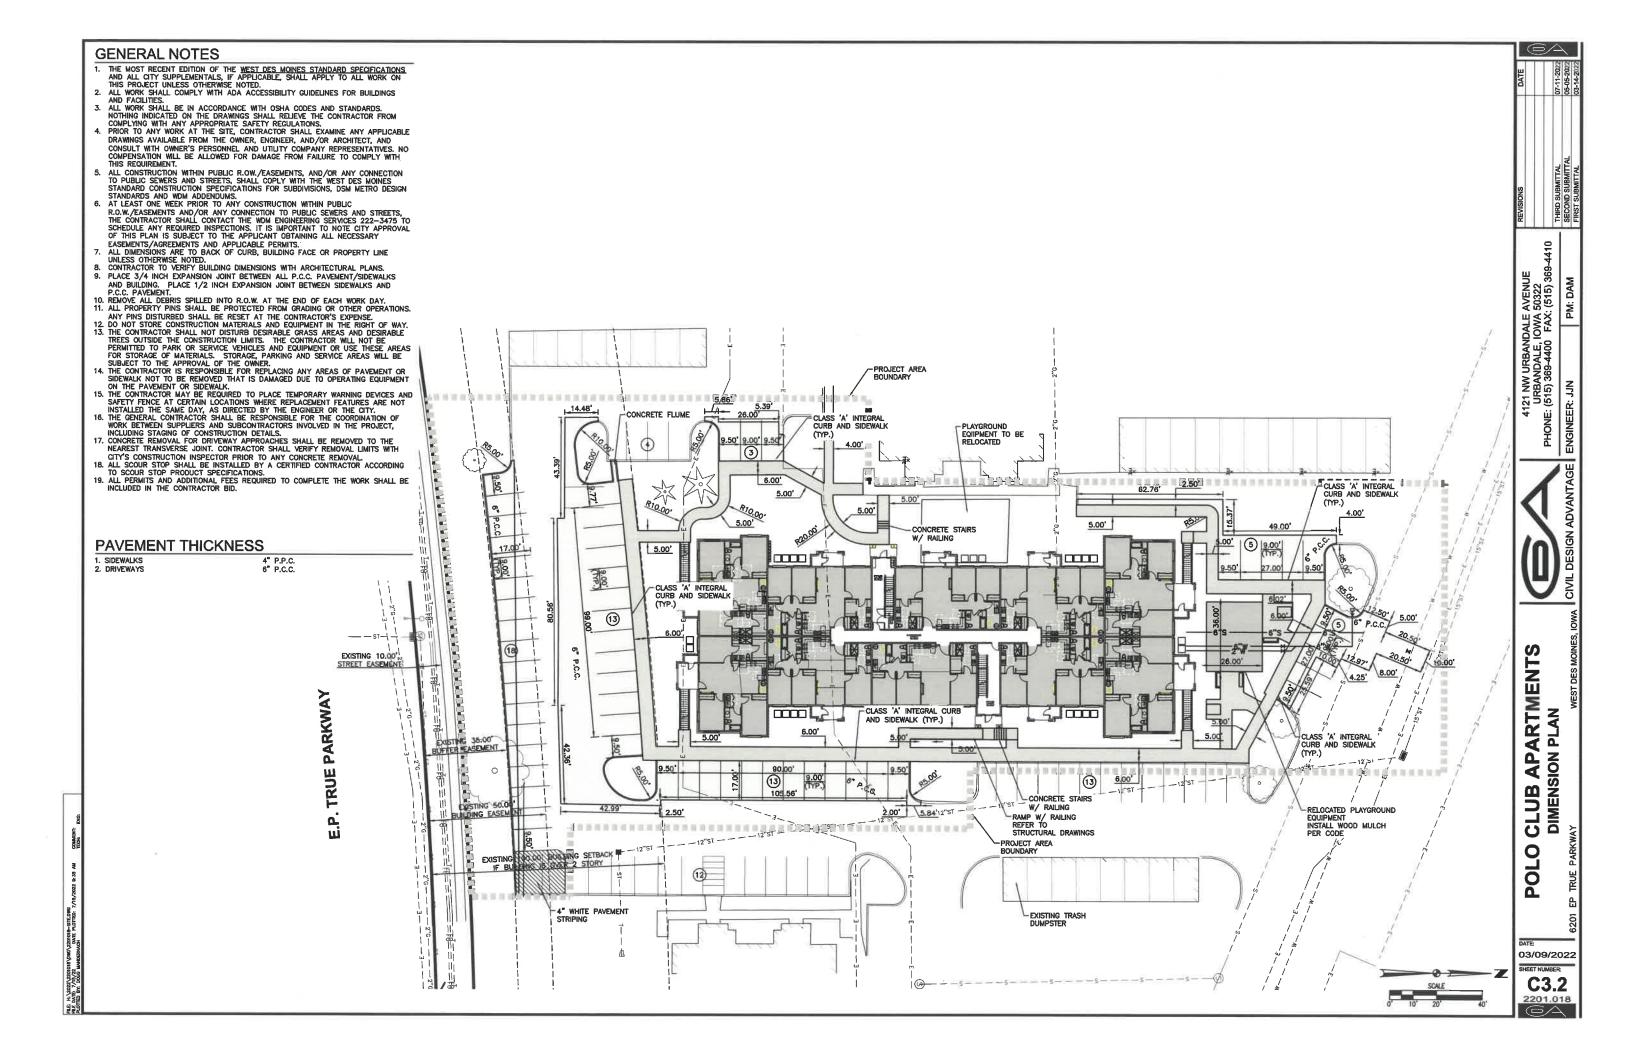

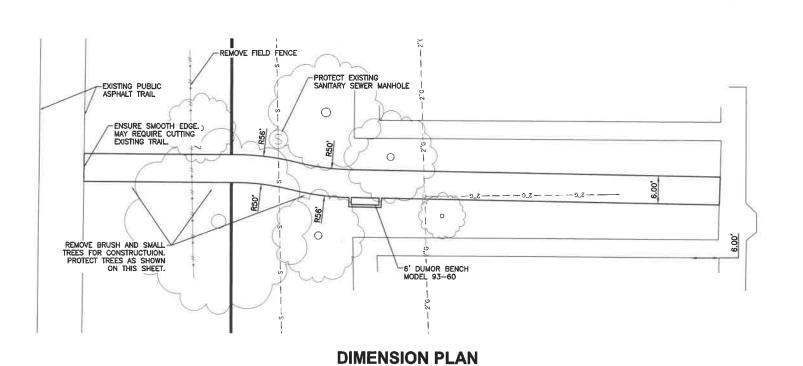

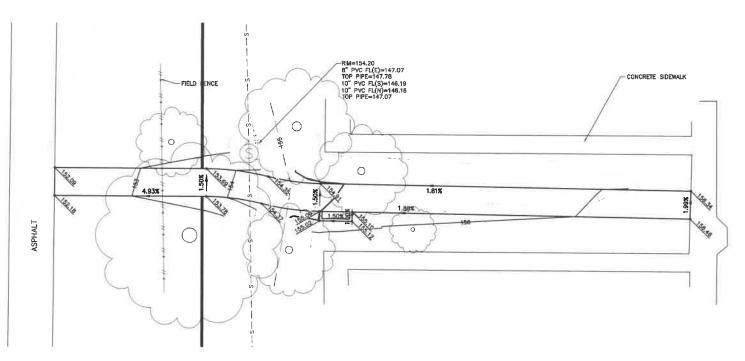






03/09/2022 SHEET NUMBER:

4121 NW URBANDALE AVENUE URBANDALE, IOWA 50322 PHONE: (515) 369-4400 FAX: (515) 369-4410

PM: DAM

C3.3 2201.018

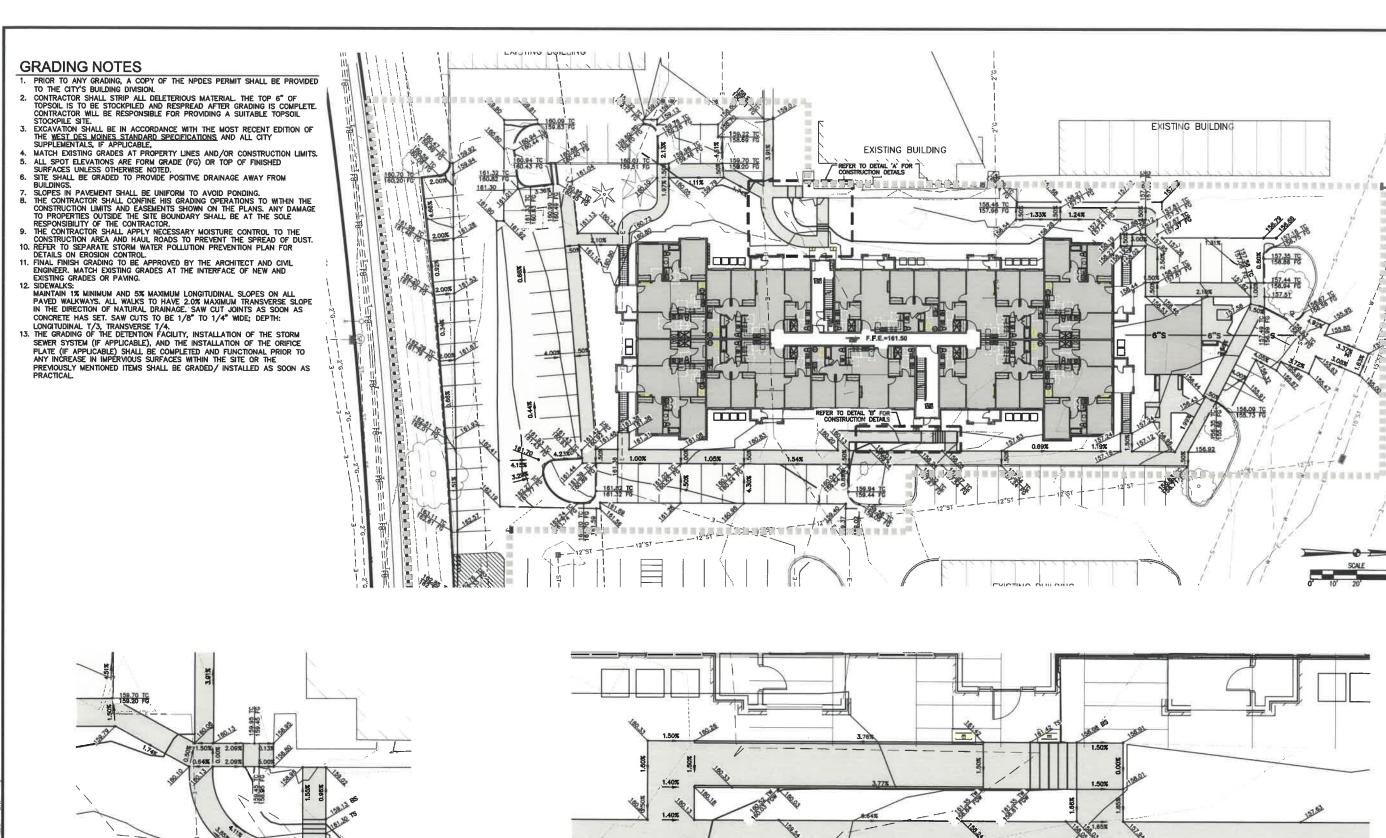

22/2201018/DWC/2201018-STE.DWO DATE PLOTTED: 7/15/2022 8:35 AM COMMENT: 5 DOLG MANNENAGA TECH. FTCH: 6

**DETAIL A** 

DATE:
03/09/2022
SHEET NUMBER:

No.

**DETAIL B** 

POLO

CLUB APARTMENT GRADING PLAN

AVENU 50322 (: (515) 3

4121 NW URBANDALE / URBANDALE, IOWA ( PHONE: (515) 369-4400 FAX:

CIVIL DESIGN ADVANTAGE

03/09/2022 SHEET NUMBER: C4.1 2201.018

# STABILIZATION QUANTITIES


ITEM NO.	ITEM	UNIT	TOTAL
1	SILT FENCE	LF	512
2	FILTER SOCK	UF	1,063
3	SEEDING, FERTILIZING, AND MULCHING	AC	0.99
4	INLET PROTECTION DEVICES	EA	3
5	CONCRETE WASHOUT PIT	EA	1

# NOTES:

- If dewatering is needed for any reason, discharge of water offsite is to conform with the general permit #2 requirement.
- DISTURBED AREAS SHALL BE TEMPORARILY SEEDED OR MULCHED IMMEDIATELY WHENEVER CLEARING, GRADING, EXCAVATING, OR OTHER EARTH DISTURBING ACTIVITIES HAVE PERMANENTLY OR TEMPORARILY CEASED AND WILL NOT RESUME FOR A PERIOD EXCEEDING 14 CALENDAR DAYS.
- STORM SEWERS AND DRAINAGE WAYS SHALL BE PROTECTED FROM CONCRETE SLURRY PRODUCED BY SAWCUTTING AND CONCRETE GRINDING.

# DISCHARGE POINT SUMMARY

DISCHARGE POINT #1_TO_JORDAN_CREEK_±700_FT TOTAL AREA DISTURBED TO DISCHARGE POINT* STORAGE VOLUME REQUIRED (# OF ACRES*3600_CU_FT)	0.43 ACRES 1,548 CU FT	DISCHARGE POINT #2 TO JORDAN CREEK ±200 FT TOTAL AREA DISTURBED TO DISCHARGE POINT' STORAGE VOLUME REQUIRED (# OF ACRES*3600 CU FT)	0.56 ACRES 2,016 CU FT
VOLUME PROVIDED IN FILTER SOCK (523 LF ● 2.0 CU FT/LF OF SOCK) VOLUME PROVIDED IN SILT FENCE (366 LF ● 7.5 CU FT/LF OF FENCE) TOTAL VOLUME PROVIDED	1,046 CU FT 2,745 CU FT 3,791 CU FT	VOLUME PROVIDED IN FILTER SOCK (540 LF @ 2.0 CU FT/LF OF SOCK) VOLUME PROVIDED IN SILT FENCE (148 LF @ 7.5 CU FT/LF OF FENCE) TOTAL VOLUME PROVIDED	1,080 CU FT 1,095 CU FT 2,175 CU FT

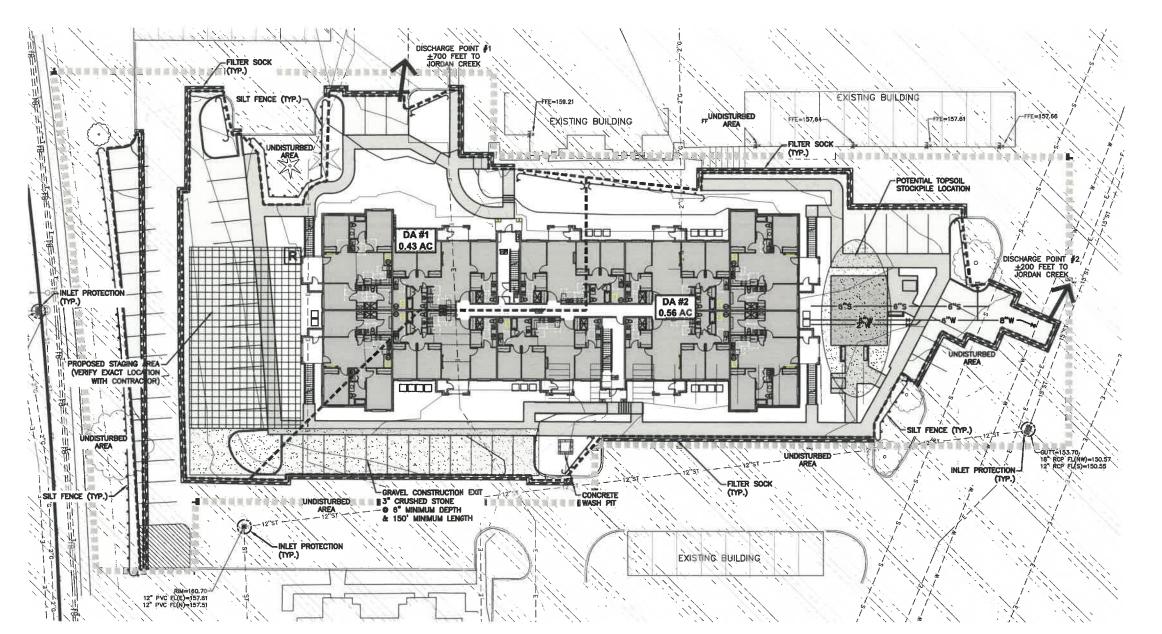

SWPPP LEGEND	
DRAINAGE ARROW	XXX %
GRADING LIMITS	
FILTER SOCK	
SILT FENCE	• • • •
INLET PROTECTION	0
PORTABLE RESTROOM	R
CONCRETE WASHOUT PIT	
AREA TO BE SEEDED	
STRAW MAT	
UNDISTURBED AREA	1. 11
RIP-RAP	
GRAVEL ENTRANCE	18
STAGING AREA	
TEMPORARY SEDIMENT BASIN	(TSB#)

O CLUB APARTMENTS
AND SEDIMENT CONTROL PLAN POLO (EROSION AN

4121 NW URBANDALE AVENUE URBANDALE, IOWA 50322 PHONE: (515) 369-4400 FAX: (515) 36

03/09/2022 SHEET NUMBER:

C5.1 2201.018  $\bigcirc \triangle$ 

# UTILITY NOTES

- 1. REFER TO MECHANICAL, ELECTRICAL AND PLUMBING PLANS FOR UTILITY SERVICE SIZES AND EXACT LOCATIONS. REFER TO ELECTRICAL PLANS FOR ELECTRIC AND TELEPHONE SERVICE CONSTRUCTION DETAILS. REFER TO MECHANICAL PLANS FOR GAS SERVICE CONSTRUCTION DETAILS.

  2. FIELD VERHIFY ELEVATIONS AND LOCATIONS OF ALL CONNECTIONS TO EXISTING UTILITIES PRIOR TO COMMENCING CONSTRUCTION.

  3. PROVIDE TEMPORARY SUPPORT FOR EXISTING UTILITY LINES THAT ARE ENCOUNTERED DURING CONSTRUCTION UNTIL BACKFILLING IS COMPLETE.

  4. BACKFILL ALL UTILITY TRENCHES ACCORDING TO THE MOST RECENT EDITION OF THE WEST DES MOINES WATER WORKS STANDARD SPECIFICATIONS, AND ALL CITY SUPPLEMENTALS. MAINTAIN A MINIMUM OF 5.5' COVER OVER ALL WATERMAINS.

  5. ALL UTILITIES SHALL BE STUBBED TO 5 FEET FROM BUILDINGS, REFER TO MEP PLANS FOR DESIGN FROM S' OUTSIDE OF BUILDING FACE.

  6. ADJUST ALL MANHOLES AND INTAKES TO FINISHED GRADES.

  7. ALL SANITARY SEVERD AND WATER ERPOYERS SHALL BE CONSTRUCTION. ACCORDANCE WITH THE CITYCE PLUMBING CODE.

- ALL SANITARY SEWER AND WATER SERVICES SHALL BE CONSTRUCTED IN ACCORDANCE WITH THE CITY'S PLUMBING CODE.

  18" MINIMUM VERTICAL CLEARANCE BETWEEN STORM SEWER AND SANITARY SEWER PIPES, 18" MINIMUM VERTICAL CLEARANCE BETWEEN SANITARY SEWER AND WATER MAIN.
- SANITARY SEWER AND WATER MAIN.

  MAINTAIN A MINIMUM OF 10' HORIZONTAL SEPARATION BETWEEN SANITARY SEWER LINES AND WATER MAINS.

  WHIERE PUBLIC UTILITY FIXTURES ARE SHOWN AS EXISTING ON THE PLANS OR ENCOUNTERED WITHIN THE CONSTRUCTION AREA, IT SHALL BE THE RESPONSIBILITY OF THE CONTRACTOR TO NOTIFY THE OWNERS OF THOSE UTILITIES PRIOR TO THE BEGINNING OF ANY CONSTRUCTION. THE CONTRACTOR SHALL AFFORD ACCESS TO THESE FACILITIES FOR NECESSARY MODIFICATION OF SERVICES. UNDERGROUND FACILITIES, STRUCTURES AND UTILITIES HAVE BEEN PLOTTED FROM AVAILABLE SURVEYS AND RECORDS, AND THEREFORE, THEIR LOCATIONS MUST BE CONSIDERED APPROXIMATE ONLY. IT IS POSSIBLE THERE MAY BE OTHERS. THE EXISTENCE OF WHICH IS PRESENTLY NOT KNOWN OR SHOWN. IT IS THE CONTRACTORS RESPONSIBILITY TO DETERMINE THEIR EXISTENCE AND EXACT LOCATIONS AND TO AVOID DAMAGE THERETO. NO CLAIMS FOR ADDITIONAL COMPENSATION WILL BE ALLOWED TO THE CONTRACTOR FOR ANY INTERFERENCE OR DELAY CAUSED BY SUCH WORK. THE CONTRACTOR IS REQUIRED TO UTILIZE THE UTILITY ONE—CALL SERVICE AT 800—292—8989 AT LEAST 48 HOURS PRIOR TO EXCAVATING ANYWHERE ON THE PROJECT.

### WEST DES MOINES NOTES

- ALL WATER WORK, PUBLIC OR PRIVATE, SHALL BE DONE IN ACCORDANCE WITH WEST DES MOINES WATER WORKS STANDARD SPECIFICATIONS.
- 2. CONTRACTOR SHALL NOTIFY WEST DES MOINES WATER WORKS AT LEAST THE GENERAL CONTRACTOR SHALL BE RESPONSIBLE FOR THE COORDINATION OF WORK OF ALL SUBCONTRACTORS INVOLVED IN THE PROJECT.
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# PRIVATE WATER MAIN QUANTITIES

ITEM NO.	ITEM DESCRIPTION	UNIT	QUANTITY
1	WATER MAIN, 6 IN. DIA.	UF	83
2	WATER MAIN, 8 IN. DIA.	LF	25
3	8"X8" TAPPING ASSEMBLY	EA	11
4	VALVE, GATÉ, 6 IN DIA.	EA	1
5	VALVE, GATE, 2 IN DIA.	EA	1
6	BEND, 45° 8 IN DIA.	EA	1
7	REDUCER, 8-6 IN DIA.	EA	2
8	FIRE HYDRANT ASSEMBLY	EA	1
9	2" DOMESTIC SERVICE	EA	1

AVENU 50322 : (515) 4121 NW URBANDALE A URBANDALE, IOWA 5 NE: (515) 369-4400 FAX: (

PHONE: (

LUB APARTMENT UTILITY PLAN

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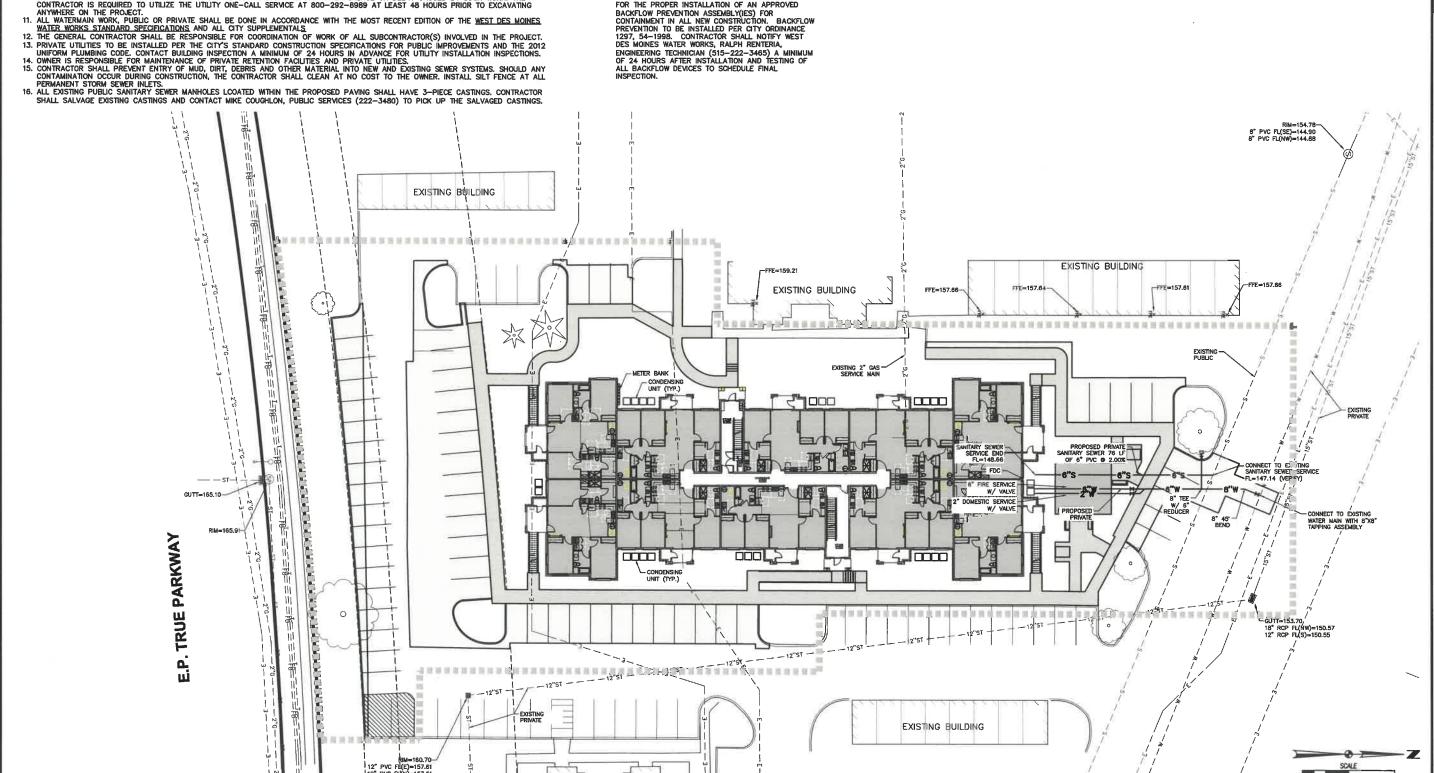
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03/09/2022 C6.1

2201.018



PLANT SCHEDULE ROTATE
EVERGREEN TREES QTY COMMON NAME

Black Hills White Spruce

Chanticleer Callery Pear

Skyline Honey Locust

10 Winter Gern Japanese Box 18 Isanti Red Twig Dogwood 4 Arcadia Juniper

Miss Kim Korean Lilac

Dwarf Korean Lilac Dense Anglo-Japan

QTY COMMON NAME
27 Silver Feather Eulalia Grass

Old Gold Juniper Creeping Juniper PJM Rhododendron

Blue Colorado Saruce

TREES QTY COMMON NAME
3 Flome Amur Mople
2 Autumn Brilliance Apple Sen

1. LOCATE ALL UTILITIES BEFORE ANY PLANTING BEGINS.

1. THE MOST RECENT EDITION OF THE SUDAS STANDARD SPECIFICATIONS AND ALL CITY SUPPLEMENTALS, IF APPLICABLE, SMALL APPLY TO ALL WORK ON THIS PROJECT UNLESS OTHERWINE NOTED.

1. TYPE, SIZE, AND CALLITY OF PLANT MATERIAL SHALL CONFORM TO THE MOST CURRENT EDITION OF THE SMERICAN STANDARD FOR NURSEN'S STOCK ANSI 2021.

4. CHARLES AND CHARLES AND STANDARD FOR NURSEN'S STOCK ANSI 2021.

5. SOO ALL DISTURBED AREAS AS DIRECTED BY OWNER.

5. SOO ALL DISTURBED AREAS AS DIRECTED BY OWNER.

6. BACKFILL TO TOP OF CURB. (JIMBUS 1 1/2" FOR SOO, IF REQ.)

7. WEED PREVENTER (PRE-EMERGENT) SHALL BE SPREAD OVER SOIL AFTER PLANTING AND BEFORE MULCHING IN ALL PLANTING BEDS FOR MANUFACTURER'S RECOMMENDATIONS.

8. SHREDDED HARDWOOD MULCH SHALL BE PLACED AROUND ALL TREES, SHRUBS AND IN ALL PLANTING BEDS FOR MANUFACTURER'S RECOMMENDATIONS.

8. SHREDDED HARDWOOD MULCH SHALL BE PLACED AROUND ALL TREES, SHRUBS AND IN ALL PLANTING BEDS FOR MANUFACTURER'S RECOMMENDATIONS AND SEFORE ULCHING IN ALL PLANTING BEDS FOR MANUFACTURER'S RECOMMENDATIONS AND SEFORE ULCHING IN ALL PLANTING BEDS FOR MANUFACTURER'S RECOMMENDATIONS AND PLANTING BEDS FOR FOR MANUFACTURER'S RECOMMENDATIONS AND PLANTING BEDS FOR FOR INFORMATION ONLY, THE DRAWING SHALL PREVAL FOR ANY CONFLICTS ARISE.

1. ALL DEGRIS SPALLED IN THE PUBLIC R.O.W. SHALL BE PICKED UP BY THE CONTRACTOR AT THE END OF EACH WORK DAY.

12. CONTRACTOR SHALL WARRANTY ALL PLANT MATERIALS FOR A PERIOD OF ONE YEAR FROM DATE OF INSTALLATION.

13. CONTRACTOR SHALL WARRANTY ALL PLANT MATERIALS FOR A PERIOD OF ONE YEAR FROM DATE OF INSTALLATION.

LANDSCAPE NOTES

# EP TRUE BUFFER REQUIREMENTS - 220 LF

THE EQUIVALENT OF ONE OVERSTORY TREE OR UPRIGHT EVERGREEN TREE, TWO UNDERSTORY TREES AND SIX SHRUBS PER THIRTY FIVE LINEAR FEET OF THE BUFFER PARK.

REQUIRED: OVERSTORY/EVERGREEN TREES: ORNAMENTAL TREES: SHRUBS:

PROVIDED:

CONDITION AND SIZE

B&S, 6' HEIGHT

BAB, 6' HEIGHT

CONDITION AND SIZE B&B, 1.5" CALIPER

B&B, 1.5" CALIPER

CONDITION AND SIZE B&B, 1.5" CALIPER B&B, 1.5" CALIPER B&B, 1.5" CALIPER B&B, 1.5" CALIPER

CONDITION AND SIZE

3 GAL

3 GAL

3 GAL

3 GAL

3 GAL

BOTANICAL NAME

BOTANICAL NAME Acer x freemanii "Cetzam" Til Gleditaia triacanthos "Skyline"

Cornus seriosa "santi" Juniperus sabina 'Arcadio Juniperus chinensis 'Sea Gree

Rhododendron x 'P.J.M.

Syringa patula 'Miss Kim Syrings meyeri "Palibin"

Toxus x media 'Densiformi

Miscanthus sinensis 'Silberfeder

Juniperus chinenelle 'Old Gold'

Juniperus horizontalis 'Plumosa C

Plosa glauca Densa

Picea pungens 'Glauca


Pyrus calleryana 'Chanticleer'

BOTANICAL NAME
Acer ginnola 'Flame'
Amelanchier x grandillora 'Autumn Brill


Buxus microphylia japonica 'Winter Gern


OVERSTORY/EVERGREEN TREES: =6 (1 EXISTING) ORNAMENTAL TREES:

=12 (1 EXISTING) =38

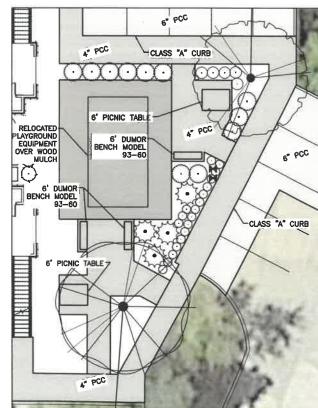

# **PLAYGROUND AREA DETAIL**

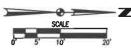

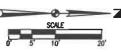

03/09/2022 SHEET NUMBER:

369-4410

AVENUE 50322 (: (515) 369

4121 NW URBANDALE / URBANDALE, IOWA ( PHONE: (515) 369-4400 FAX:

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CLUB APARTM LANDSCAPE PLAN

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ENGINEER: JJN

CIVIL DESIGN ADVANTAGE

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CLUB

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(5) (6) 4 CS-1 — (3) (2) (1) TR-1 -(CS-1) RL-1 A-50) RL-1 SC-1 SC-1 RL-1 RL-1 RF-1 LEVEL 3 BEARING 131' - 6 1/2" 中 122' - 5 1/4" LEVEL 2 BEARING 120' - 3 3/4" 本計 LEVEL 2 AREA PLAN 111' - 2 3/4" LEVEL 1 BEARING 109' - 1 1/4" BRIC-1 SD-1 |本| 二本 一本 Level 1 100' - 0" RL-1 SC-1 E.J. RL-1 RL-1 -RL-1 (PC-1) SC-1 (RL-1)-\_\_(RL-1 (RL-1) -( SC-1 RL-1 BRK-1 RF-1 BRK-1

# EAST ELEVATION SCALE: 1/8" = 1'-0"



2 SOUTH ELEVATION

# **GENERAL EXTERIOR ELEVATION NOTES**

- REFER TO ADDITIONAL NOTES AND REQUIREMENTS ON ALL OTHER DOCUMENTS AND OTHER DISCIPLINES DOCUMENTS.
- ALL CONDUIT RUNS & SERVICE LINES SHALL BE GROUPED TOGETHER IN A NEAT &
  ORDERLY MANNER AND SHOULD PENETRATE THE WALL AT THE LOWEST POINT
  AND ARE NOT TO RUN OVER THE TOP OF PARAPET. ALL OTHER CONDUITS &
  JUNCTION BOXES FOR EXTERIOR PERTURES & EQUIPMENT SHALL BE FULLY
  CONCEALED WITHIN THE BUILDING CONSTRUCTION.
- 3. ALL HORIZONTAL TRANSITIONS BETWEEN DIFFERENT MATERIALS SHALL BE FLASHED CONTINUOUS FROM UP BEHIND UPPER MATERIAL AND EXTEND OVER TO EXTERIOR FACE OF LOWER MATERIAL WITH DRIP EDGE.
- 4. ANY RETURNS OR BLIND ELEVATIONS NOT SHOWN SHALL BE SIMILAR IN MATERIAL AND MAKEUP TO ADJACENT CONDITIONS OR OTHER SIMILAR CONDITIONS.
- 5. NO EXPOSED MASONRY/MATERIAL CORES. MASONRY RETURNS AT WINDOWS/OPENINGS ARE REQUIRED IF FRAMING IS NOT DEEP ENOUGH TO PROVIDE CLOSURE AT THE BACKSIDE OF MASONRY FOR AN EFFECTIVELY SEALED JOINT.
- MATERIALS ABOVE CANOPIES & AWNINGS TO BE CONTINUED DOWN BEHIND THEM U.O.N., TYP.
- I. INSTALL VERTICAL EXPANSION JOINTS PER STRUCTURAL OR MINIMAL AT COLUMNIGRID LINES AND AT THE HEAD OF DOOR JAMBS/OPENINGS OR AS OTHERWISE NOTED OR WHERE REQUIRED PER STANDARD MATERAL PRACTICE TO REDUCE STRESS CRACKING. NO CONTROL JOINTE/PRANSION JOINT AT MAIN STRUCTURAL BEARING LOCATIONS. VERHEY JOINTS WITH ARCHITECT. INSTALL BRICK EXPANSION JOINT AT ALL INSIDE CORNERS.
- CAULK & SEAL ALL TRANSITION-CONTROL-EXPANSION AT ALL EXTERIOR MATERIALS.
- 11. WHERE EXTERIOR PAVING ADJACENT TO BUILDING, TOP OF PAVING TO BE 1/4"
  LOWER THAN INTERIOR FINISH FLOOR, SLOPING CONTINUOUSLY AWAY FROM
  BUILDING A MINIMUM OF 5', WHERE DOOR STOOP, 46" OUT FROM DOOR 1:48(2%)
  MAX SLOPE, AFTER 45' AWAY FROM DOOR 1:20(5%) MAXIMUM SLOPE TO PUBLIC
  WAY. (REFER TO CIVIL)
- 12. WHERE NO EXTERIOR PAVING ADJACENT TO BUILDING, TOP OF FINISHED LANDSCAPE A MINIMUM OF 4" BELOW INTERIOR FINISH FLOOR AND 4" BELOW EXTERIOR WALL FLASHINGAMEEPS, SLOPING CONTINUOUSLY AWAY FROM BUILDING A MINIMUM OF 5". (REFER TO CIVIL.)
- 13. ADDRESS SHALL BE PROVIDED ON STREET SIDE OF BUILDING AND ON MONUMENT SIGN. NUMBERS A MINIMUM 5 INCH CONTRASTING COLOR NUMBERS WITH MINIMUM 1/2" STROKE.
- 14. IF ANY SIGNAGE OR SIGN BASE IS SHOWN IT IS FOR REFERENCE ONLY, FINAL DESIGNS AND/OR ALLOWANCES SHALL BE DETERMINED WITH APPROVED SIGNAGE PERMIT(S).

ACTUAL DETAILS & DIMENSIONS MAY VARY AND ARE SUBJECT TO CHANGE. ALL DRAWINGS ARE SUBJECT TO AUTHORITY HAVING JURISDICTION APPROVAL. SIGNAGE SHOWN DOES NOT REPRESENT ALLOWABLE SIGNAGE PERMITTING/APPROVAL OF ALL SIGNAGE PER CURRENT CITY ORDINANCE BY OTHERS.

# **MISC EXTERIOR MATERIAL FINISHES**

ASSPRIAL PROOF STRINGLE, MATCH EQUSTRING,
SRICK ROWLOCK, MATCH BRKL-1,
SRICK SOUDIER COURSE, MATCH BRKL-1,
VINYL LAP SIDING, MATCH EQUSTRING,
VINYL LAP SIDING, MATCH EQUSTRING,
VINYL TRIM. WHITE, 8° AT WINDOW PERIMETER AND BUILDING CORNERS, 10° AT ACCENT BANDS.

**EXTERIOR MATERIAL LEGEND** 

**MATERIAL DESCRIPTION** 

MAT.

LABEL

TYPICAL U.O.N.

EXPOSED CONCRETE: GRIND SMOOTH & RUB/COAT WITH CEMENT SLURRY,

EXPOSED LINTELS: GALVANIZED & PAINTED TO MATCH ADJACENT MATERIAL

FULL BED BRICK, KING SIZE, GLEN GERY WINNETKA, MORTAR: MATCH EXISTING. CAST STONE. 8"x8". MATCH EXISTING.

PAINTED ACCENT. 8"x8".
ASPHALT ROOF SHINGLE, MATCH EXISTING

ABOVE. METAL STAIRS & RAILINGS: GALVANIZED & PAINTED TO MATCH ADJACENT

MATERIAL.
METAL BALCONIES & RAILINGS: GALVANIZED & PAINTED TO MATCH ADJACENT

CAULKS & SEALANTS: COLOR MATCHED TO ADJACENT MATERIAL HOLLOW METAL MAN DOORS & FRAMES: PAINTED TO MATCH ADJACENT MATERIAL LOUVERS: METAL PRE-FINISHED TO MATCH ADJACENT MATERIAL COLOR.

LIGHT FIXTURES: METAL PRE-FINISHED HOUSINGS TO MATCH ADJ, OPENING FRAMING, MECHANICAL EQUIPMENT: IF NOT SCREENED, COLOR TO MATCH ADJACENT

MATERIAL.
EXTERIOR UTILITY EQUIPMENT: IF ALLOWED, PAINTED TO MATCH ADJACENT

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SAA Proj. Mgr.

EXTERIOR **ELEVATIONS** 

A-202

# WEST ELEVATION SCALE: 1/8" = 1'-0"

PC-1 RL-1



2 NORTH ELEVATION

## **GENERAL EXTERIOR ELEVATION NOTES**

- REFER TO ADDITIONAL NOTES AND REQUIREMENTS ON ALL OTHER DOCUMENTS AND OTHER DISCIPLINES DOCUMENTS.
- ALL CONDUIT RUNS & SERVICE LINES SHALL BE GROUPED TOGETHER IN A NEAT &
  ORDERLY MANNER AND SHOULD PENETRATE THE WALL AT THE LOWEST POINT
  AND ARE NOT TO RUN OVER THE TOP OF PARAPET. ALL OTHER CONDUITS &
  JUNCTION BOXES FOR EXTERIOR FIXTURES & EQUIPMENT SHALL BE FULLY
  CONCEALED WITHIN THE BUILDING CONSTRUCTION.
- 3. ALL HORIZONTAL TRANSITIONS BETWEEN DIFFERENT MATERIALS SHALL BE FLASHED CONTINUOUS FROM UP BEHIND UPPER MATERIAL AND EXTEND OVER TO EXTENDE FACE OF LOWER MATERIAL WITH DRIP EDGE.
- ANY RETURNS OR BLIND ELEVATIONS NOT SHOWN SHALL BE SIMILAR IN MATERIAL AND MAKEUP TO ADJACENT CONDITIONS OR OTHER SIMILAR CONDITIONS.
- 5. NO EXPOSED MASONRY/MATERIAL CORES, MASONRY RETURNS AT WINDOWS/OPENINGS ARE REQUIRED IF FRAMING IS NOT DEEP ENOUGH TO PROVIDE CLOSURE AT THE BACKSIDE OF MASONRY FOR AN EFFECTIVELY SEALED JOINT.
- MATERIALS ABOVE CANOPIES & AWNINGS TO BE CONTINUED DOWN BEHIND THEM U.O.N., TYP.
- ANY EXPOSED ROOFING MEMBRANE VISIBLE FROM A PUBLIC RIGHT AWAY MUST MATCH THE PRIMARY WALL MATERIAL COLOR.
- 8. INSTALL VERTICAL EXPANSION JOINTS PER STRUCTURAL OR MINIMAL AT COLUMNIGRID LINES AND AT THE HEAD OF DOOR JAMBSJOPENINGS OR AS OTHERWISE NOTED OR WHERE REQUIRED PER STANDARD MATERIAL PRACTICE TO REDUCE STRESS CRACKING. NO CONTROL JOINT/EXPANSION JOINT AT MAIN STRUCTURAL BEARING LOCATIONS. VERIFY JOINTS WITH ARCHITECT. INSTALL BRICK EXPANSION JOINT AT ALL INSIDE CORNERS.
- CAULK & SEAL ALL TRANSITION-CONTROL-EXPANSION AT ALL EXTERIOR MATERIALS.
- 10. INSULATE AND SEAL TO ENSURE ADEQUATE AIR INFILTRATION BARRIER AROUND ALL EXTERIOR PENETRATIONS TO PREVENT WATER AND SPRINKLER PIPE FREEZING.
- 11. WHERE EXTERIOR PAVING ADJACENT TO BUILDING, TOP OF PAVING TO BE 1/4\*
  LOWER THAN INTERIOR FINISH FLOOR, SLOPING CONTINUOUSLY AWAY FROM
  BUILDING A MINIMUM OF 5: WHERE BOOR STOOP, 46" OUT FROM DOOR 1:48(25)
  MAX. SLOPE, AFTER 46" AWAY FROM DOOR 1:20(5%) MAXIMUM SLOPE TO PUBLIC
  WAY. (REFER TO CIVIL)
- 12. WHERE NO EXTERIOR PAVING ADJACENT TO BUILDING, TOP OF FINISHED LANDSCAPE A MINIMUM OF 4" BELOW INTERIOR FINISH FLOOR AND 4" BELOW EXTERIOR WALL FLASHING/WEEPS, SLOPING CONTINUOUSLY AWAY FROM BUILDING A MINIMUM OF 5', (REFER TO CIVIL)
- 13. ADDRESS SHALL BE PROVIDED ON STREET SIDE OF BUILDING AND ON MONUMENT SIGN. NUMBERS A MINIMUM 5 INCH CONTRASTING COLOR NUMBERS WITH MINIMUM 1/2" STROKE.
- 14. IF ANY SIGNAGE OR SIGN BASE IS SHOWN IT IS FOR REFERENCE ONLY, FINAL DESIGNS AND/OR ALLOWANCES SHALL BE DETERMINED WITH APPROVED SIGNAGE PERMIT(S).

ACTUAL DETAILS & DIMENSIONS MAY VARY AND ARE SUBJECT TO CHANGE. ALL DRAWINGS ARE SUBJECT TO AUTHORITY HAVING JURISDICTION APPROVAL. SIGNAGE SHOWN DOES NOT REPRESENT ALLOWABLE SIGNAGE PERMITTING/APPROVAL OF ALL SIGNAGE PER CURRENT CITY ORDINANCE BY OTHERS.

	EXTERIOR MATERIAL LEGEND
MAT.	` `
LABEL	MATERIAL DESCRIPTION
BRK-1	FULL BED BRICK, KING SIZE, GLEN GERY WINNETKA, MORTAR: MATCH EXISTING.
CS-1	CAST STONE, 8%8, MATCH EXISTING.
PC-1	PAINTED ACCENT, 8"x8".
RF-1	ASPHALT ROOF SHINGLE, MATCH EXISTING.
RL-1	BRICK ROWLOCK, MATCH BRK-1,
SC-1	BRICK SOLDIER COURSE, MATCH BRK-1.
SD-1	VINYL LAP SIDING, MATCH EXISTING,
TR-1	VINYL TRIM, WHITE, 6" AT WINDOW PERIMETER AND BUILDING CORNERS, 10" AT ACCENT BANDS

# **MISC EXTERIOR MATERIAL FINISHES**

- TYPICAL U.O.N,
  EXPOSED CONCRETE: GRIND SMOOTH & RUB/COAT WITH CEMENT SLURRY.
  EXPOSED LINTELS: GALVANIZED & PAINTED TO MATCH ADJACENT MATERIAL
- ABOVE.
  METAL STAIRS & RAILINGS: GALVANIZED & PAINTED TO MATCH ADJACENT
  MATERIAL
- METAL BALCONIES & RAILINGS: GALVANIZED & PAINTED TO MATCH ADJACENT
- METAL BALCONIES & RAILINGS: GALVANIZED & PAINTED TO MATCH ADJACENT MATERIAL. FASCIA & SOFFIT: METAL PREFINISHED TO MATCH ADJACENT ROOF COLOR, SCUIPPERS, GUTTERS & DOWNSPOUTS: METAL PREFINISHED TO MATCH ADJ. MATERIAL. CAULKS & SEALANTS: COLOR MATCHED TO ADJACENT MATERIAL, HOLLOW METAL MAN DOORS & FRANKES: PAINTED TO MATCH ADJACENT MATERIAL, COLOR.

- LIGHT FIXTURES: METAL PRE-FINISHED HOUSINGS TO MATCH ADJ. OPENING FRAMING.
  MECHANICAL EQUIPMENT: IF NOT SCREENED, COLOR TO MATCH ADJACENT MATCH ADJACENT
- EXTERIOR UTILITY EQUIPMENT: IF ALLOWED, PAINTED TO MATCH ADJACENT MATERIAL

26-UNIT CLUB POLO

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**APARTMENT** 

6201 EP TRUE PKWY WEST DES MOINES, IA POLK COUNTY

Proj. No. SAA Proj. Mgr.

CONSTRUCTION FOR

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21088 TKW Sheet Title

**EXTERIOR ELEVATIONS** 

A-201

# A RESOLUTION OF THE PLANNING AND ZONING COMMISSION NO. PZC-22-079

WHEREAS, pursuant to the provisions of Title 9, Zoning of the West Des Moines Municipal Code, the applicant, and property owner, Polo Club, LLC, requests approval of the Major Modification to Site Plan for the approximately 16.43-acre property located at 6201 EP True Parkway as depicted on the location map included in the staff report. The applicant requests approval to construct a 39,658 square foot 3-story apartment building with 26 dwelling units, and associated site improvements; and

**WHEREAS**, the Major Modification request complies with the findings stated in the applicable provisions of Title 9, the Comprehensive Plan and City Code.

**NOW THEREFORE**, the Planning and Zoning Commission of the City of West Des Moines recommends the City Council approve the Major Modification to Site Plan (MaM-005555-2022), subject to compliance with all the conditions of approval as stated in the staff report, including conditions added at the meeting, and attached hereto as Exhibit "A", if applicable.

PASSED AND ADOPTED on August 22, 2022.

	Jennifer Drake, Chair Planning and Zoning Commission
I HEREBY CERTIFY that the foregoing resolution we Commission of the City of West Des Moines, Iowa, following vote:	
AYES:	
NAYS:	
ABSTENTIONS:	
ABSENT:	
ATTEST:	
Recording Secretary	-