CITY OF WEST DES MOINES STAFF REPORT COMMUNICATION

Meeting Date: May 22, 2023

ITEM: Law Enforcement Center, 250 Mills Civic Parkway – Approve Major Modification to Site Plan to allow construction of a garage extension and additional parking stalls – City of West Des Moines – MaM-005908-2023

Resolution: Approval of Major Modification to Site Plan

Background: Josh Clayworth, Engineering Services, on behalf of the City of West Des Moines, requests approval of the Major Modification to Site Plan for the approximately 1.5-acre property located at 250 Mills Civic Parkway. The project involves the construction of a 2,600 sf garage extension and additional parking stalls on the west side of the facility. Plans also include interior improvements of the former jail area with HVAC equipment improvements. The project has been coordinated with the Parks & Recreation Department to ensure the proposed project does not impact the adjacent disc golf course.

Staff Review & Comment:

• <u>History</u>: This property is the location of the West Des Moines Law Enforcement Center; per the County Assessor's site, constructed in 1991.

Key Development Aspects:

- 1. Roof Ladders: The City has discouraged roof ladders to be permanently mounted elements on the exterior of buildings. The applicant has requested the allowance for a permanent exterior roof ladder access due to security issues as an interior ladder access would be located in the evidence room which cannot have non-police personnel having access to the room. Based off the security issues, staff believes that the applicant's concerns are sufficient to allow for the exterior roof ladder. Staff has requested that the ladder be finished in the same color as the exterior in order for it to blend in.
- 2. Landscape Islands and Tree Diamonds: Landscape islands shall be placed, at minimum, every eighteen (18) stalls within a row of parking. Tree diamonds within a row of parking shall be evenly spaced between landscape islands, however, shall be spaced no farther than nine (9) parking stalls from another landscape pod or island. The required incorporation of landscape islands and tree diamonds within the off-street parking field have been achieved by using the green strip between the new and existing parking area.
- 3. MidAmerican Overhead Utility Easement: There is an existing one hundred fifty (150) ft MidAmerican overhead utility easement that the proposed parking on the west side encroaches into. The easement prohibits construction of buildings, structures, plants or other objects within the easements. The project manager coordinated with MidAmerican (owner of the transmission lines) and was advised that MidAmerican will allow parking within their easements, but the parking and other improvements must be twenty-five (25) feet away from the face of any structures within the easement.
- <u>Traffic Impact Study Findings</u>: No anticipated impacts from the proposed project improvements, thus, no traffic impact study was done for this project.
- <u>Vesting of Entitlement</u>: Per City Code, entitlement (approval to construct or implement) shall remain
 in effect so long as substantial site work has progressed beyond grading and completion of
 structural foundations and twenty-five percent (25%) of the total building area has occurred above
 grade within twenty-four (24) months of the effective date of the approval, unless a greater time
 period is authorized at time of the original entitlement, or by approval of an extension of the original

entitlement. It is the responsibility of the developer to be aware of this deadline and request an extension of the approval prior to the expiration date.

Outstanding Issues: There are no outstanding issues.

Planning and Zo	oning Commission Action
Date:	May 22, 2023
Vote:	

Recommendation:

Recommendation: Approve the Major Modification to Site Plan request, subject to the applicant meeting all City Code requirements, and the following conditions of approval:

- 1. The Applicant shall provide a final Stormwater Management Plan prior to proceeding to City Council.
- 2. The Applicant shall provide a final Stormwater Pollution Prevention Plan prior to proceeding to City Council.

Lead Staff Member: Kate Devine

Approval Meeting Dates:

Tippi o tali incoming Dates.	
Planning and Zoning Commission	May 22, 2023
City Council	

Staff Report Reviews:

Planning & Zoning Commission	☑ Development Coordinator (or)☑ Director	⊠ Legal Department
City Council	□ Director	□ Legal Department
	☐ Appropriations/Finance	☐ Agenda Acceptance

Publications (if applicable)

Published In:	Des Moines Register Community Section
Date(s) Published	n/a
Date(s) of Mailed Notices	n/a


Council Subcommittee Review (if applicable)

Subcommittee	Developme	ent & Plan	ning
Date Reviewed	2/20/23		
Recommendation	⊠ Yes	□ No	□ Split

Location Map



Vicinity Map – Land Uses

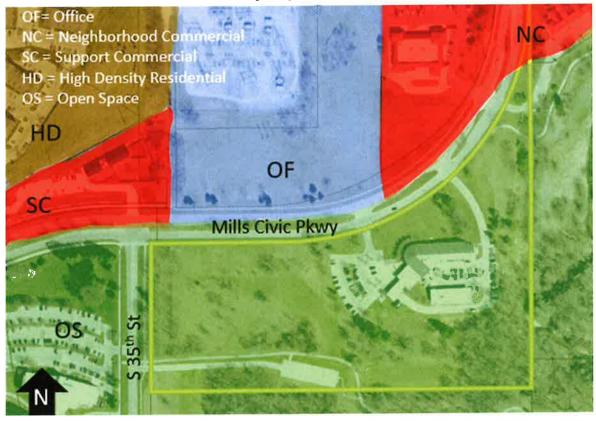

A RESOLUTION OF THE PLANNING AND ZONING COMMISSION

NO. PZC-23-031

WHEREAS, pursuant to the provisions of Title 9, Zoning of the West Des Moines Municipal Code, the applicant, and property owner, City of West Des Moines, request approval of the Major Modification to Site Plan for the approximately 1.5-acre property located at 250 Mills Civic Parkway as depicted on the location map included in the staff report. The applicant requests approval to allow construction of a garage extension and additional parking stalls, and associated site improvements; and

WHEREAS, the Major Modification to Site Plan request complies with the findings stated in the applicable provisions of Title 9, the Comprehensive Plan and City Code.

NOW THEREFORE, the Planning and Zoning Commission of the City of West Des Moines recommends the City Council approve the Major Modification to Site Plan (MaM-005908-2023), subject to compliance with all the conditions of approval as stated in the staff report, including conditions added at the meeting, and attached hereto as Exhibit "A", if applicable.

Andrew Conlin, Chair

PASSED AND ADOPTED on May 22, 2023.

Recording Secretary

Planning and Zoning Commission
I HEREBY CERTIFY that the foregoing resolution was duly adopted by the Planning and Zoning Commission of the City of West Des Moines, Iowa, at a regular meeting on May 22, 2023, by the following vote:
AYES:
NAYS:
ABSTENTIONS:
ABSENT:
ATTEST:

City of West Des Moines (0510-027-2022)


City of West Des Moines (0510-027-2022) Law Enforcement Center Garage Conversion &

HVAC Improvements

250 Mills Civic Pkwy West Des Moines, IA 50265




PROJECT IMAGE

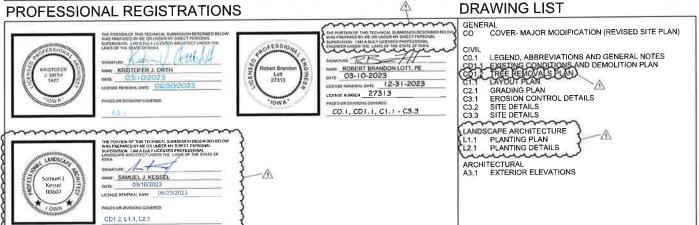

PROJECT NO.:0221006.00

DATE: 03/10/2023

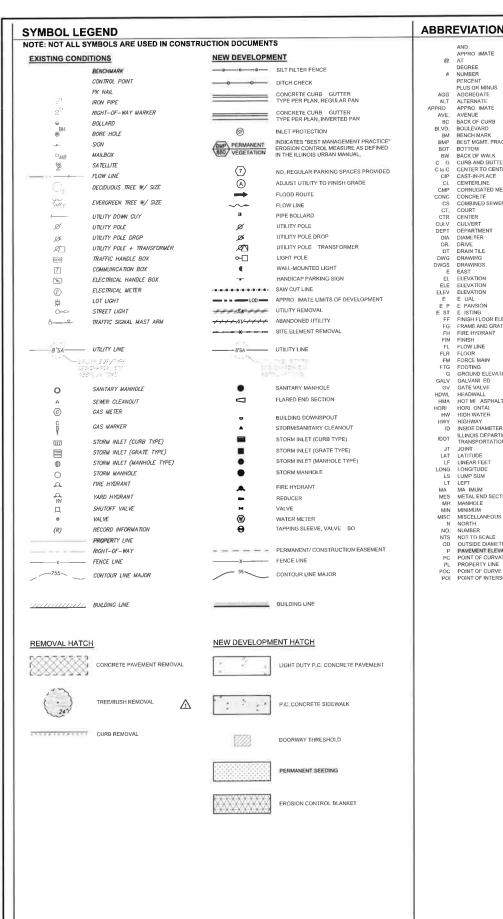

ABBREVIATIONS

AGG AGGREGATE
ALT ALTERNATE
PPRO APPRO IMATE
AVE AVENUE
BC BACK OF CURB

BOULEVARO

BW BACK OF WALK

DEPT DEPARTMENT
DIA DIAMETER
DR. DRIVE
DT DRAINTILE

DWG DRAWING

DWGS DRAWINGS
E EAST
EL ELEVATION

BM BENCH MARK
BMP BEST MGMT PRACTICE
BOT BOTTOM

CURB AND GUTTER CENTER TO CENTER CAST-IN-PLACE

E E UAL
E P E PANSION
E ST E ISTING
FF FINISH FLOOR ELEVATION

FG FRAME AND GRATE

G GROUND ELEVATION

FLOW LINE

GALV GALVANI ED
GV GATE VALVE
HDWL HEADWALL
HMA HOT MI ASPHALT
HORI HORI ONTAL
HW HIGH WATER
HWY HIGHWAY

ID INSIDE DIAMETER

JT JOINT
LAT LATITUDE
LF LINEAR FEET

IDOT ILLINOIS DEPARTMENT OF TRANSPORTATION

LF LINEAR FEET
LONG LONGITUDE
LS LUMP SUM
LT LEFT
MA MA IMUM
MISS METAL END SECTION
MH MANHOLE
MIN MINIMUM
MISC MISCELLANEOUS
N NORTH
NO, NUMBER
NTS NOT TO SCALE
OD OUTSIDE DIAMETER
P PAVEMENT ELEVATION
POR PO POINT OF CURVATURE

POINT OF CURVATURE

PROPERTY LINE

POC POINT OF CURVE
POI POINT OF INTERSECTION

FM FORCE MAIN FTG FOOTING

GENERAL NOTES:

GENERAL NOTES

- I. ALL WORK SHALL BE IN CONFORMANCE WITH:

 1.A. THE APPLICABLE SECTIONS OF THE IOWA DEPARTMENT OF TRANSPORTATION
 STANDARD SPECIFICATIONS OF THE IOWA DEPRICE CONSTRUCTION, LATEST
 PROBLEMENTAL SPECIFICATIONS, DEVELOPMENTAL SPECIFICATIONS, AND APPLICABLE
 SUPPLEMENTAL SPECIFICATIONS, DEVELOPMENTAL SPECIFICATIONS, AND
 SPECIAL REPOVISIONS.
- 1.B. THE MOST RECENT EDITION OF THE SUDAS STANDARD SPECIFICATIONS.
- 1.8. THE MOST RECENT EDITION OF THE SUDAS STANDARD SPECIFICATIONS.

 CONTRACTOR SHALL HAVE THE RESPONSIBILITY TO LOCATE AND PROTECT ALL UNDERGROUND FACILITIES UTILITIES DUTING CONSTRUCTION OPERATIONS. ANY DAMAGE TO ANY UTILITIES SHALL BE PROMPTLY REPORTED TO THE OWNER, REPAIRS SHALL BE THE RESPONSIBILITY OF THE CONTRACTOR. THE UNDERGROUND UTILITIES SHOWN HEREIN ARE APPRO IMATE AND BASED ON THE ACTUAL LOCATION OF SUBFACE STRUCTURES AND PLANS PROVIDED BY THE OWNER, THE IMPURIED PRESENCE OR ABSENCE OF UTILITIES IS NOT TO BE CONSTRUED BY THE OWNER, REQUIRED AND ABOVE AND TO BE CONSTRUED BY THE OWNER, CONTRACTOR, OR SUBCONTRACTORS TO BE AN ACCURATE AND COMPLETE REPRESENTATION OF UTILITIES IS NOT TO BE CONSTRUCTION SHEE, BURSTED AND ABOVE GROUND UTILITY LOCATION, IDENTIFICATION, AND MARKING IS THE SOLE RESPONSIBILITY OF THE CONTRACTOR, REPOUTING, DISCONNECTION, PROTECTION, FEC, OF ANY UTILITIES MUST BE COORDINATED BETWEEN THE CONTRACTOR, UTILITY COMPANY, AND OWNER, SITE SAFETY, INCLUDING THE ACCURACY OF MAIN AND OWNER. SHE SOLE RESPONSIBLE FOR PROTECTING UTILITY PROPERTY FROM CONSTRUCTION OF THE CONTRACTOR. THE CONTRACTOR SHALL BE RESPONSIBLE FOR PROTECTING UTILITY PROPERTY FROM CONSTRUCTION OF CONTRACTORS.
- THE CONTRACTOR SHALL FURNISH, ERECT, AND MAINTAIN MARKINGS AND THE CONTRACTOR SMALL FURNISH, ERECT, AND MAININ AN MANINI AN MANINI AND ANALYSIS AREA ASSOCIATED A SALL ARD ATHER ASSOCIATED A SOLITED A SOLITED A SOLITED AS RE UIRED FOR OPEN TRENCHES, E CAVATIONS. TEMPORARY STOCK PILES, AND PARKED FOR DENSTRUCTION E. UPMENT THAT MAPPOSE A POTENTIAL A ARD AS PART OF THE DAILY OPERATIONS AT THIS SITE. CONTRACTOR IS SOLICLY RESPONSIBLE FOR SITE SAFETY.
- CONTRACTOR SHALL CONTINUOUSLY COMPARE ALL LINES, GRADES, AND OTHER INFORMATION APPEARING ON THE PLANS WITH THE ACTUAL LINES, GRADES, AND SITE CONDITIONS. ANY DISCREPANCIES THAT MAY AFFECT THE PERFORMANCE OF THE WORK IN ACCORDANCE WITH THE INTENT OF THE CONTRACT DOCUMENTS SHALL BE IMMEDIATELY REPORTED TO THE COWNER AND ENGINEER IN WITHING FOR DISPOSITION BEFORE CONTRACTOR PROCEEDS WITH THE WORK. CONTRACTOR SHALL HAVE PLUL RESPONSIBILITY FOR ITHE WORK COMPLETE DPRIOR TO THE REPORT TO THE OWNER AND ENGINEER, AND NO ADDITIONAL COMPENSATION WILL BE ALL LOWED FOR CORRECTION OF THE WORK PRIOR TO THE REPORT TO THE
- CONTRACTOR PARKING AND LAYDOWN AREAS SHALL BE COORDINATED WITH THE
- PRIOR TO PERFORMING ANY WORK IN OR ON THE RIGHT OF WAY OF ANY CITY OR STATE ROADWAY, THE CONTRACTOR SHALL NOTIFY THE CITY STATE TRAFFIC ENGINEER'S OFFICE. THE CONTRACTOR SHALL ERECT WARNING SIGNS AND BARRICADES TO PROTECT THE TRAVELING PUBLIC AND HIS WORKERS, THE SIGNING AND BARRICADING SHALL CONFORM TO THE APPROPRIATE APPLICATIONS OUTLINED IN THE MANULA, OF UNIFORM TRAFFIC CONTROL DEVICES OR AS OTHERWISE DIRECTED BY THE CITY STATE TRAFFIC ENGINEER. IF PERMITS ARE HE URED TO CONDUCT THE WORK. THE CONTRACTOR SHALL SECURE THE PERMITS AND SUPPLY THEM TO THE CONSIDER, AND CONSTRUCTION ADJACENT TO PAYMENT SHALL BE CODE THE PERMITS AND SUPPLY PARTIAL LANG CLOSURES, AND CONSTRUCTION ADJACENT TO PAYMENT SHALL BE DENTIFIED, SIGNED, AND BARRICADES ERECTED IN CONFORMANCE WITH THE DENTIFIED, SIGNED, AND BARRICADES ERECTED IN CONFORMANCE WITH THE DENTIFIED, SIGNED, AND BARRICADES ERECTED IN CONFORMANCE WITH THE DENTIFIED, SIGNED, AND BARRICADES ERECTED IN CONFORMANCE WITH THE PRIOR TO PERFORMING ANY WORK IN OR ON THE RIGHT OF WAY OF ANY CITY OR CABLE ARTICLES OF SECTION 01 OF THE STANDARD SPECIFICATIONS AND TH MUNICIPALITY'S RE UIREMENTS.
- CONTRACTOR SHALL REMOVE EARTHEN MATERIALS, E. ISTING SURFACES, AND STRUCTURES AS RE. UIRED, ALL WASTE MATERIAL SHALL BE PROPERLY DISPOSED OFF-SITE AND SHALL BE INCIDENTAL TO THE CONTRACT.
- THE CONTRACTOR IS RESPONSIBLE FOR OBTAINING ALL NECESSARY PERMITS, UNLESS NOTED. THIS WILL INCLUDE BUT NOT BE LIMITED TO BUILDING PERMIT AND IOWAN P.D.E.S PERMIT, THE CONTRACTOR SHALL PROVIDE ANY FINANCIAL SURETIES RE UIRED AS PART OF ANY PERMIT.
- CONTRACTOR SHALL BE RESPONSIBLE FOR PREPARING AND SUBMITTING UTILITY AS BUILT DRAWINGS TO THE OWNER AND ENGINEER AT EACH RESPECTIVE UTILITY COMPLETION, AND WITHIN 14 DAYS OF RECEIPT OF THE CERTIFICATE OF SUBSTANTIAL COMPLETION,
- 19. CONSTRUCTION STAKING, LAYOUT, AND GRADING SHALL BE THE RESPONSIBILITY OF THE CONTRACTOR USING THE BASIC TOPOGRAPHIC SURVEY CONTROLS PROVIDED IN THE PLANS, CONTRACTOR SHALL VERIFY SURVEY CONTROLS PRIOR TO BEGINNING CONSTRUCTION. ANY DISCREPANCIES IN THE SURVEY CONTROLS SHALL BE REPORTED TO THE OWNER AND ENGINEER PRIOR TO CONSTRUCTION. ANY ADDITIONAL SURVEY CONTROLS ARE URED FOR CONSTRUCTION. SHALL RESPONSIBILITY OF THE CONTRACTOR.
- CONTRACTOR SHALL COORDINATE ALL UTILITY LINE CROSSINGS TO ENSURE ALL PIPES MAINTAIN MINIMUM COVER, MINIMUM CLEARANCES, AND PROPER SEPARATION, GRAVITY LINES SHALL HAVE PRECEDENCE OVER PRESSURI ED LINES
- CONTRACTOR SHALL SUBMIT SHOP DRAWINGS FOR ALL ITEMS INCORPORATED INTO THE WORK FOR ENGINEER REVIEW AND APPROVAL A MINIMUM OF 2 WEEKS PRIOR
- 13. REFERENCES TO "INSPECTION" OR "INSPECTOR" IN THE SPECIFICATIONS SHALL NO CREATE, IMPOSE, OR GIVE RISE TO ANY DUTY OWED BY THE OWNER OR ENGINEER TO THE CONTRACTOR, ANY SUBCONTRACTOR, OR ANY SUPPLIER.
- 14. WHERE SECTION, SUB-SECTION, SUBDIVISION, OR PROPERTY MONUMENTS ARE ENCOUNTERED, THE OWNER'S REPRESENTATIVE SHALL BE NOTIFIED BEFORE SUC MONUMENTS ARE REMOVED. THE CONTRACTOR SHALL PROTECT AND PRESERVE ALL PROPERTY MARKERS UNTIL AN OWNER OR AUTHOR! ED SURVEYOR HAS WITNESSED OR REFERENCED THEIR LOCATION.
- 15. CONTRACTOR SHALL COORDINATE WITH UTILITY COMPANIES PRIOR TO ANY WORK I AND AROUND UTILITY-OWNED INFRASTRUCTURE AND MAKE THEM AWARE OF WORK
- 16. ANY SIDEWALKS, FENCES, AND OTHER ITEMS NOT SHOWN TO BE REMOVED, BUT DAMAGED DURING CONSTRUCTION, SHALL BE REPAIRED BY THE CONTRACTOR AT NO COST TO THE OWNER. ALL EARTHWORK, GRADING AND BACKFILLING SHALL BE DONE IN ACCORDANCE WIT
- THE RECOMMENDATIONS PROVIDED IN THE "SUBSURFACE E PLORATION, LEC GARAGE PARKING ADDITIONS", DATED SEPTEMBER 30, 2022, BY TEAM SERVICES
- 18. THE GENERAL CONTRACTOR, AND ALL SUBCONTRACTORS ARE RESPONSIBLE FOR VERIFYING ALL E. ISTING CONDITIONS AND BECOMING FAMILIAR WITH ALL CONSTRUCTION DOCUMENTS.
- PRIOR TO ANY E. CAVATION CONTRACTORS SHALL CALL THE TOLL FREE IOWA ONE CALL NUMBER 1-600-292-8989.

SITE DEMOLITION NOTES:

- ILE ISTING UTILITIES TO REMAIN, WHICH ARE DAMAGED BY THE CONTRACTOR DURING CONSTRUCTION, SHALL BE REPARED AND/OR REPLACED WITHOUT ADDITIONAL COMPENSATION, CONFLICTS WITH PROPOSED CONSTRUCTION AND UTILITIES TO REMAIN ARE TO BE ROUGHT TO THE IMMEDIATE ATTENTION OF THE CONSTRUCTION MANAGET FOR COORDINATON WITH THE OWNER'S REPRESENTATIVE ENGINEER AND UTILITY COMPANY
- 3. ALL PAVEMENT TO BE REMOVED SHALL BE SAWCUT FULL DEPTH
- 4. CONTRACTOR SHALL EMPLOY ALL MEASURES NECESSARY DURING DEMOLITION TO CONTROL EROSION AND INSURE THAT SEDIMENT DOES NOT LEAVE THE SHE. TRACKING OF DIRT ONTO PUBLIC STREETS AND ALLEYS SHALL BE CLEANED IMMEDIATELY, AND ALL SEDIMENT AND EROSION CONTROL ITEMS SHALL BE INSTALLED PRIOR TO CLEARING AND DEMOLITION WORK.

- CONTRACTOR IS RESPONSIBLE FOR VERIFYING E ISTING SITE CONDITIONS AND RECOMING FAMILIAR WITH ALL CONSTRUCTION DOCUMENTS.
- ITEMS INDICATED TO BE REMOVED SHALL BE COMPLETELY REMOVED UNLESS INDICATED OTHERWISE, AND BACKFILLED IN ACCORDANCE WITH THE GEOTECHNICAL REPORT.
- ITEMS INDICATED TO BE SALVAGED SHALL BE CAREFULLY REMOVED AND STORED IN A LOCATION DESIGNATED BY THE OWNER.
- ALL TREES AND BRUSH INDICATED TO BE REMOVED SHALL BE REMOVED COMPLETELY, INCLUDING ROOT BALLS.
- CONTRACTOR SHALL FULLY PROTECT ALL SURROUNDING PROPERTIES FROM ANY AND ALL DAMAGE DURING DEMOLITION OPERATIONS AND SHALL BE FULLY RESPONSIBLE FOR REPAIRING (TO A CONDITION ACCEPTABLE TO THE OWNER AND ARCHITECT) ANY AND ALL DAMAGE THAT DOES OCCUR.
- CONTRACTOR SHALL BE FULLY RESPONSIBLE FOR THE SAFETY AND SECURITY OF THE PROJECT SITE AND ITS SURROUNDINGS DURING DEMOLITION OPERATIONS.
- ALL DEMOLISHED E ISTING MATERIALS, SYSTEMS, AND CONSTRUCTIONS SHALL BE DISPOSED OF IN A LAWFUL MANNER, AND WRITTEN RECORDS OF THE FINAL DESTINATION FOR THESE MATERIALS, SYSTEMS, AND CONSTRUCTIONS (INCLUDING ANY IDENTIFIED HA ARDOUS ITEMS) SHALL BE PROVIDED TO THE OWNER AND
- E ISTING SITE SHALL BE CLEANED ON A DAILY BASIS THROUGHOUT THE DURATION OF DEMOLITIONS OPERATIONS. AND NO DEBRIS OR PRODUCTS OF DEMOLITION SHALL BE ALLOWED TO ACCUMULATE OUTSIDE THE BOUNDARIES OF THE SITE.
- CONTRACTOR SHALL FULLY COORDINATE ALL PROJECT DEMOLITION OPERATIONS.

SITE LAYOUT NOTES:

- JOINTS IN SIDEWALK (TOOLED AND/OR SAWED) SHALL BE AT 5' MA INTERVALS, UNI ESS INDICATED OTHERWISE.
- HING-EASTING COORDINATES AND DIMENSIONS FOR CURB AND GUTTER ARE
- WHEN CONCRETE IS PLACED ABUTTING STRUCTURES, FOUNDATIONS OR E. ISTING SIDEWALKS, A BOND BREAKER CONSISTING OF 12° P.J.F., AND ELASTOMERIC JOINT SEALANT SHALL BE USED FULL DEPTH LINLESS OTHERWISE NOTED,
- MA IMUM CONTRACTION JOINT SPACING ON CONCRETE CURB AND GUTTER OR CONCRETE GUTTER SHALL NOT E. CEED 25',
- ALL SIDEWALKS SHALL BE 4 INCHES IN THICKNESS AND CONSTRUCTED TO THE WIDTH SHOWN ON THE PLANS, ALL SIDEWALKS SHALL BE CONSTRUCTED WI MIN, CROSS SLOPE OF 1 AND A MA CROSS SLOPE OF 2
- CONTRACTOR IS RESPONSIBLE FOR VERIFYING E ISTING SITE CONDITIONS AND BECOMING FAMILIAR WITH ALL CONSTRUCTION DOCUMENTS.
- SEE ARCHITECTURAL PLANS FOR E ACT BUILDING DIMENSIONS AND DOOR
- CONTRACTOR SHALL COORDINATE E UIPMENT PADS WITH E UIPMENT

SITE GRADING AND EROSION CONTROL NOTES:

- ALL EARTHWORK, GRADING AND BACKFILLING SHALL BE DONE IN ACCORDANCE WIT THE RECOMMENDATIONS PROVIDED IN THE "SUBSURFACE E PLORATION, LEC GARAGE PARKING ADDITIONS" DATED SEPTEMBER 30, 2022, BY TEAM SERVICES
- ENGINEERED STRUCTURAL FILLS SHALL BE INCLUDED IN OVERALL SITE ENSINEERED STRUCTURAL FILLS SHALL BE INCLUDED IN OVERALL SITE
 DEVELOPMENT TO PROVIDE ADE LIATE STRUCTURAL SUPPORT FOR THE FLOOR
 SLABS ON GRADE AND ADJOINING PAVEMENT AREAS, REFER TO THE
 GEOTECHNICAL REPORT FOR APPROVED FILL MATERIALS AND COMPACTION
 BE INDEMENTS
- ALL VEGETATIVE AND STRUCTURAL EROSION CONTROL PRACTICES SHALL BE THE RESPONSIBILITY OF THE CONTRACTOR AND SHALL BE CONSTRUCTED AND MAINTAINED IN ACCORDANCE WITH THE MINIMUM STANDARDS AND SPECIFICATIONS OF THE SUDAS SPECIFICATION MANUAL.
- THE CONTRACTOR SHALL BE SOLELY RESPONSIBLE FOR THE INSTALLATION, ALL INSPECTIONS, AND MAINTENANCE OF ALL EROSION CONTROL FACILITIES UNTIL FINAL STABILL ATION OF ALL AREAS DISTURBED BY CONSTRUCTION OCCURS.
 MAINTENANCE AND REPLACEMENT OF EROSION CONTROL ITEMS SHALL BE CONSIDERED AS INCIDENTAL TO THE CONTRACT
- ALL AREAS DISTURBED BY CONSTRUCTION ACTIVITY MUST BE SEEDED, SODDED, BLANKETED OR OTHERWISE PROTECTED WITHIN 14 DAYS OF FINAL DISTURBANCE, SEEDING, FERTIL ATION AND MULCH SHALL BE IN ACCORDANCE WITH THE SUDAS SPECIFICATION MANUAL. ALL AREAS DISTURBED BY THE CONTRACTOR DURING THE CONSTRUCTION OF THIS PROJECT WHICH ARE LOCATED OUTSIDE OF THE PROPOSED SEEDING LIMITS SHALL BE GRADED TO DRAIN, FERTILL ED, SEEDED, AND MULCHED. THE COST ASSOCIATED WITH THE PLACEMENT OF ADDITIONAL FERTILL ER, SEED, AND MULCH SHALL BE THE RESPONSIBILITY OF THE
- ALL EROSION CONTROL MEASURES SHOWN ON THE PLAN ARE THE MINIMUM MEASURES RE UIRED. UNFORESEEN CHANGES IN SCOPE, SCHEDULE OR CONSTRUCTION METHODS MAY RESULT IN CHANGES OR ADDITIONS TO THIS PLAN AND THE SWPPP. ANY CHANGES OR ADDITIONS NECESSARY TO MAINTAIN E SYMPPE, MINT CHANGES OR ADDITIONS RECESSARY TO MAINTAIN ANCE WITH THE IOWA NPDES PERMIT SHALL IMMEDIATELY BE BROUGHT TO THE ATTENTION OF THE OWNER.
- SHOULD PROJECT SCHEDULING PROHIBIT THE ABILITY TO SEED DISTURBED EART UPON COMPLETION OF GRADING, CONTRACTOR SHALL EMPLOY ALTERNATE SOUR CONTROLS IN ADDITION TO THOSE ON THIS PLAN, INCIDENTAL TO THE CONTRACT.
- DUST CONTROL MUST BE PROVIDED AS NEEDED, BY WATERING OR OTHER MEAN.
- IO. CONTRACTOR IS RE UIRED TO PROVIDE AND USE A CONCRETE WASHOUT AREA FOR RINSING CONCRETE TRUCKS
- CONTRACTOR SHALL PROVIDE AND USE A WHEEL WASH SYSTEM TO ENSURE THE ALL CONSTRUCTION TRAFFIC ENTERING AND E ITING THE SITE MAINTAIN CLEAN TIRES, ANY SEDIMENT TRACERS ONTO ADJACENT ROADWAYS OR PAVED AREAS SHALL BE REMOVED BY THE CONTRACTOR BY THE END OF THE SAME WORK DAY.
- 13. ALL ELEVATIONS SHOWN ARE TO FINISHED PAVEMENT UNLESS SPECIFIED
- 4 SOIL COMPACTION SHALL BE MINIMI ED AS MUCH AS POSSIBLE DURING SITE GRADING. APPROPRIATE MEASURES, INCLUDING BUT NOT LIMITED TO FENCING. SHOULD BE USED TO LIMIT HEAVY E UIPMENT TRAFFIC FROM ACCESSING THE ARE
- 5. THE INTENDED SE UENCE OF SOIL DISTURBING ACTIVITIES ARE AS FOLLOWS:

- CLEARING GRUBBING AND SELECT DEMOLITION AS NECESSARY.
- VISTALLATION OF UTILITIES
- -BUILDING CONSTRUCTION. -PAVING OF SIDEWALKS AND PARKING LOT -FINAL GRADING OF SITE, LANDSCAPING AND RESEEDING OF DISTURBED AREAS.
- ALL EARTHEN AREAS DISTURBED DURING CONSTRUCTION SHALL BE PERMANENTED SEEDED AND EROSION CONTROL BLANKET SHALLE INSTALLED PER SUDAS SPECIFICATIONS IN AREAS SHOWN ON THE EROSION CONTROL PLAN,

SITE UTILITY NOTES:

- REFER TO MECHANICAL, ELECTRICAL AND PLUMBING PLANS FOR UTILITY SERVICE SLES AND ELACT LOCATIONS
- FIELD VERIFY ELEVATIONS AND LOCATIONS OF ALL CONNECTIONS TO E ISTING
- ALL UTILITY TRENCHES UNDER OR WITHIN 2' OF E ISTING OR PROPOSED PAVEMENT, SIDEWALK OR BUILDING SHALL BE BACKFILLED WITH COMPACTED GRANULAR MATERIAL, GRANULAR MATERIAL, GRANULAR MATERIAL, SHEAL SHALL BE IMPORTED UNIES SE ISTING GRANULAR MATERIALS ARE SPECIFICALLY APPROVED BY THE OWNER'S REPRESENTATIVE.
- A MINIMUM HORI, ONTAL SEPARATION OF 10 FEET SHALL BE MAINTAINED BETWEEN ALL WATER MAINS AND SEWERS, IF SEPARATION IS NOT POSSIBLE, WATER MAIN ENCASEMENT SHALL BE RE. LIRED OR THE SEWER SHALL BE CONSTRUCTED OF WATER MAIN, UALITY PIPE.
- WATER MAINS SHALL CROSS ABOVE SEWERS WITH A MINIMUM VERTICAL SEPARATION OF 18 INCHES WHILE STILL MAINTAINING THE RE. UIRED DEPTH OF COVER. IF PROPER SEPARATION IS NOT POSSIBLE, OR IF THE WATER MAIN MUST BE ROUTED UNDER THE SEWER, WATER MAIN ENCASEMENT SHALL BE RE. UIRED OR THE SEWER SHALL BE CONSTRUCTED OF WATER MAIN UALITY PIPE.
- STORM SEWER SHALL BE AS NOTED ON THE PLANS IN CONFORMANCE WITH THE
- A PVC STORM SEWER PIPING, ASTM D 3034, SDR 21 (WATER MAIN, UALITY)
- a BELL-AND-SPIGOT ENDS b ASTM F 4 ELASTOMERIC SEALS FOR GASKETED JOINTS
- B. PVC STORM SEWER PIPING, ASTM D 3034, SDR 35
 - 8 BELL-AND-SPIGOT ENDS b ASTM F 4 , ELASTOMERIC SEALS FOR GASKETED JOINTS

ALL CLEANOUT RIMS SHALL BE CONSTRUCTED FLUSH WITH THE FINISHED GROUND

- CONTRACTOR SHALL COORDINATE ALL UTILITY LINES THAT ENTER THE BUILDING, IN GENERAL, PLUMBING PLANS SHOW ALL INTERIOR BUILDING PIPING AND PIPING UP TO 5-FEET OUTSIDE THE BUILDING, CIVIL PLANS SHOW SITE PIPING BEGINNING FROM 5-FEET OUTSIDE THE BUILDING.
- CONTRACTOR SHALL COORDINATE ALL UTILITY LINE CROSSINGS TO ENSURE ALL PIPES MAINTAIN MINIMUM COVER, MINIMUM CLEARANCES, AND PROPER SEPARATION, GRAVITY LINES SHALL HAVE PRECEDENCE OVER PRESSURI ED LINES.

PROPERTY INFORMATION

PROPERTY OWNER
CITY OF WEST DES MOINES WEST DES MOINES, IA 50265

SITE ADDRESS 250 MILLS CIVIC PKWY WEST DES MOINES, IA 50265

E ISTING PUBLIC SAFETY FACILITY

ONING DISTRICT RS-15 SINGLE FAMILY RESIDENTIAL

- LEC BUILDING 3.5 SPACES PER 1,000 SF (36,150 SF) = 12 SPACES
 GUN RANGE 3.5 SPACES PER 1,000 SF (4,343 SF)
 FOR ACCESSORY USE = 8 SPACES TOTAL RE UIRED = 135 SPACES
- E ISTING SPACES SOUTH AND EAST OF BUILDING = 4 SPACES E ISTING AND PROPOSED SPACES WEST OF BUILDING = 93 SPACES TOTAL SPACES PROVIDED = 16 SPACES

IMPERVIOUS SURFACE TOTAL PROPERTY AREA = 1 .83 ACRES = 6,6 .5 SF EISTING IMPERVIOUS AREA = 104,563 SF IMPERVIOUS SURFACE ADDED = 19,650 SF PAVEMENT = 1 .050 SF BUILDING = 2,600 SF TOTAL IMPERVIOUS AREA = 124,213 SF PERCENTAGE IMPERVIOUS = 16

- PROJECT AREA = 63,525 SF (1,46 AC)



202 IRON ROD

N: 5 1022 356 E: 15 0999 189

ELFV = 126.16

2

BENCHMARK INFORMATION

CONTROL POINTS

200	IRON ROD
l	N: 5 11 6,023
l	E: 15 0612 030
	ELEV - 400 00

PROJECT BENCHMARK

G NAIL EAST SIDE OF LIGHT BASE

CITY OF WEST DES MOINES BENCHMARKS

STANDARD BENCHMARK ON SOUTH 35TH STREET AT THE NORTH ENTRANCE TO SOUTHWOODS PARK, 125.5 FEET (/-) EAST OF THE EAST BACK OF CURB OF SOUTH 35TH STREET, 25.5 FEET SOUTH OF ENTRANCE ROAD.


201 IRON ROD

N: 5 1332.556

E: 15 1165 48 ELEV = 116.0

14 STANDARD BENCHMARK ON SOUTHWEST CORNER OF E.P., TRUE AND S. 41ST STREET, 4.5 FEET SOUTH OF THE EAST-WEST BACK OF WALK AND 4.5 FEET WEST OF THE NORTH-SOUTH BACK OF WALK. ELEV. = 119.48

ELEVATIONS ARE BASED ON WEST DES MOINES VERTICAL DATUM, TO CONVERT TO NGVD, ADD 4,01 TO ELEVATI CITY BENCHMARKS WERE NOT TIED IN TO THIS PROJECT

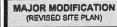

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WALIKEE HOWA 50263

DATE: DESCRIPTION:

03/10/2023 CITY OF WDM COMMENTS 04/04/2023 CITY OF WDM COMMENTS #2

515) 225-3469 / info@f-w.com

City of West Des Moines (0510-02 -2022)

Law Enforcement Center Garage Conversion & HVAC **Improvements**

250 Mills Civic Pkwv

ATE:	01/19/2023
ESIGNED:	TWA
PRAWN:	TWA
REVIEWED:	LM1

IFLD BOOK NO.


FGEND. ABBREVIATIONS AND

GENERAL NOTES

C_{0.1}

0221006.00

PROJECT NO .:

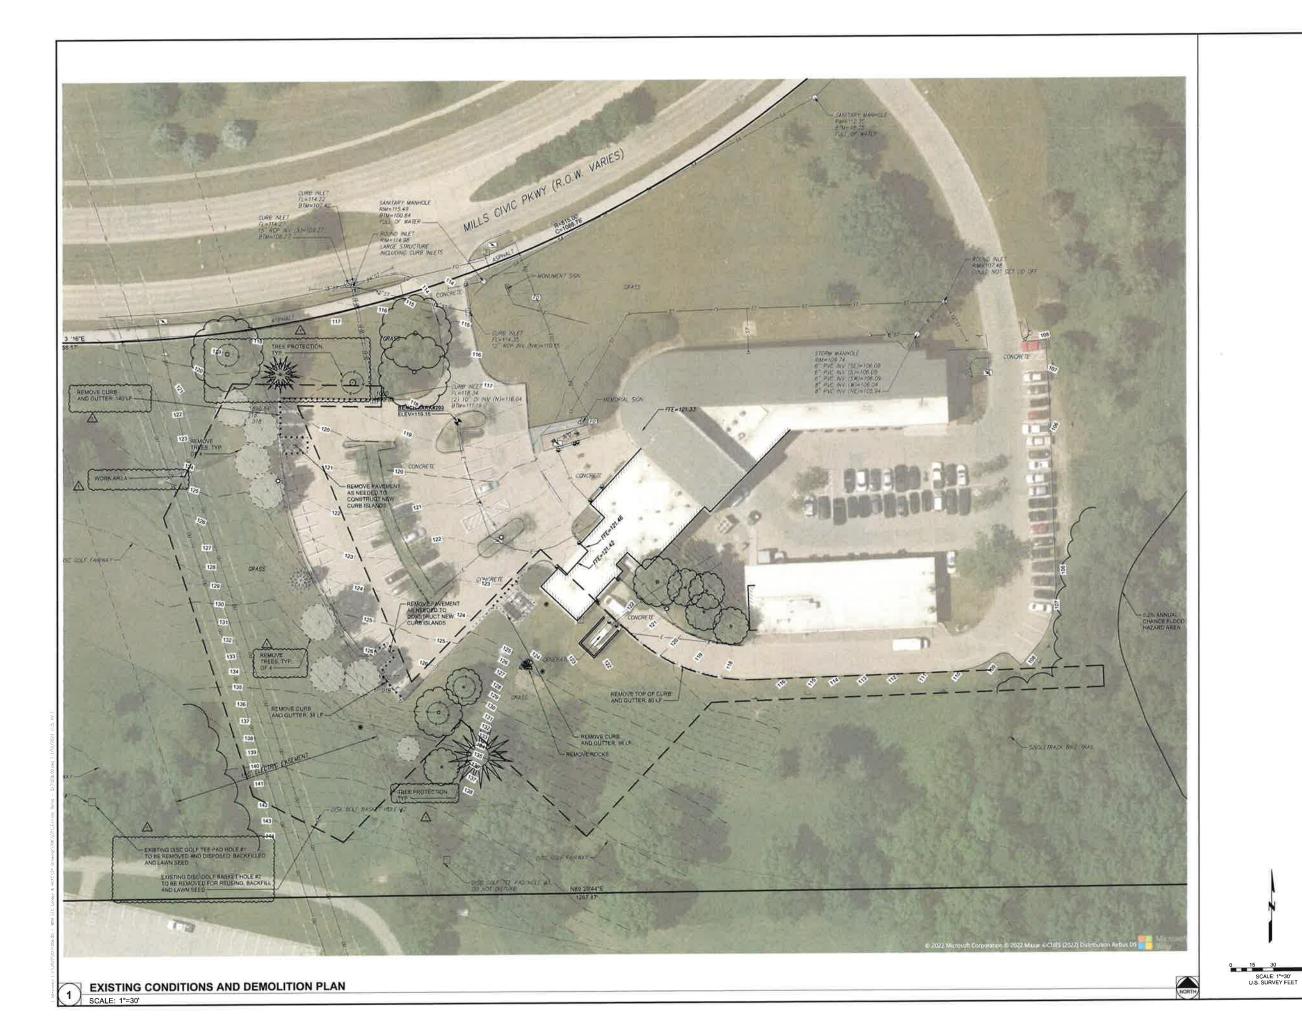



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03/10/2023 CITY OF WDM COMMENT

MAJOR MODIFICATION (REVISED SITE PLAN)

City of West Des Moines

Law Enforcement Center Garage Conversion & HVAC Improvements

250 Mills Civic Pkwy West Des Moines, IA 50265

DATE:	01/19/2023
DESIGNED:	TWA
DRAWN:	TW
REVIEWED:	LM


FIELD BOOK NO .:

EXISTING CONDITIONS AND DEMOLITION PLAN

CD1.1

PROJECT NO ::

0221006.00

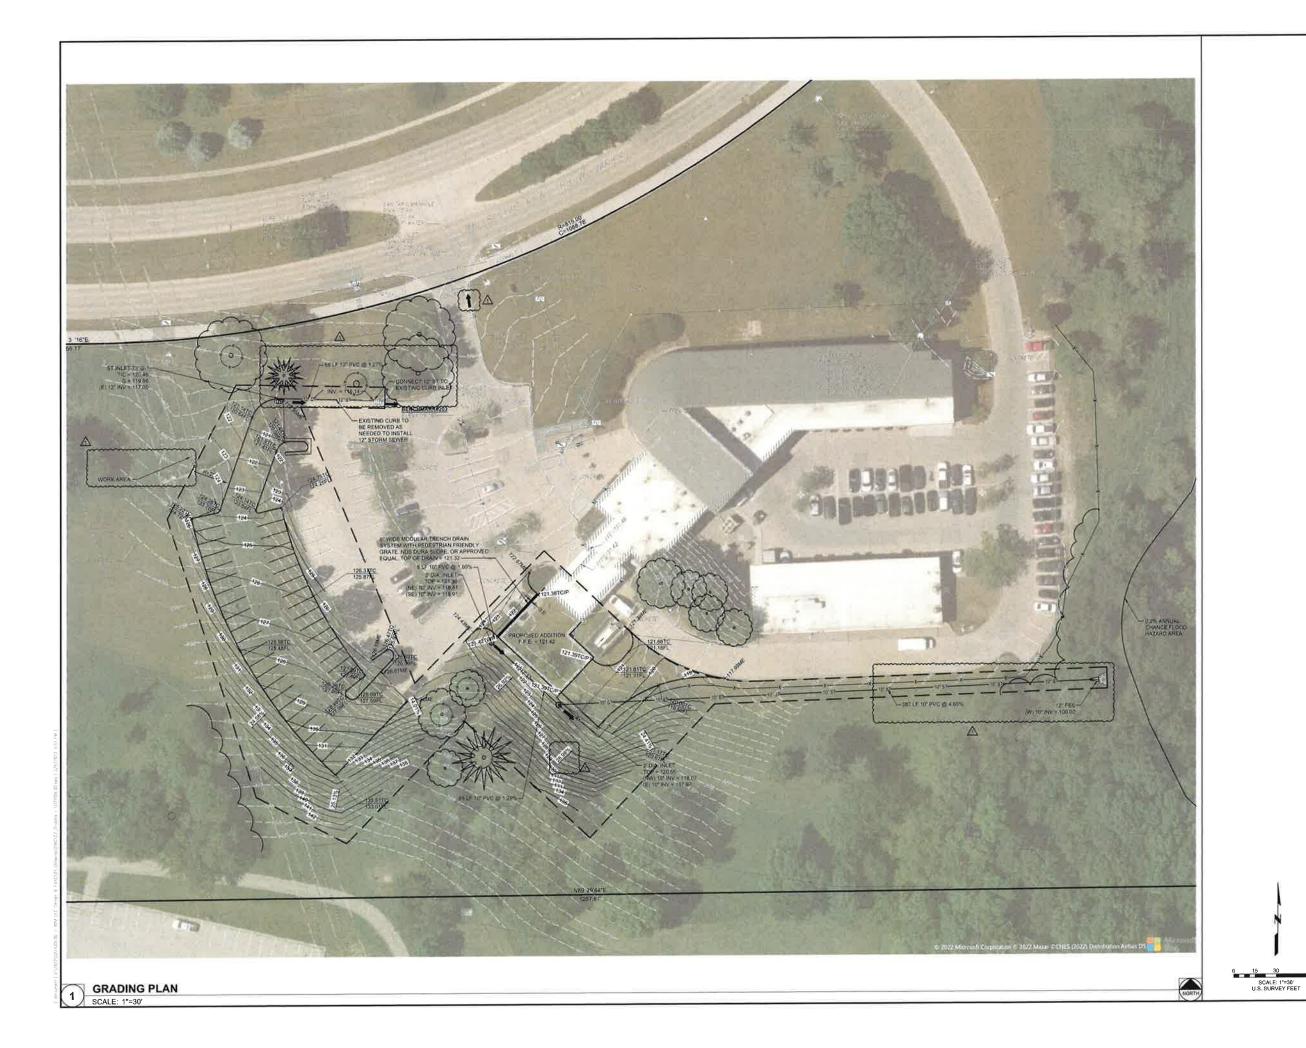



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1 03/10/2023 CITY OF WDM COMMENT

MAJOR MODIFICATION (REVISED SITE PLAN)

City of West Des Moines

Law Enforcement Center Garage Conversion & HVAC Improvements

250 Mills Civic Pkwy West Des Moines, IA 50265


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DESIGNED:	TWA
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REVIEWED:	LM

FIELD BOOK NO :

GRADING PLAN

C2.1

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1 03/10/2023 CITY OF WDM COMMENTS 2 04/04/2023 CITY OF WDM COMMENTS #2

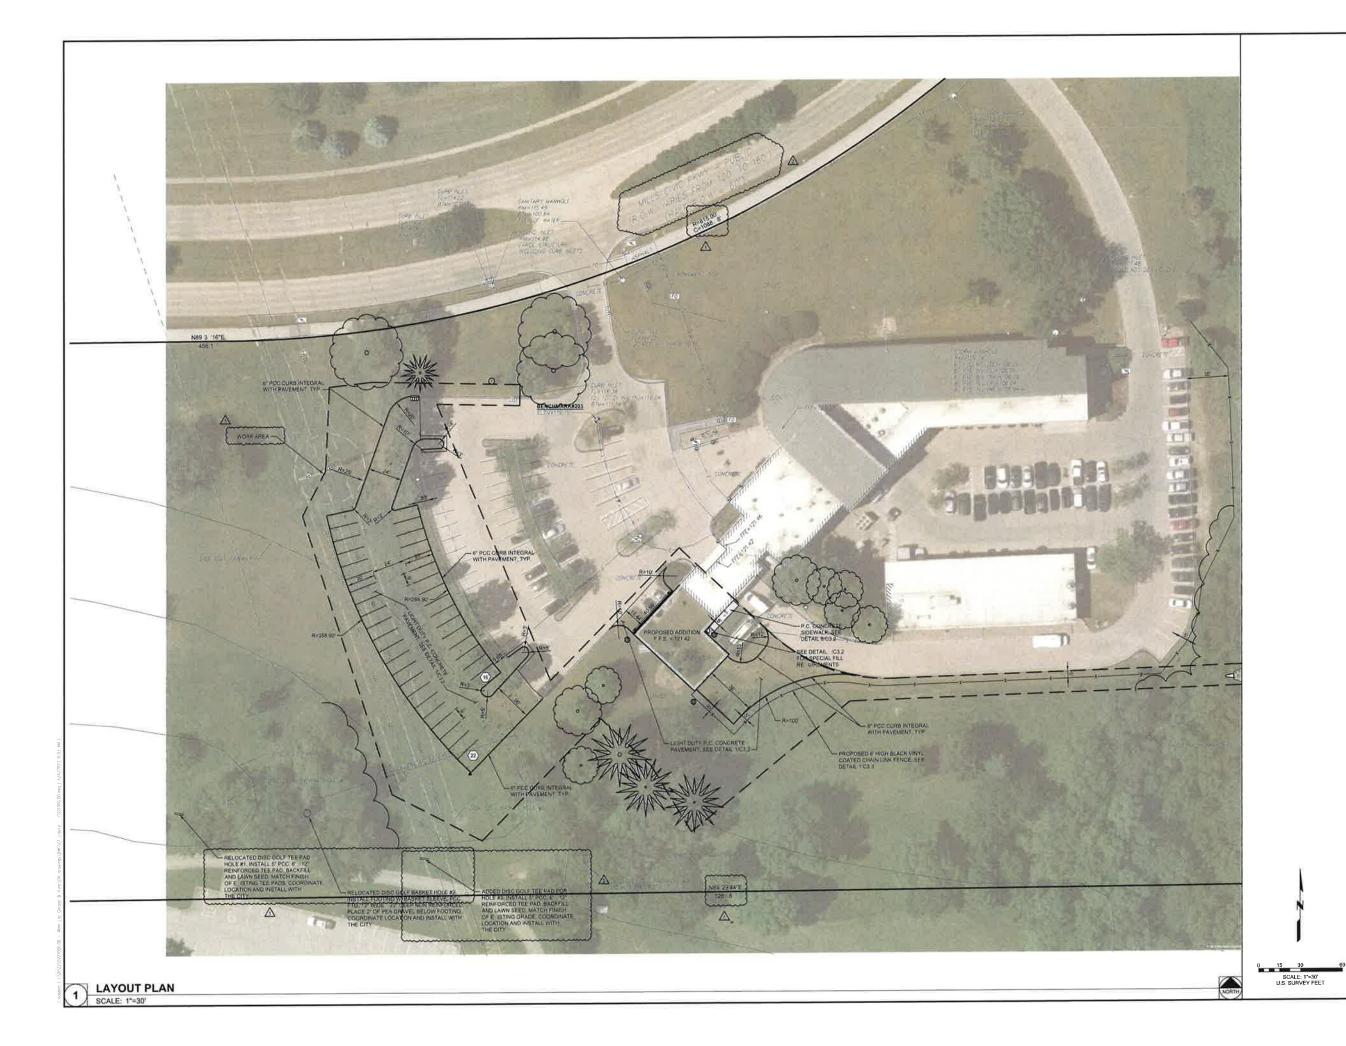MAJOR MODIFICATION (REVISED SITE PLAN)

City of West Des Moines (0510-02 -2022)

Law Enforcement Center Garage Conversion & HVAC Improvements

250 Mills Civic Pkwy West Des Moines, IA 50265


DATE:	01/19/202
DESIGNED:	TW
DRAWN:	TW
REVIEWED:	LM*

FIELD BOOK NO.:

LAYOUT PLAN

C1.1

PROJECT NO.:

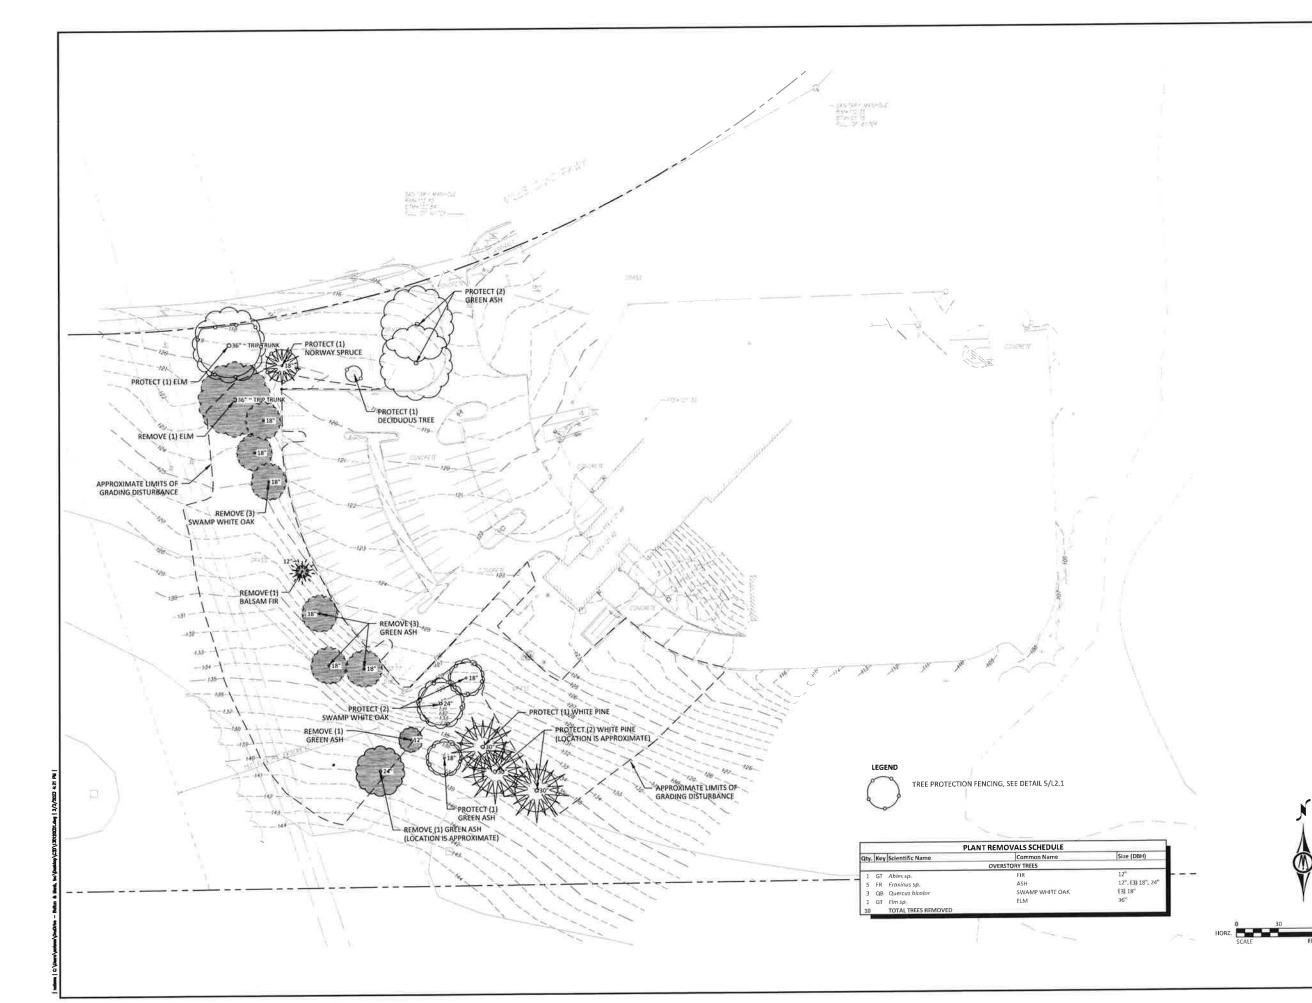



DATE: DESCRIPTION:

MAJOR MODIFICATION

City of West Des Moines

Law Enforcement Center Garage Conversion & HVAC Improvements


250 Mills Civic Pkwy West Des Moines, IA 50265


DATE:	03/10/20:
DESIGNED:	N
DRAWN:	N
REVIEWED:	Ş
FIELD BOOK NO,:	

TREE REMOVALS PLAN

CD1.2

0221006.00

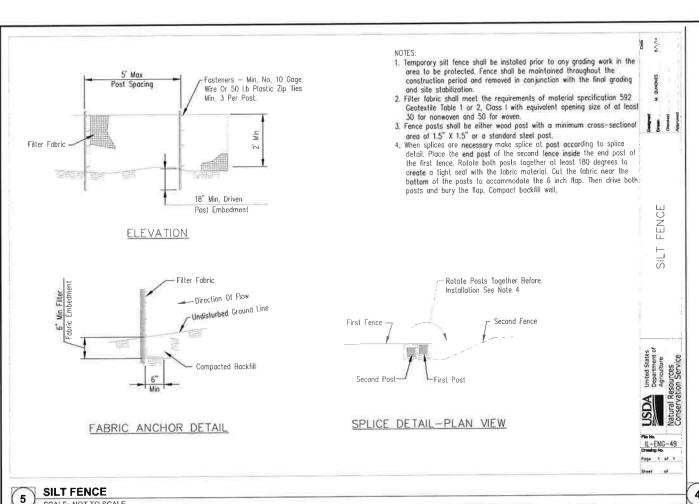

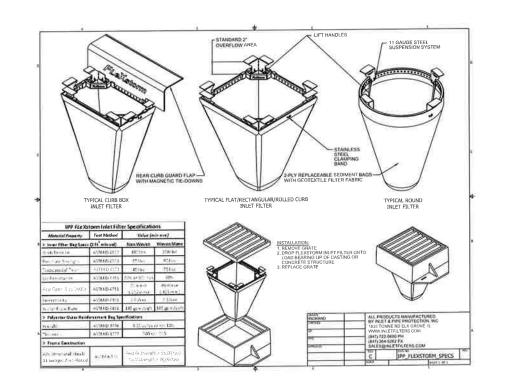






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INLET PROTECTION 4 SCALE: NOT TO SCALE





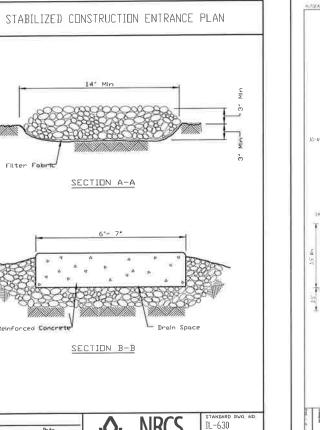

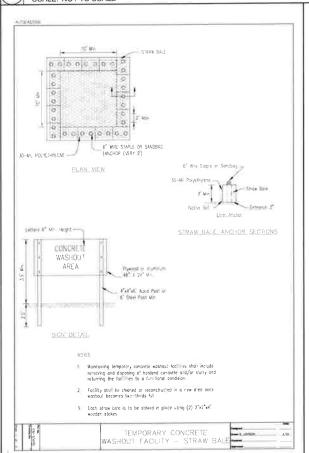MAJOR MODIFICATION (REVISED SITE PLAN)

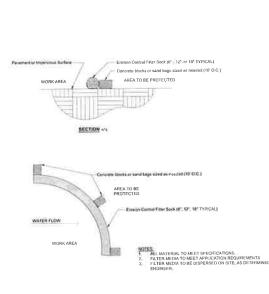City of West Des Moines

Law Enforcement Center Garage Conversion & HVAC Improvements

250 Mills Civic Pkwv West Des Moines, IA 50265

DATE:	01/19/2023
DESIGNED:	TWA
DRAWN:	TWA
REVIEWED:	LMT

FIELD BOOK NO.:

EROSION CONTROL DETAILS

C3.1

EROSION CONTROL FILTER SOCK 1 SCALE: NOT TO SCALE

Reinforced Concrete

SECTION A-A

SECTION B-B

CONCRETE WASH OUT FACILITY 2) SCALE: NOT TO SCALE

PROJECT NO.: 0221006.00

and CLOSS compaction.

3.Any drainage facilities required because of washing shall be constructed according to nanufacturers specifications.

4.If wash rocks are used they shall be installed according to the manufacturer's specifications

IL-630

10' Mir oarse Aggregate Positive Drainage Must Extend Full Width Of Ingress And Egress
Operation. To Sealment Trapping Device. PLAN VIEW Existing Ground SIDE ELEVATION

STABILIZED CONSTRUCTION ENTRANCE PLAN

(Optional)

NOTES:

1 Filter fabric shall meet the requirements of naterial specification
592 GEDTEXTILE, Table J of ZIIClass IV or and shall be placed
over the cleared area prior to the placing of rock.


2.Rock or reclaimed concrete shall meet one of the following IDDT coarse
aggregate gradation, CA-1, CA-2, CA-3 or CA-4 and be placed according
to construction specification 25 ROCKFILL using placement Method 1


STABILIZED CONSTRUCTION ENTRANCE

SCALE: NOT TO SCALE

SCALE: NOT TO SCALE


Existing

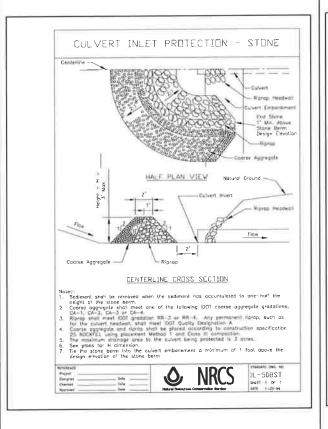


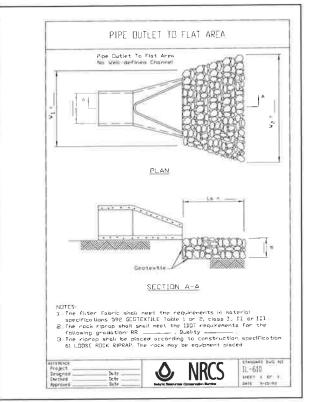


CULVERT INLET PROTECTION SCALENOT TO SCALE

5 PIPE OUTLET TO FLAT AREA SCALENOT TO SCALE

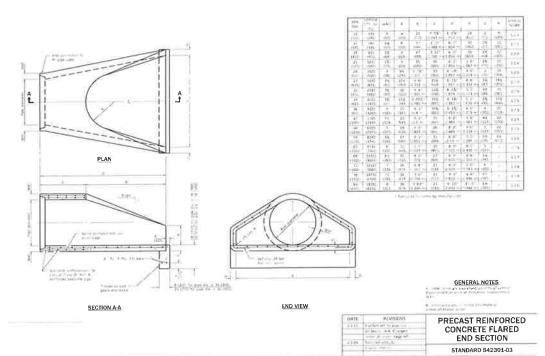

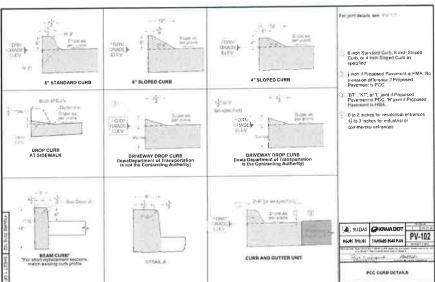

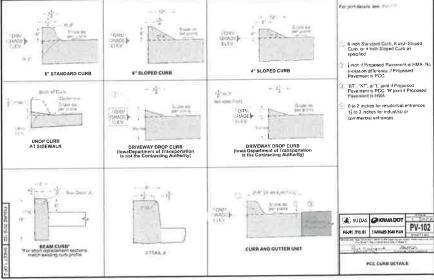



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City of West Des Moines

Law Enforcement Center Garage Conversion & HVAC Improvements

250 Mills Civic Pkwv West Des Moines, IA 50265

DATE:	01/19/2023
DESIGNED:	TWA
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REVIEWED:	LMT
FIELD BOOK NO .:	

SITE DETAILS


C3.2

LIGHT DUTY P.C. CONCRETE PAVEMENT SCALE: NOT TO SCALE

NO 6 X 30" TIE BARS TRANSVERSE CONTRACTION JOINT LONGITUDINAL SAWED JOINT HDT POURED JOINT TRANSVERSE EXPANSION JOINT

LONGITUDINAL CONSTRUCTION JOINT (TIE BAR GROUTED IN PLACE)

HOT POURED JOINT SEALER

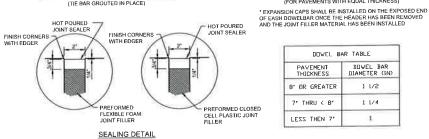

DOWEL BAR TABLE PAVEMENT THICKNESS B' OR GREATER 7' THRU < 8' LESS THEN 7'

(FOR PAVEMENTS WITH EQUAL THICKNESS)

1 1/2 1 1/4

2 PAVEMENT JOINTS SCALE: NOT TO SCALE

3 CURB AND GUTTER

SCALE: NOT TO SCALE

P.C. CONCRETE PAVEMENT, 6"


6 x 6 - W2.9 X W2.9 WWF @ MIDPOINT
OF CONCRETE THICKNESS AGGREGATE BASE COURSE, TYPE B, 4°


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FLARED END SECTION

SCALE: NOT TO SCALE



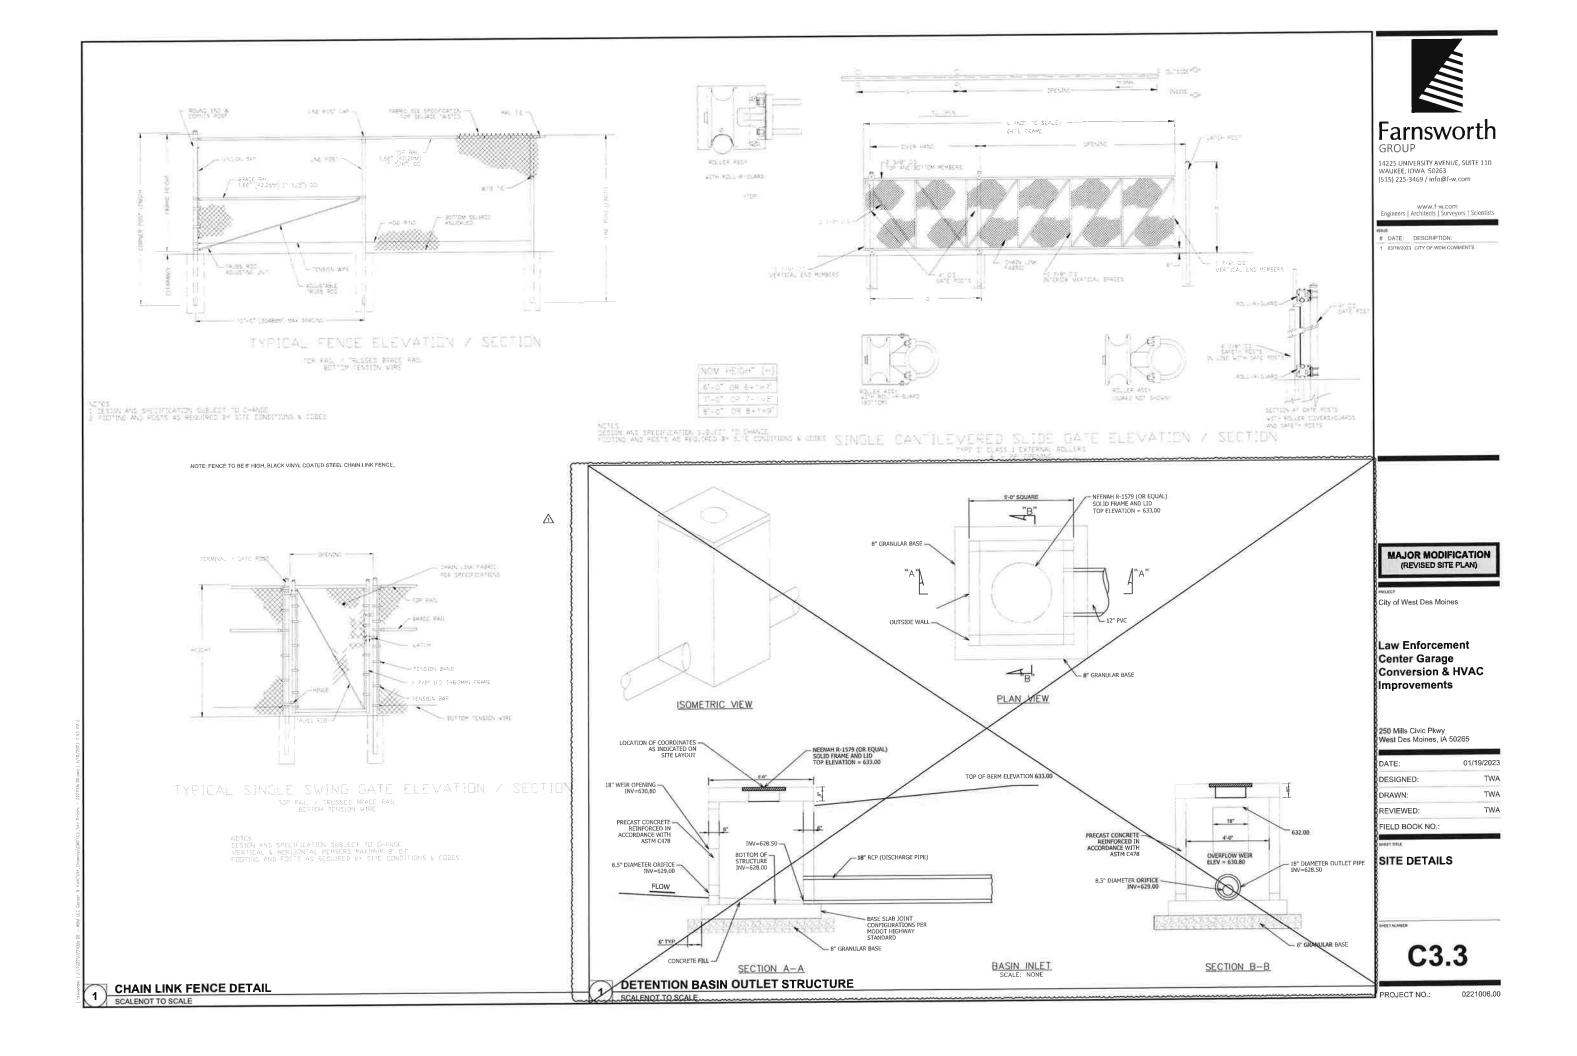

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MAJOR MODIFICATION (REVISED SITE PLAN)

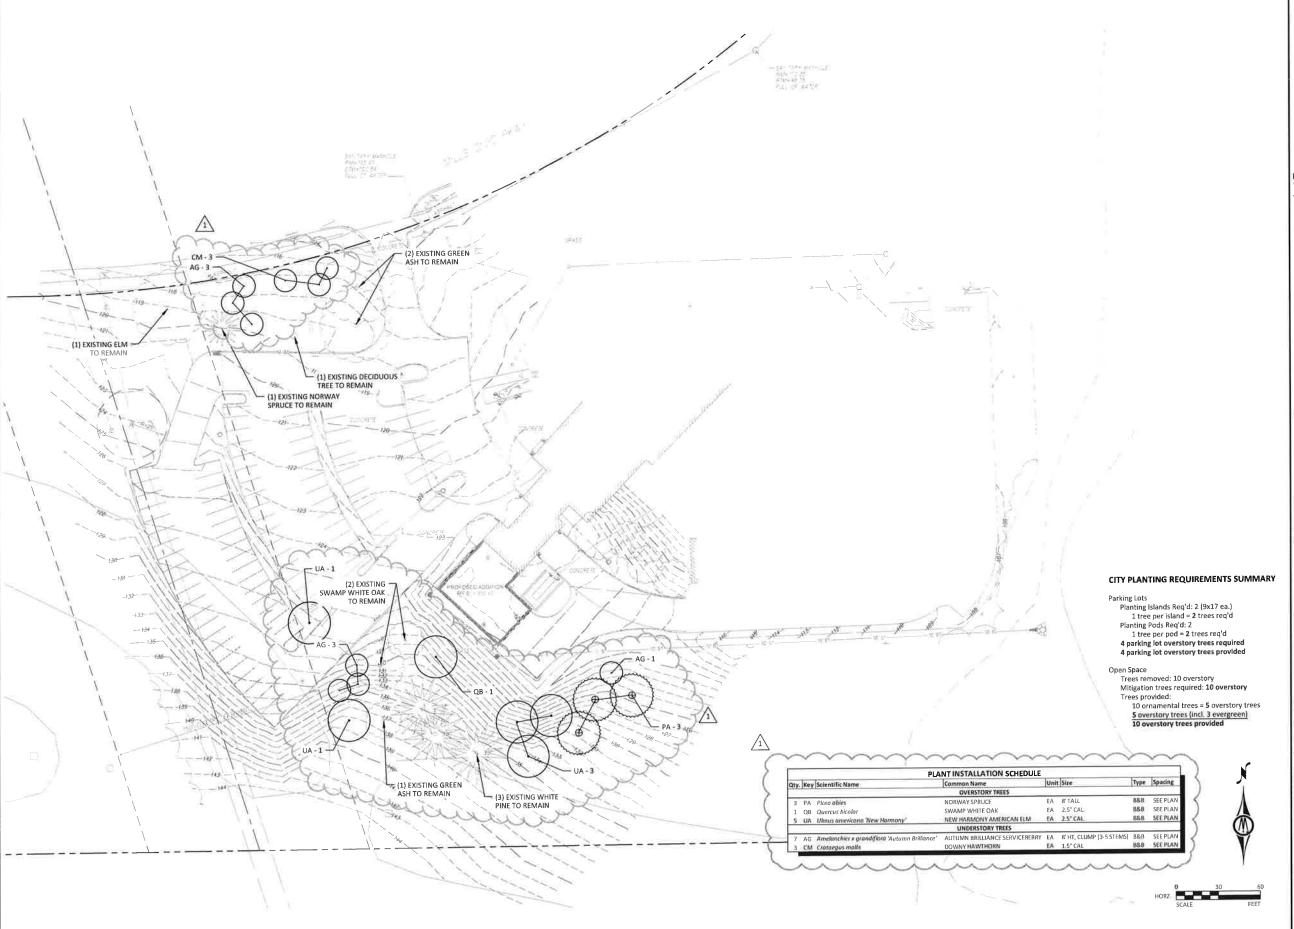City of West Des Moines

Law Enforcement Center Garage Conversion & HVAC Improvements

250 Mills Civic Pkwy West Des Moines, IA 50265

DATE:	03/10/20
DESIGNED:	N
DRAWN:	N
REVIEWED:	
EVEL B DOOK NO	

PLANTING PLAN


L1.1

PROJECT NO.:

0221006,00

- 1. ALL PLANTINGS TO FOLLOW 2023 IOWA STATEWIDE URBAN DESIGN AND SPECIFICATIONS (SUDAS).
- 2. MASTER PLANT SCHEDULE: ALL TREES ARE LISTED IN THE MASTER PLANT SCHEDULE, IF THERE IS A CONFLICT BETWEEN THE QUANTITIES SHOWN ON THE DRAWINGS AND THE QUANTITIES SHOWN IN THE PLANT SCHEDULE, THE PLAN QUANTITIES SHALL PREVAIL.
- 3. PLANTING LAYOUT: STAKE ALL TREE LOCATIONS AND OBTAIN APPROVAL OF THE OWNER'S REPRESENTATIVE PRIOR TO PLANTING,
- 4. TREES LOCATED IN TURF AREAS SHALL BE MULCHED TO 18 INCHES FROM TRUNK (36" DIA RING) IN ALL DIRECTIONS AND INSTALLED TO A DEPTH OF
- 5. SEE NOTES ON CO.1 REGARDING TURF RESTORATION REQUIREMENTS.



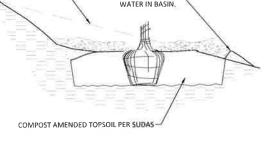

SOIL RIDGE TO HOLD-

-ON 2:1 SLOPES OR GREATER, DO NOT CONSTRUCT



-DO NOT CUT LEADER

NYLON STRAP GUY ASSEMBLY

STEEL POST NOTCHED OR DRILLED FOR GUY WIRE, -USE 3 GUY ASSEMBLIES FOR **EVERGREENS**

TREE WRAP ON DECIDUOUS TREES

haidade

ZONE 3 ROOT PROTECTION VARIES PER TREE SIZE

EXTENDS FROM DRIPLINE TO DRIPLINE

ROOT FLARE OF TREE -3" MULCH DEPTH, PULL BACK 4" FROM TREE TRUNK -FINISH GRADE

COMPOST AMENDED TOPSOIL PER SUDAS

-RESTRICTED ZONE

BRANCH PROTECTION PROTECT LOWER BRANCHES OF

IF ANY PRUNING IS NEEDED

REMOVE TOP 1/3 OF WIRE BASKET AFTER TREE IS IN THE PIT REMOVE TWINE, & PULL BURLAP FROM TREE TRUNK

NOTE: SET TOP OF ROOT BALL 1" TO 2" ABOVE SURROUNDING

FINISH GRADE

TREE PLANTING ON SLOPES SCALE: N.T.S



EXISTING GRADE

- 1. ALL TREES TO BE PROTECTED AND PRESERVED SHALL BE PER DETAIL, GROUPING OF MORE THAN ONE TREE MAY OCCUR.
- 2: TREES TO BE PROTECTED AND PRESERVED SHALL BE IDENTIFIED
- 3. TO PREVENT TREE ROOT SMOTHERING. SOIL STOCKPILES. SUPPLIES, EQUIPMENT OR ANY OTHER MATERIAL SHALL NOT BE PLACED OR STORED WITHIN A TREE DRIP LINE OR WITHIN 15 FEET OF A TREE TRUNK, WHICHEVER IS GREATER.
- 4. TREE ROOTS SHALL NOT BE CUT UNLESS CUTTING IS
- TREE CANOPY, CONTACT OWNER 5. TRENCHES SHALL BE HAND DUG WITHIN THE DRIP LINE IN AREAS WHERE ROOTS TWO INCHES IN DIAMETER AND GREATER ARE PRESENT, OR WHEN IN CLOSE PROXIMITY TO LOW BRANCHING TREES. WHENEVER POSSIBLE, ROOTS TWO INCHES OR GREATER
 IN DIAMETER SHALL BE TUNNELED OR BORED UNDER AND SHALL BE COVERED TO PREVENT DEHYDRATION.
 - 6. WHEN ROOT CUTTING IS UNAVOIDABLE, A CLEAN SHARP CUT SHALL BE MADE TO AVOID SHREDDING OR SMASHING. ROOT
 CUTS SHOULD BE MADE BACK TO A LATERAL ROOT, WHENEVER POSSIBLE, TREE ROOTS SHOULD BE CUT BETWEEN LATE FALL AND BUD OPENING, WHEN ROOT ENERGY SUPPLIES ARE HIGH AND CONDITIONS ARE LEAST FAVORABLE FOR DISEASE CAUSING AGENTS. EXPOSED ROOTS SHALL BE COVERED IMMEDIATELY TO PREVENT DEHYDRATION. ROOTS SHALL BE COVERED WITH SOIL OR BURLAP AND KEPT MOIST.

- 7. WATERING OF PROTECTED TREES IN WHICH ROOTS WERE CUT SHALL BE PROVIDED BY THE CONTRACTOR.
- 8. AUGER TUNNELING RATHER THAN TRENCHING SHOULD BE USED FOR UTILITY PLACEMENT WITHIN DRIP LINE OF TREE,
- 9. FENCING MATERIAL SHALL ENCIRCLE ANY TREE WHOSE OUTER DRIP LINE EDGE IS WITHIN 20 FEET OF ANY CONSTRUCTION ACTIVITIES.
- 10. FENCING MATERIAL SHALL BE BRIGHT, CONTRASTING COLOR, DURABLE, AND A MINIMUM OF FOUR FEET IN
- 11. FENCING MATERIAL SHALL BE SET AT THE DRIP LINE OR 15 FEET FROM TREE TRUNK, WHICHEVER IS GREATER, AND MAINTAINED IN AN UPRIGHT POSITION THROUGHOUT THE DURATION OF CONSTRUCTION ACTIVITIES.
- 12. ANY GRADE CHANGES (SUCH AS THE REMOVAL OF TOPSOIL OR ADDITION OF FILL MATERIAL) WITHIN THE DRIP LINE SHOULD BE AVOIDED FOR EXISTING TREES TO REMAIN. RETAINING WALLS AND TREE WELLS ARE ACCEPTABLE ONLY WHEN CONSTRUCTED PRIOR TO GRADE



MAJOR MODIFICATION (REVISED SITE PLAN)

City of West Des Moines

Law Enforcement Center Garage Conversion & HVAC **Improvements**

250 Mills Civic Pkwy West Des Moines, IA 50265

	DATE:	03/10/20
	DESIGNED:	N
	DRAWN:	N
	REVIEWED:	8
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FIELD BOOK NO .:

PLANTING DETAILS

EXISTING TREE PROTECTION


SCALE: N.T.S.

ZONE 2 TRUNK PROTECTION

REQUIRED IF WHEELED
CONSTRUCTION EQUIPMENT

INVOLVED WITHIN 10' OR LESS

PROVIDE SNOW FENCING OR EQUAL AT DRIPLINE (MIN.)

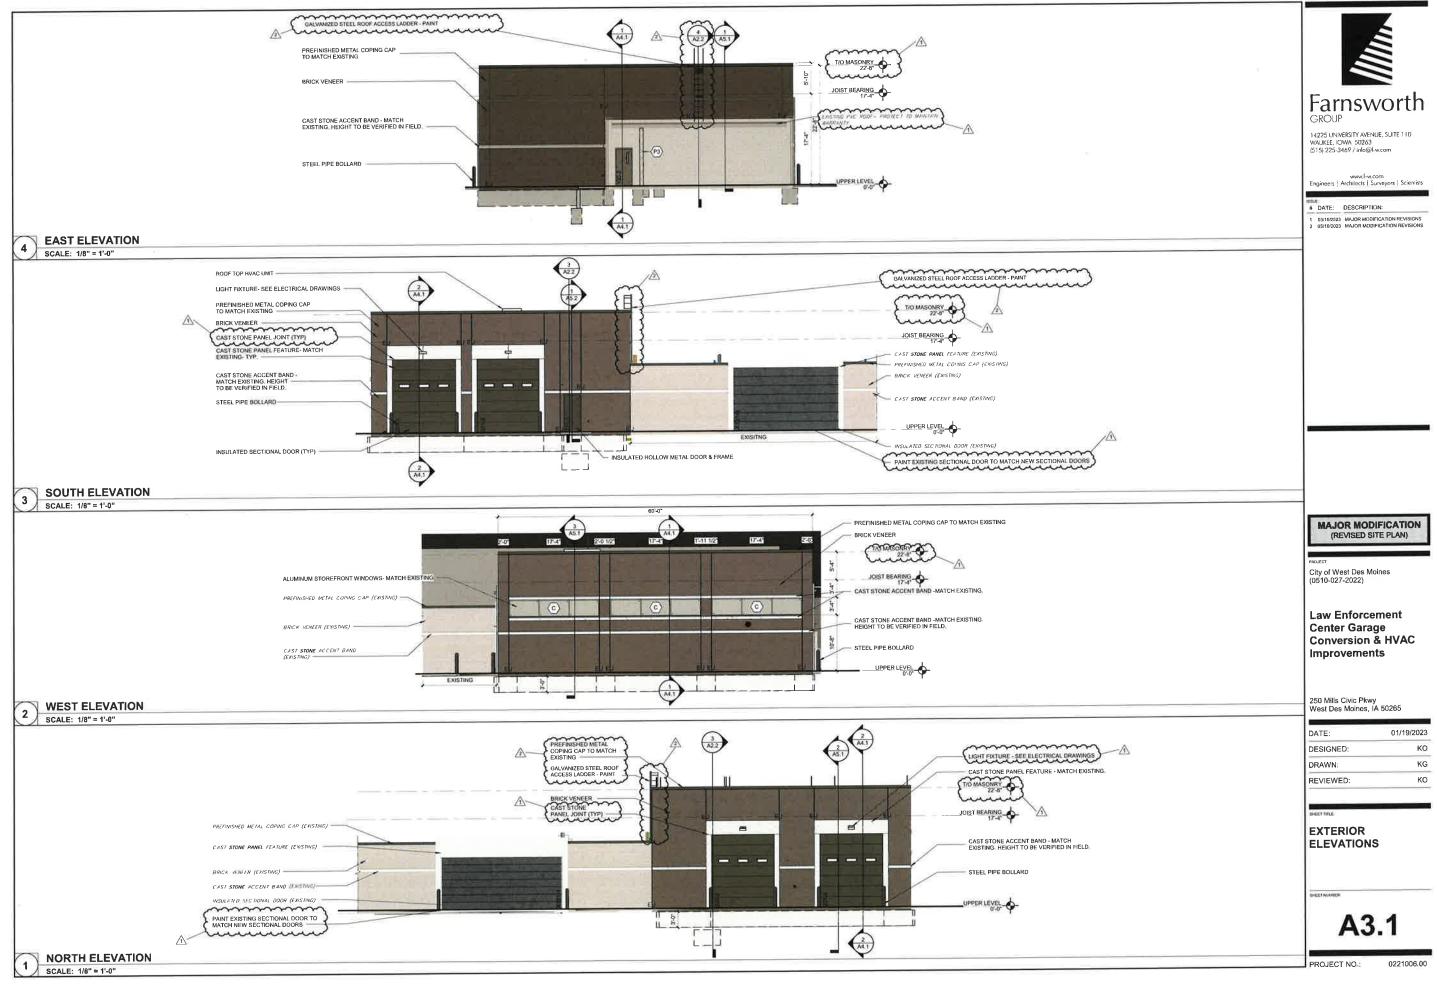

SECT A TOTAL